



COMMITTEE OF ADJUSTMENT NOTICE OF PUBLIC HEARING APPLICATION NO. A-040-2024

TAKE NOTICE that an application has been received by the Town of Innisfil from **Wilfreda Eisses**, applicant, on behalf of **Kevin Arnold**, **Owner**, for a minor variance from Zoning By-law 080-13, pursuant to Section 45 of the *Planning Act*, R.S.O. 1990, c. P.13, as amended.

The subject property is described legally as CON 9 PT LOT 15 PLAN M261 LOT 59, known municipally as 2258 Richardson Street and is zoned "Environmental Protection (EP)".

The applicant is proposing to construct an addition to an existing accessory structure. The applicant is seeking relief from Section 3.27(a) of the Zoning By-law for the expansion of a legally existing, non-conforming use.

The Committee of Adjustment for the Town of Innisfil will consider this application in person at Town Hall and virtually through Zoom on **Thursday**, **October 17**, **2024**, **at 6:30 PM**.

To participate in the hearing and/or provide comments, you must register by following the link below or scanning the above QR code: https://innisfil.ca/en/building-and-development/committee-of-adjustment-hearings.aspx

Requests can also be submitted in writing to: Town of Innisfil Committee of Adjustment, 2101 Innisfil Beach Road, Innisfil, Ontario, L9S 1A1 or by email to planning@innisfil.ca.


If you wish to receive a copy of the decision of the Committee of Adjustment in respect of the proposed minor variance, you must make a written request to the Secretary-Treasurer of the Committee of Adjustment by way of email or regular mail. The Notice of Decision will also explain the process for appealing a decision to the Ontario Lands Tribunal.




Additional information relating to the proposed application is available on the Town of Innisfil website. Accessible formats are available on request, to support participation in all aspects of the feedback process. To request an alternate format please contact Planning Services at planning@innisfil.ca.

Dated: October 1, 2024

Toomaj Haghshenas, Secretary-Treasurer thaghshenas@innisfil.ca 705-436-3710 ext. 3316

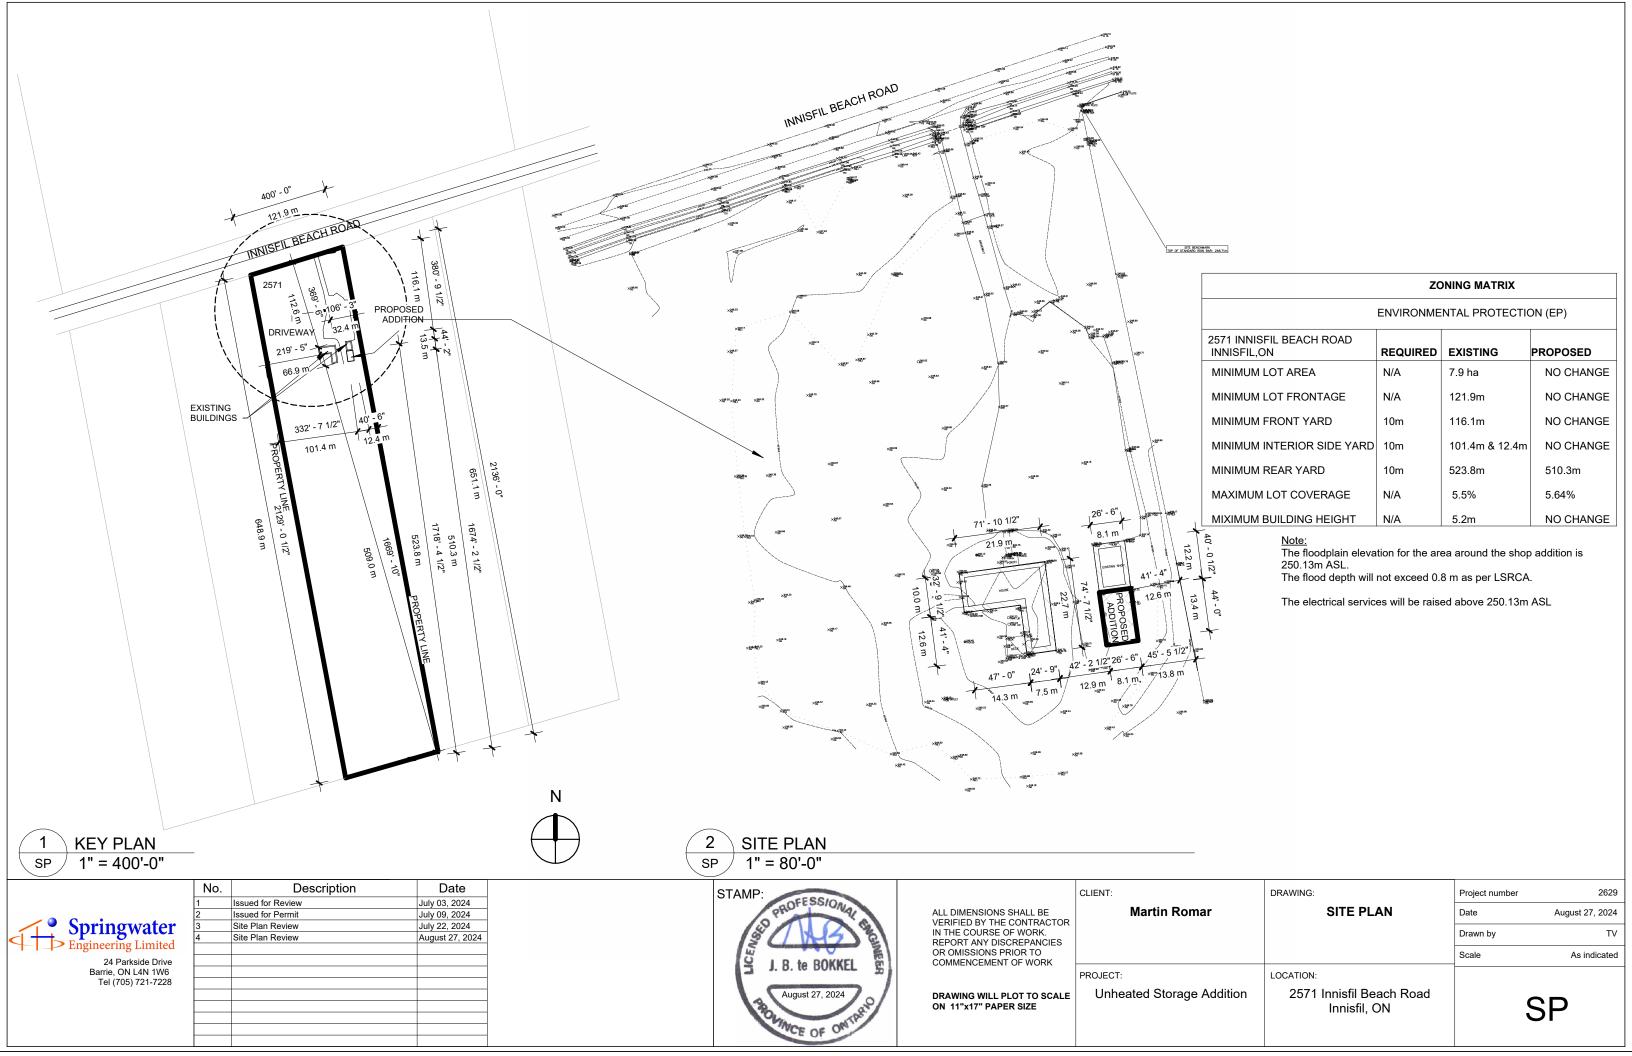

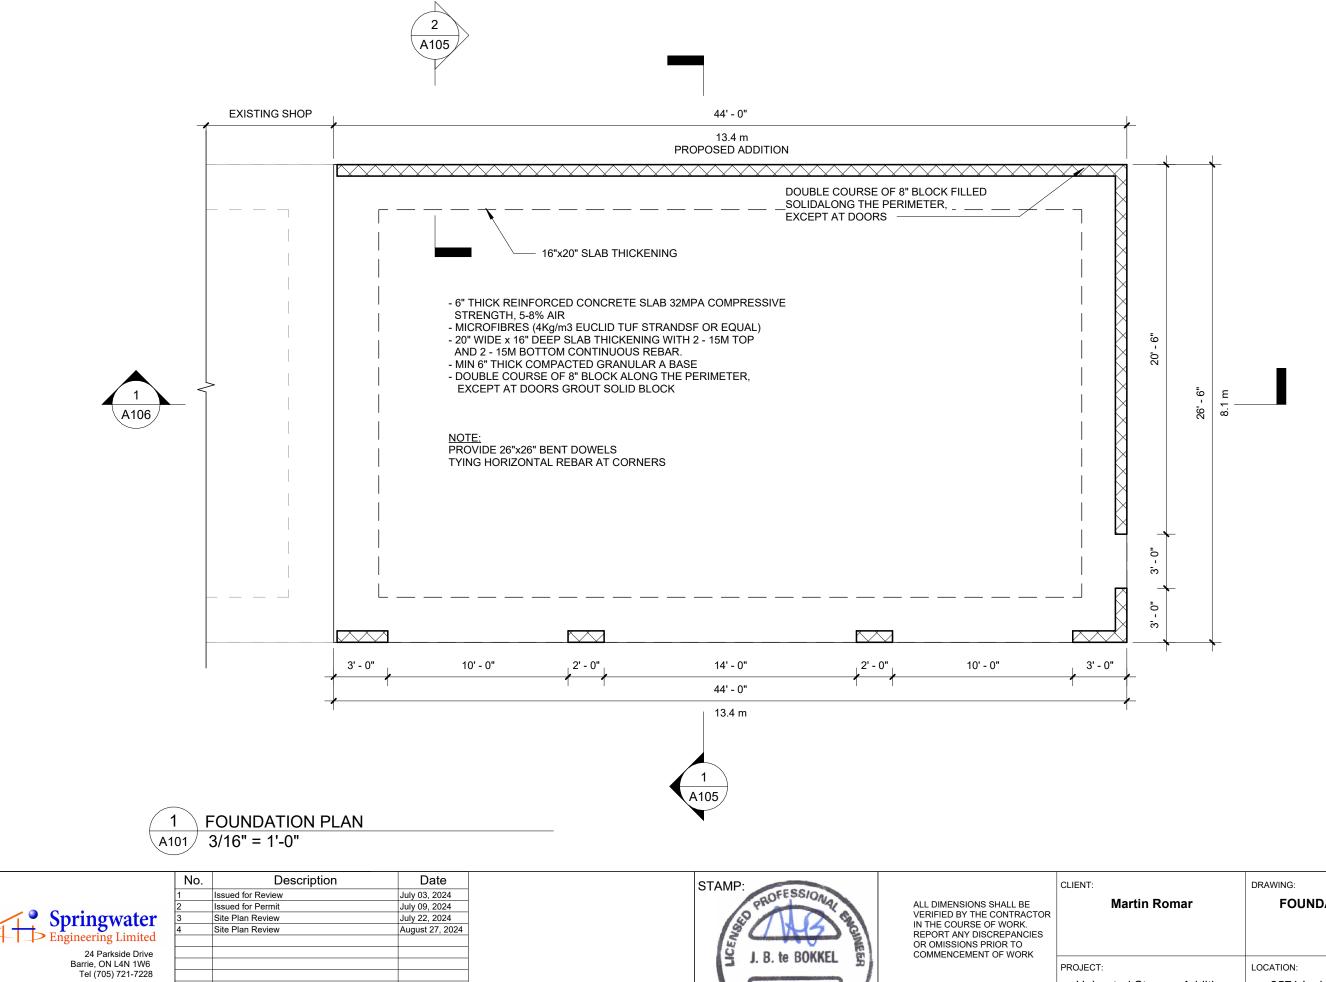


1	Issued for Review	July 03, 2024
2	Issued for Permit	July 09, 2024
3	Site Plan Review	July 22, 2024
4	Site Plan Review	August 27, 2024



DRAWING WILL PLOT TO SCALE
ON 11"x17" PAPER SIZE

LIENT:	DRAWING:	Project number	2629
Martin Romar	FOUNDATION PLAN	Date	August 27, 2024
		Drawn by	TV
		Scale	3/16" = 1'-0"
ROJECT:	LOCATION:		
Unheated Storage Addition	2571 Innisfil Beach Road Innisfil, ON	<i> </i>	A101

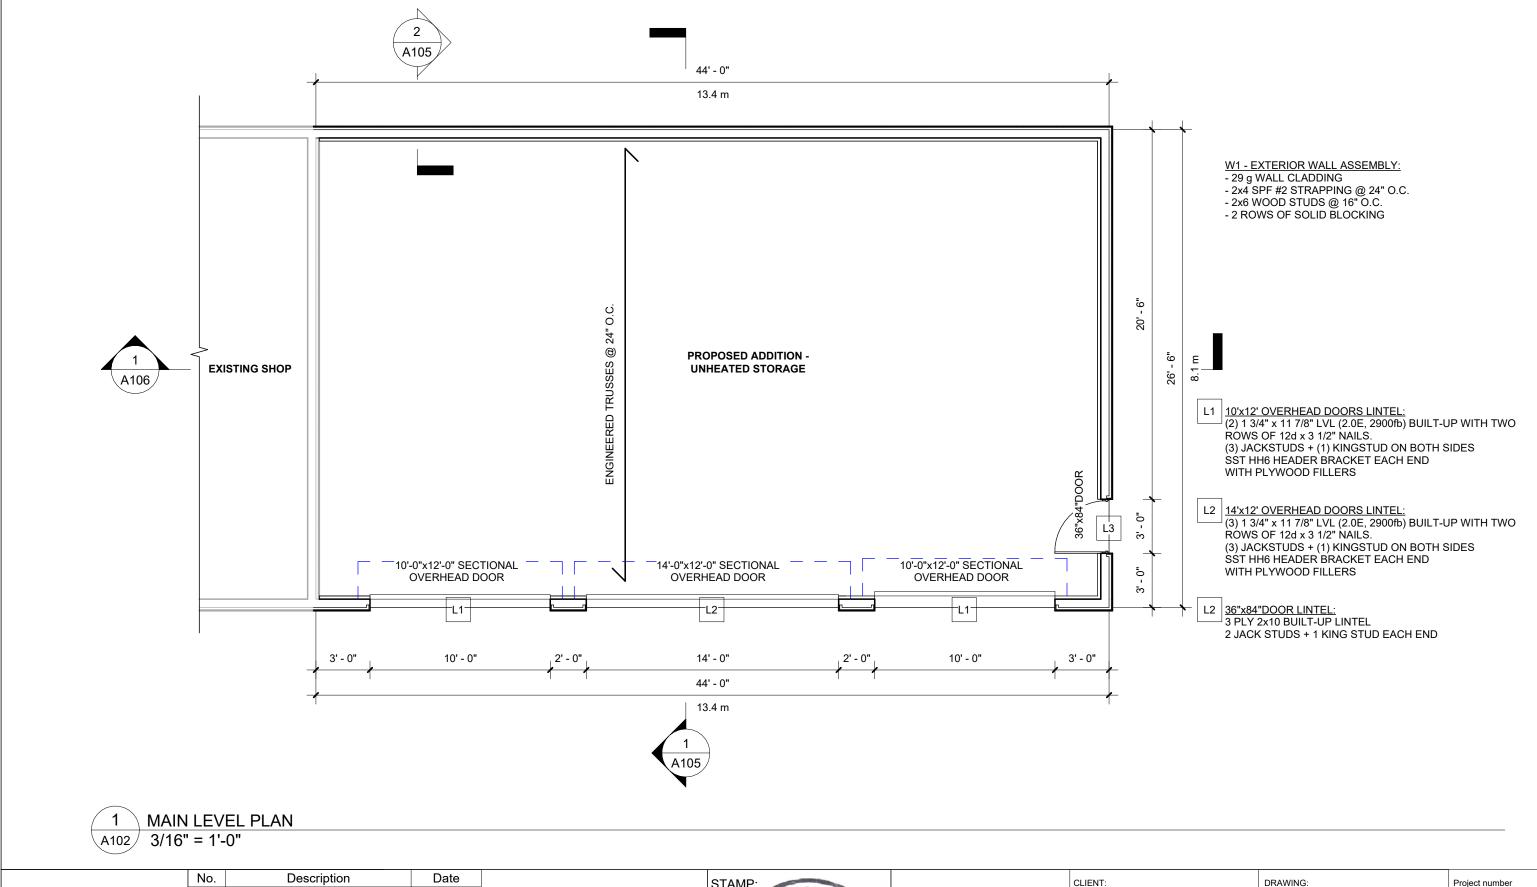

Springwater
Engineering Limited

Issued for Permit July 09, 2024 Site Plan Review July 22, 2024 Site Plan Review August 27, 2024 24 Parkside Drive Barrie, ON L4N 1W6 Tel (705) 721-7228

Issued for Review

July 03, 2024

STAMP: J. B. te BOKKEL August 27, 2024 INCE OF ONTP


ALL DIMENSIONS SHALL BE VERIFIED BY THE CONTRACTOR IN THE COURSE OF WORK. REPORT ANY DISCREPANCIES OR OMISSIONS PRIOR TO COMMENCEMENT OF WORK

DRAWING WILL PLOT TO SCALE ON 11"x17" PAPER SIZE


IT:	DRAWING:	Project number	2629
Martin Romar	MAIN LEVEL PLAN	Date	August 27, 2024
		Drawn by	TV
		Scale	3/16" = 1'-0"
ECT:	I OCATION:		

PROJECT **Unheated Storage Addition** 2571 Innisfil Beach Road Innisfil, ON

A102

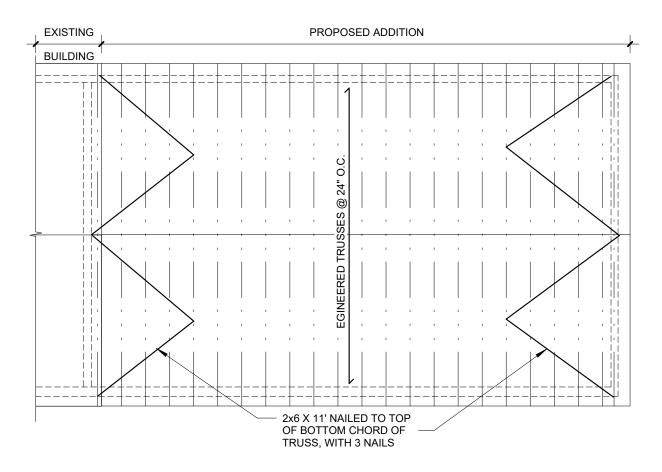


1 ROOF PLAN A103 1/8" = 1'-0"

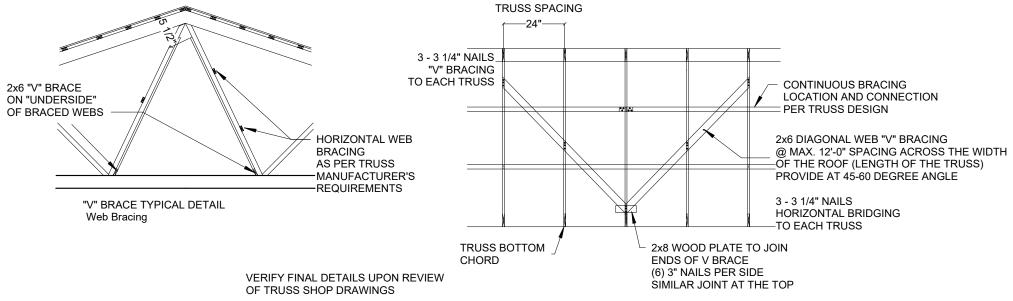

2 WEB BRACING DETAIL N.T.S.

Springwater Engineering Limited
24 Parkside Drive Barrie, ON L4N 1W6 Tel (705) 721-7228

No.	Description	Date
1	Issued for Review	July 03, 2024
2	Issued for Permit	July 09, 2024
3	Site Plan Review	July 22, 2024
4	Site Plan Review	August 27, 2024

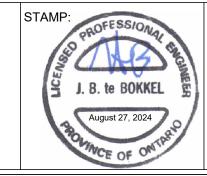

ALL DIMENSIONS SHALL BE
VERIFIED BY THE CONTRACTOR
IN THE COURSE OF WORK.
REPORT ANY DISCREPANCIES
OR OMISSIONS PRIOR TO
COMMENCEMENT OF WORK

DRAWING WILL PLOT TO SC	ALI
ON 11"x17" PAPER SIZE	


Unheated Storage Addition


CLIENT:	DRAWING:	Draiget number	2629
CLIENT.	DRAWING.	Project number	2029
Martin Romar	ROOF PLAN AND WEB	Date	August 27, 2024
	BRACING DETAIL	Drawn by	TV
		Scale	N.T.S.
PROJECT:	LOCATION:		

2571 Innisfil Beach Road


Innisfil, ON

A103

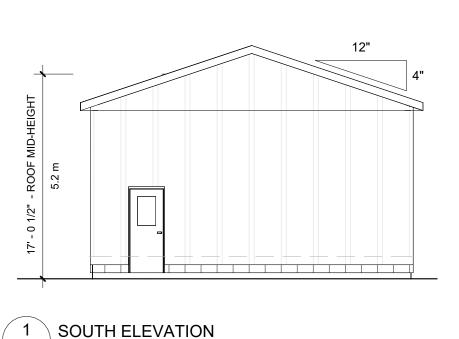

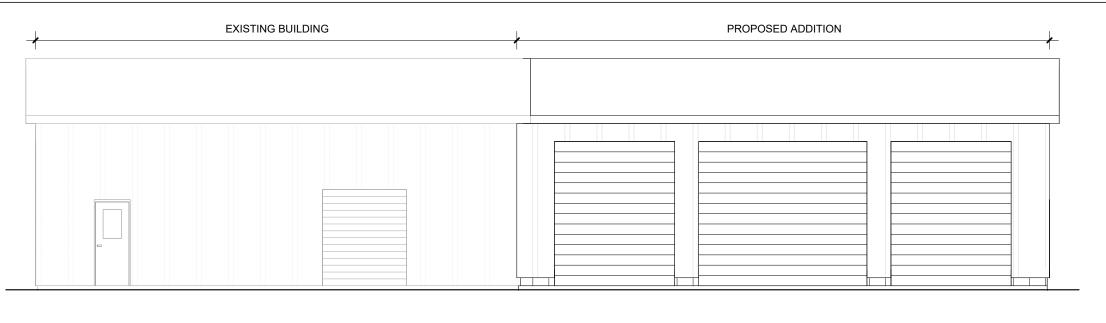

SOUTH ELEVATION 1/8" = 1'-0" 2 WEST ELEVATION A104 1/8" = 1'-0"

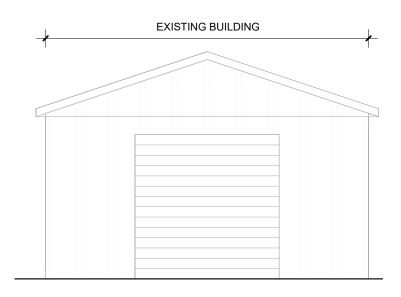

No.

44'-0" EXISTING BUILDING
PROPOSED ADDITION

3 NORTH ELEVATION A104 1/8" = 1'-0" 4 EAST ELEVATION A104 1/8" = 1'-0"


Date

4	Springwater Engineering Limited
	24 Parkside Drive Barrie, ON L4N 1W6 Tel (705) 721-7228

A104

1	Issued for Review	July 03, 2024
2	Issued for Permit	July 09, 2024
3	Site Plan Review	July 22, 2024
4	Site Plan Review	August 27, 2024


Description

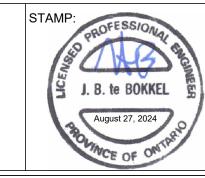



ALL DIMENSIONS SHALL BE
VERIFIED BY THE CONTRACTOR
IN THE COURSE OF WORK.
REPORT ANY DISCREPANCIES
OR OMISSIONS PRIOR TO
COMMENCEMENT OF WORK

D	R	AWING WILL PLOT TO S	CALE
0	N	11"x17" PAPER SIZE	

CLIEN I:	DRAWING:	Project number	2629
Martin Romar	ELEVATIONS	Date	August 27, 2024
		Drawn by	TV
		Scale	1/8" = 1'-0"
PROJECT:	LOCATION:		
Unheated Storage Addition	2571 Innisfil Beach Road Innisfil, ON	Α	104

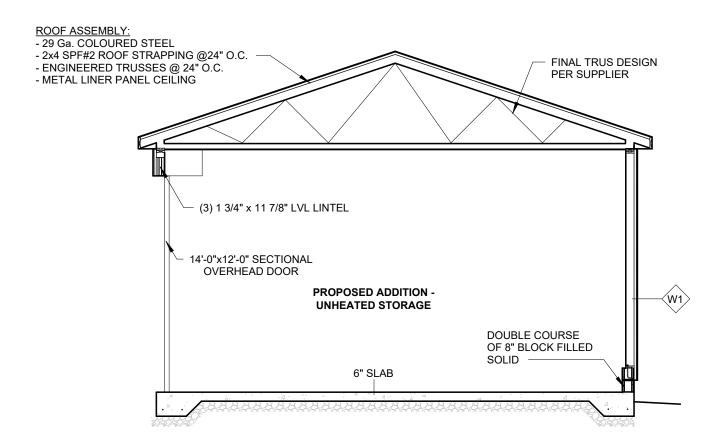


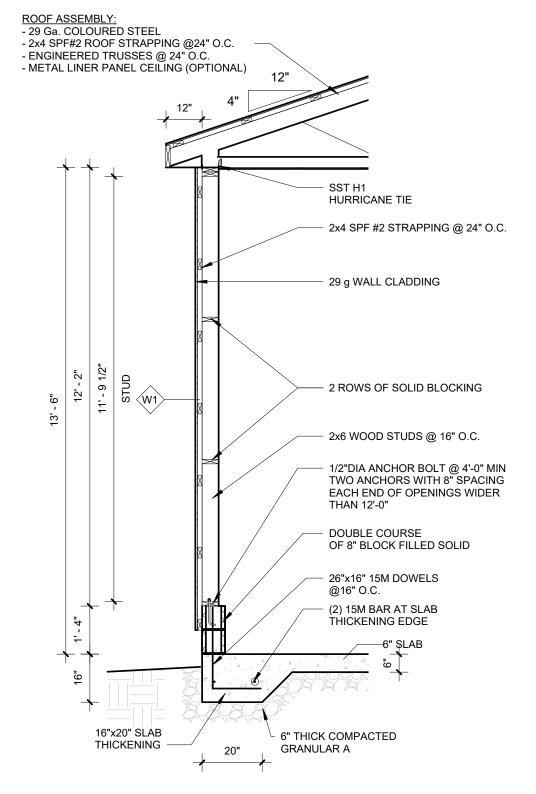

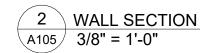

1 SECTION 1 A105 3/16" = 1'-0"


	No.	Description	Date
	1	Issued for Review	July 03, 2024
	2	Issued for Permit	July 09, 2024
Springwater	3	Site Plan Review	July 22, 2024
Springwater Engineering Limited	4	Site Plan Review	August 27, 202
Engineering Limited			
24 Parkside Drive			
Barrie, ON L4N 1W6			
Tel (705) 721-7228			
	1		1

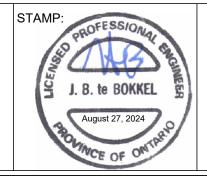

ALL DIMENSIONS SHALL BE
VERIFIED BY THE CONTRACTO
IN THE COURSE OF WORK.
REPORT ANY DISCREPANCIES
OR OMISSIONS PRIOR TO
COMMENCEMENT OF WORK

DRAWING WILL PLOT TO SCALE ON 11"x17" PAPER SIZE

CLIENT:	DRAWING:	Project number 2629
Martin Romar	SECTIONS	Date August 27, 2024
		Drawn by TV
		Scale As indicated
PROJECT:	LOCATION:	
Unheated Storage Addition	2571 Innisfil Beach Road Innisfil, ON	A105

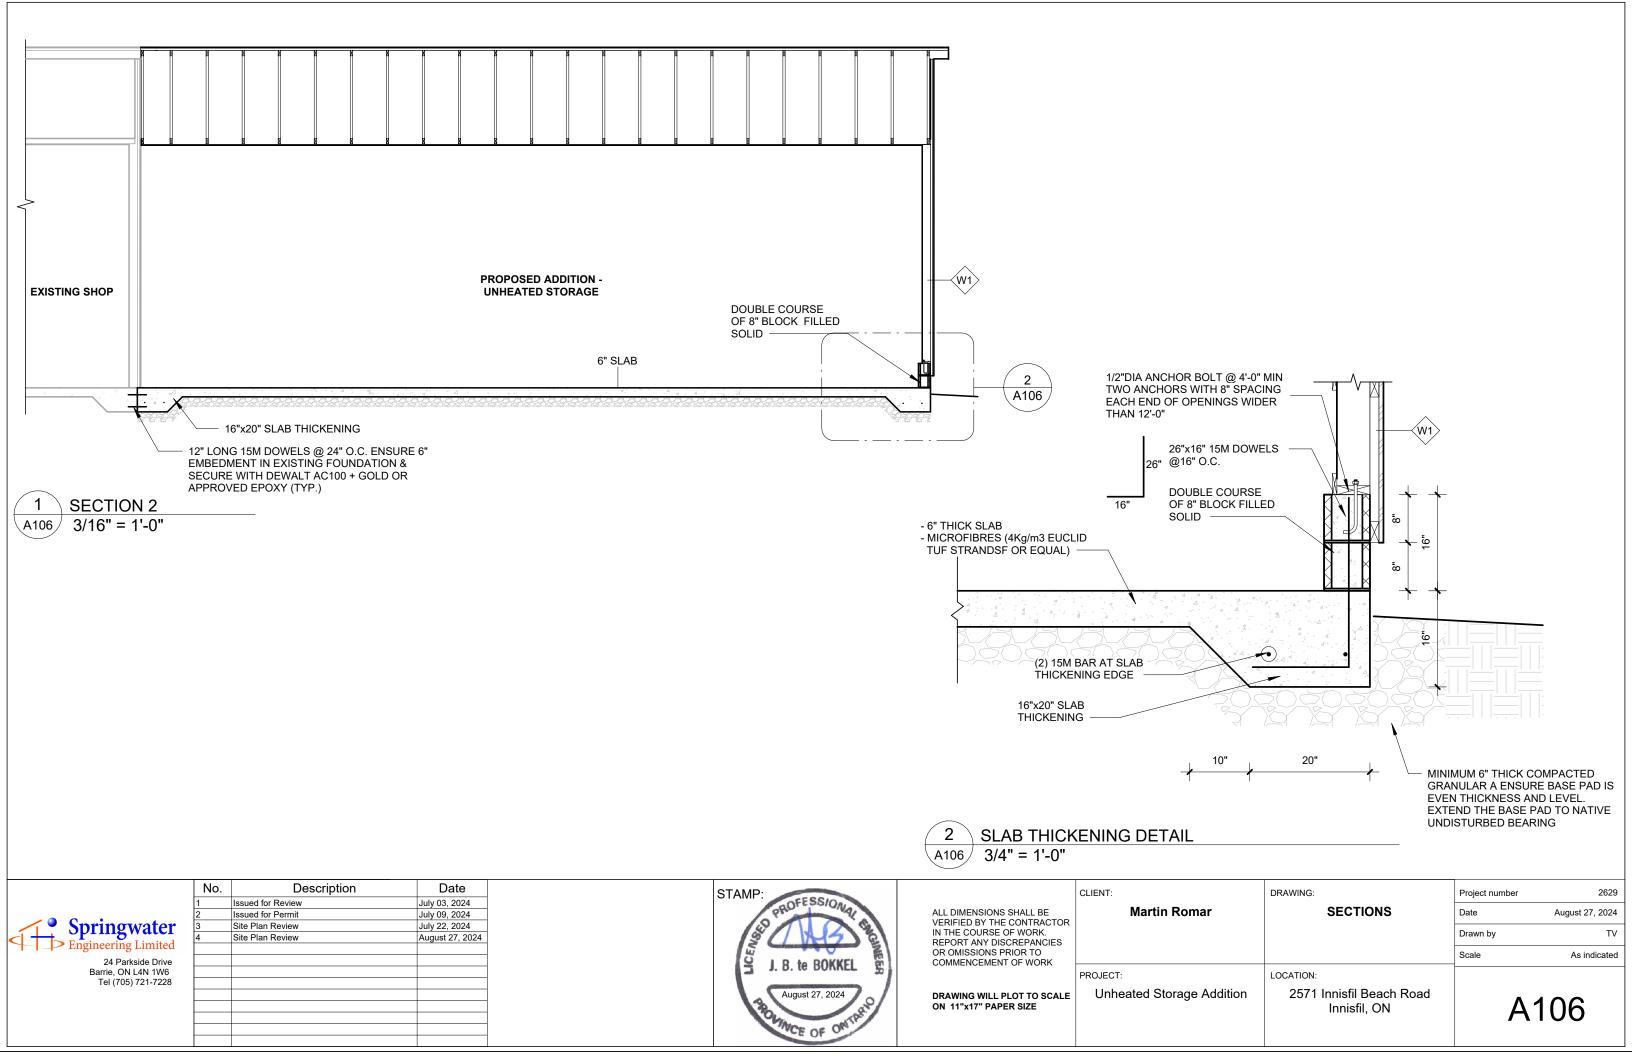

GENERAL NOTES

- THIS DRAWING SET IS THE PROPERTY OF SPRINGWATER ENGINEER AND MAY NOT BE REPRODUCED OR USED WITHOUT THE EXPRESSED WRITTEN CONSENT OF SPRINGWATER ENGINEERING.
- 2. THESE DRAWINGS TO BE READ IN CONJUNCTION WITH CONTRACT DOCUMENTATION, DRAWINGS, GENERAL NOTES AND SPECIFICATIONS PROVIDED BY ALL THE SERVICE PROVIDERS.
- CONTRACTOR TO VERIFY ALL EXISTING CONDITIONS AS REQUIRED TO PERFORM THE WORK. ANY DISCREPANCIES SHALL TO BE REPORTED TO SPRINGWATER ENGINEERING IMMEDIATELY TO OBTAIN CLARIFICATION PRIOR TO COMMENCING WORK.
- 4. DESIGN LOADS ARE NOTED. THEY SHALL NOT BE EXCEEDED DURING CONSTRUCTION. UNLESS SPECIFICALLY NOTED OTHERWISE ON THE DRAWINGS, NO PROVISION HAS BEEN MADE IN THE DESIGN FOR CONDITIONS OCCURRING DURING CONSTRUCTION. THE CONTRACTOR IS TO PROVIDE ALL NECESSARY BRACING AND SHORING REQUIRED FOR STRESSES AND INSTABILITY OCCURRING FROM ANY CAUSE DURING CONSTRUCTION. IT SHALL ALSO BE THE RESPONSIBILITY OF THE CONTRACTOR TO PROVIDE ALL NECESSARY BRACING, SHORING, SHEET PILING OR OTHER TEMPORARY SUPPORTS TO SAFEGUARD ALL EXISTING OR ADJACENT STRUCTURES AFFECTED BY THIS WORK.
- 5. NO SUBSTITUTIONS. CONTRACTOR AGREES TO USE ALL SPECIFIED MATERIALS WITHOUT SUBSTITUTION. NON SPECIFIED MATERIALS MUST BE APPROVED SPRINGWATER ENGINEERING PRIOR TO USE.
- 6. THE CONTRACTOR SHALL BE SOLELY RESPONSIBLE FOR CONSTRUCTION MEANS, METHODS, TECHNIQUES, SEQUENCES, AND PROCEDURES AND FOR CO-ORDINATING THE VARIOUS PARTS OF THE WORK.
- 7. TYPICAL STRUCTURAL DETAILS ARE SHOWN ON DRAWINGS. IF DETAILS DIFFER ON OTHER DRAWINGS, CONTACT THE ENGINEER OF RECORD FOR CLARIFICATION.
- 8. ALL WORK SHALL BE CARRIED OUT IN ACCORDANCE WITH THE REQUIREMENTS OF THE ONTARIO BUILDING CODE 2012 (OBC 2012) AND THE OCCUPATIONAL HEALTH AND SAFETY ACT.
- 9. PROVIDE ÁLL ACCESSORY ITEMS OR MATERIALS, SUCH AS BRACKETS, CLEATS, UNDERLAYS, OVERLAYS, CONNECTORS, FASTENERS, COVER PLATES, SEALANTS, LUBRICANTS, CLEANERS, BONDING AGENTS, AND SIMILAR ITEMS, WHETHER SPECIFIED OR NOT, SO THAT THE WORK IS COMPLETE AND WILL PERFORM AS REQUIRED.
- 10. CONTRACTOR SHALL CONTACT ALL LOCAL UTILITIES AND SERVICES PRIOR TO EXCAVATION AND OBTAIN PROPER LOCATES.
- 11. OWNER/CONTRACTOR WILL BE RESPONSIBLE FOR OBTAINING BUILDING PERMITS, APPROVALS FROM LOCAL BUILDING AUTHORITIES PRIOR TO COMMENCING ANY WORK.
- 12. ALL STANDARDS REFERRED IN THE DRAWINGS AND SPECIFICATIONS SHALL BE THE LATEST LEGALIZED VERSIONS.
- 13. DO NOT PROCEED WITH UNCERTAINTY. CONTACT ENGINEER OF RECORD IF ANY CLARIFICATION REQUIRED.
- 14. SPRINGWATER ENGINEERING LIMITED'S SCOPE IS LIMITED TO STRUCTURAL DESIGN OF ITEMS SPECIFIED HERE ONLY.

DESIGN LOADS:

- 1. SNOW LOADS CLIMATIC DATA BASED ON BARRIE, ONTARIO
- Ss = 2.5 KPA

Sr = 0.40 KPA

Cb = 0.55

WOOD FRAMING NOTES:

- 1. WOOD CONSTRUCTION SHALL CONFORM TO ONTARIO BUILDING CODE 2012, PART 9 UNLESS NOTED OTHERWISE.
- LUMBER: UNLESS OTHERWISE NOTED TO BE SPRUCE-PINE-FIR (SPF), GRADE NO.1/NO.2, CONFORMING TO CSA STANDARD 0141 WITH A MAXIMUM MOISTURE CONTENT OF 19 % AT THE TIME OF INSTALLATION. ALL LUMBER SHALL BEAR THE GRADING STAMP OF AN AGENCY APPROVED BY THE CANADIAN LUMBER STANDARDS ADMINISTRATION BOARD.
- 3. COMPLY WITH THE REQUIREMENTS OF ONTARIO BUILDING CODE FOR SUB-FLOORING IN TABLE 9.23.14.A, ROOF SHEATHING IN TABLE 9.23.15.A, AND WALL SHEATHING IN TABLE 9.23.16.A.
- 4. NAILS, SPIKES, AND STAPLES: TO CSA STANDARD B111; GALVANIZED FOR EXTERIOR WORK, OR HIGHLY HUMID AREAS AND FOR TREATED LUMBER; PLAIN ELSEWHERE. NAILING OF FRAMING UNLESS OTHERWISE NOTED, SHALL CONFORM TO TABLES 9.23.3 A, B, AND 9.23.13 A IN THE ONTARIO BUILDING CODE.
- 5. ROUGH HARDWARE: BOLTS, NUTS, WASHERS, LAGS, PINS, SCREWS, ALL TO BE HOT DIP GALVANIZED IF EXPOSED TO EXTERIOR USE.
- 6. WOOD PRESERVATIVES (PRESSURE TREATED): WHERE REQUIRED TO CONFORM TO CSA STANDARD 080-M. ALL WOOD PRODUCTS BEARING ON CONCRETE OR MASONRY AT OR BELOW GRADE TO BE PRESSURE TREATED OR BE PROTECTED WITH A MINIMUM 0.05 POLYETHYLENE VAPOUR BARRIER, ROLL ROOFING, OR APPROVED EQUIVALENT.
- 7. ALL WOOD PRODUCT EXPOSED DIRECTLY TO SOIL SHALL BE PRESSURE TREATED.

No.

- 8. FRAMING ANCHORS: FRAMING ANCHORS, JOIST HANGERS, BEAM HANGERS, POST CAPS, POST ANCHORS, BACK-UP CLIPS AND ANGLES, UNLESS OTHERWISE SHOWN ON THE STRUCTURAL DRAWINGS, ARE ALL TO BE AS MANUFACTURED BY SIMPSON OR AN APPROVED EQUAL, AND SIZED APPROPRIATELY FOR THE CONNECTING MEMBERS. ALL ARE TO BE INSTALLED IN STRICT ACCORDANCE WITH THE MANUFACTURER'S INSTRUCTIONS AND SPECIFICATIONS UTILIZING NAILS OR SCREWS WHERE REQUIRED.
- 9. SPLICES, NOTCHING, AND DRILLING THROUGH MEMBERS IS NOT PERMITTED EXCEPT AS SPECIFIED BY THESE PLANS AND/OR AS APPROVED BY THE ENGINEER.

Description

Date

- 10. MANUFACTURED LUMBER OR TIMBER PRODUCTS NOT SPECIFIED HEREIN ARE TO BE APPROVED BY THE ENGINEER PRIOR TO USE. MANUFACTURED WOOD PRODUCT TO BE INSTALLED AS PER THE MANUFACTURER'S SPECIFICATIONS AND INSTRUCTIONS.
- 1. NUMBER, SIZE, AND LOCATION OF BRACING, BLOCKING, AND BRIDGING BETWEEN LUMBER OR TIMBER STRUCTURAL ELEMENTS TO CONFORM TO THE REQUIREMENTS IN THE ONTARIO BUILDING CODE PART 9.
- 12. MINIMUM BEARING OF WOOD JOISTS TO BE MINIMUM 1.5" (38mm).
- 13. MINIMUM BEARING OF WOOD BEAMS TO BE MINIMUM 3" (76mm).
- 14. MINIMUM BEARING OF WOOD ELEMENTS NOT SPECIFIED TO BE MINIMUM 3" (76mm).
- 5. ALL MULTIPLY WOOD MEMBERS SHALL BE BUILT-UP IN ACCORDANCE WITH OBC 2012, PART 9 OR PER MANUFACTURER'S SPECIFICATIONS AND GUIDELINES.
- 16. ALL LVL BEAMS SHALL MEET OR EXCEED 2.0E, 3100Fb.
- 17. PROTECT LVL OVERHANG EXPOSED TO EXTERIOR WEATHER BY APPLYING A WEATHERPROOF PAINT, 6MIL POLYETHYLENE VAPOUR BARRIER AND METAL COVER WITH CAULKING.
- 18. PROVIDE SOLID BLOCKING, SQUASH BLOCKS BELOW POINT LOADS TO ENSURE LOADS ARE PROPERLY TRANSFERRED TO SUPPORTING ELEMENTS OR FOUNDATION.

CAST-IN-PLACE CONCRETE AND REINFORCEMENT

GENERAL

- 1. ALL CONCRETE CONSTRUCTION SHALL CONFORM TO CSA A23.1, CSA A23.2 AND CSA A23.3.
- 2. CONCRETE QUALITY IS TO BE TESTED BY THE OWNERS' AGENCY ACCORDING TO CSA A23.2 INCLUDING STRENGTH, AIR CONTENT AND SLUMP TESTS FOR EACH CONCRETE POUR, WITH REPORTS SUBMITTED TO THE ENGINEER.
- 3. THE CONTRACTOR SHALL NOT PROCEED WITH PLACING CONCRETE THAT FAILS TO MEET THE SPECIFIED SLUMP OR AIR CONTENT REQUIREMENTS OR EXCEEDS 2 HOURS AFTER BATCHING.

PRODUCTS

- 1. PORTLAND CEMENT, WATER AND AGGREGATES SHALL CONFORM TO CSA A23.1 AND SHALL HAVE THE FOLLOWING PROPERTIES:
- 2. NOMINAL MAXIMUM COARSE AGGREGATE SIZE 1/2".
- 3. REINFORCING STEEL SHALL BE DEFORMED BARS CONFORMING TO CSA G30.18 GRADE 400 MPA UNLESS NOTED OTHERWISE.
- 4. WELDED WIRE FABRIC TO CONFORM TO CSA G30.5.
- REINFORCING STEEL SHALL BE DETAILED, BENT, PLACED AND SUPPORTED IN CONFORMANCE WITH CSA A23.3, ACI STANDARD
 315 AND THE REINFORCING STEEL MANUAL OF STANDARD PRACTICE PUBLISHED BY THE REINFORCING STEEL INSTITUTE OF
 CANADA
- 6. CONCRETE MINIMUM COMPRESSIVE STRENGTH AT 28 DAYS SHALL BE AS FOLLOWS:
 - A. EXTERIOR SLABS ON GRADE, FLATWORK 32 MPA WITH 5-8% AIR ENTRAINMENT

EXECUTION

- 1. UNLESS NOTED OTHERWISE CONCRETE COVER FOR REINFORCEMENT SHALL MEET THE FOLLOWING REQUIREMENTS:
- A. WHEN CAST AGAINST EARTH 75MM (3")
- 2. PROVIDE CORNER BARS AND HOOKED DOWELS (26"x26") AT CORNERS.
- 3. ADD FLOOR HARDENERS, WATERPROOFING AGENTS IF REQUIRED PER OWNER'S PREFERENCE.

FOUNDATIONS / BACKFILLING AND COMPACTION GENERAL

1. ALL FOOTINGS TO BEAR ON COMPACTED GRANULAR ON UNDISTURBED SOIL WITH MINIMUM ALLOWABLE SOIL BEARING CAPACITY OF 75KPA.


EXECUTION

- 1. REMOVE TOPSOIL AND OTHER ORGANIC MATERIAL FROM THE BUILDING AREA.
- 2. PROTECT EXCAVATED SURFACE FROM WATER OR FROST DAMAGE, WHERE APPLICABLE.
- 3. KEEP EXCAVATIONS CONTINUOUSLY DRY BEFORE CONCRETE IS PLACED
- 4. UNLESS OTHERWISE NOTED, PROVIDE IMMEDIATELY UNDER SLABS-ON-GRADE A MINIMUM OF 150MM (6 ") OF COMPACTED GRANULAR A MATERIAL.
- 5. PROVIDE POSITIVE DRAINAGE FOR ALL EXTERIOR SURFACES, AND INTERIOR SURFACES PROVIDED WITH DRAINS, WITH CONSTANT SLOPES TO DRAINS OR DRAINAGE COURSES, AND AWAY FROM CONSTRUCTION.
- 6. PROVIDE PERIMETER DRAINING TILE WHERE SURROUNDING SOIL IS NOT FREE DRAINING.

	St	rin	gν	vater	•
\downarrow				Limited	

gineering Limited	
24 Parkside Drive Barrie, ON L4N 1W6 Tel (705) 721-7228	
Tel (703) 721-7220	

1	Issued for Review	July 03, 2024
2	Issued for Permit	July 09, 2024
3	Site Plan Review	July 22, 2024
4	Site Plan Review	August 27, 2024

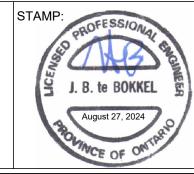

ALL DIMENSIONS SHALL BE VERIFIED BY THE CONTRACTOF IN THE COURSE OF WORK. REPORT ANY DISCREPANCIES OR OMISSIONS PRIOR TO COMMENCEMENT OF WORK

DRAWING WILL PLOT TO SCALE ON 11"x17" PAPER SIZE

	CLIENT:	DRAWING:	Project number	2629
ıR	Martin Romar	NOTES	Date	August 27, 2024
'I'			Drawn by	TV
			Scale	
	PROJECT:	LOCATION:		
E	Unheated Storage Addition	2571 Innisfil Beach Road		~ -

Innisfil. ON

