



COMMITTEE OF ADJUSTMENT NOTICE OF PUBLIC HEARING APPLICATION NO. A-034-2023

TAKE NOTICE that an application has been received by the Town of Innisfil from **Agostino DiMarsico** and **Doris Tucci**, **Owners**, for a minor variance from Zoning By-law 080-13, pursuant to Section 45 of the *Planning Act*, R.S.O. 1990, c. P.13, as amended.

The subject property is described legally as PLAN 767 LOT 55, is known municipally as 1041 Fern Road, and is zoned as "Residential 1 (R1).

The applicant is proposing to construct an Accessory Dwelling Unit (ADU) with a height of 6.34 m. The applicant is seeking relief from Section 3.5 (g) of the Zoning By-law which permits a maximum height of 6 m for accessory dwelling units.

The Committee of Adjustment for the Town of Innisfil will consider this application in person at Town Hall and virtually through Zoom on **Thursday**, **June 15**, **2023**, **at 6:30 PM**.


To participate in the hearing and/or provide comments, you must register by following the link below or scanning the above QR code: <u>https://innisfil.ca/en/building-and-development/committee-of-adjustment-hearings.aspx</u>

Requests can also be submitted in writing to: Town of Innisfil Committee of Adjustment, 2101 Innisfil Beach Road, Innisfil, Ontario, L9S 1A1 or by email to <u>planning@innisfil.ca</u>.

If you wish to receive a copy of the decision of the Committee of Adjustment in respect of the proposed minor variance, you must make a written request to the Secretary-Treasurer of the Committee of Adjustment by way of email or regular mail. The Notice of Decision will also explain the process for appealing a decision to the Local Planning Appeal Tribunal.

Additional information relating to the proposed application is available on the Town of Innisfil website. Accessible formats are available on request, to support participation in all aspects of the feedback process. To request an alternate format please contact Planning Services at <u>planning@innisfil.ca</u>.

Dated: May 30, 2023

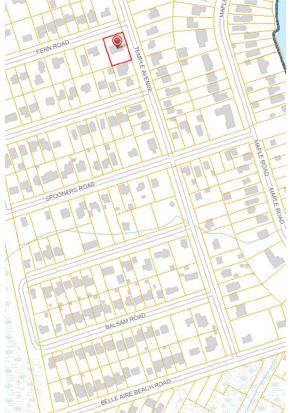

Toomaj Haghshenas, Secretary-Treasurer <u>thaghshenas@innisfil.ca</u> 705-436-3710 ext. 3316

Town of Innisfil • 2101 Innisfil Beach Rd., Innisfil ON L9S 1A1 • 705-436-3710 • 1-888-436-3710 • Fax: 705-436-7120 www.innisfil.ca





RESIDENCE - EAST ELEVATION



RESIDENCE - NORTH ELEVATION

LIST OF DRAWINGS

A100 - SITE PLAN AND ZONING MATRIX A101 - FOUNDATION AND FIRST FLOOR PLANS A102 - SECOND FLOOR AND ROOF PLANS A103 - SECTIONS THROUGH FLOOR BEAM AND RIDGE BEAM A104 - SECTIONS THROUGH SHED AND GABLE DORMERS A105 - SECTIONS THROUGH ENTRY STAIRS A106 - ELEVATIONS A107 - RENDERINGS


GUS DIMARSICO AND DORIS TUCCI

1041 FERN ROAD INNISFIL, ONTARIO

PROJECT 2084 THREE CAR GARAGE WITH SECOND SUITE ABOVE PLANS FOR MINOR VARIANCE - MAY 3, 2023

> CONTACT: WIL EISSES 705-721-7228 Ext. 104 wilfredae.sel@gmail.com

SCOPE OF WORK: THE OWNERS REQUEST PLANS FOR A THREE CAR GARAGE WITH A SECOND SUITE ABOVE.

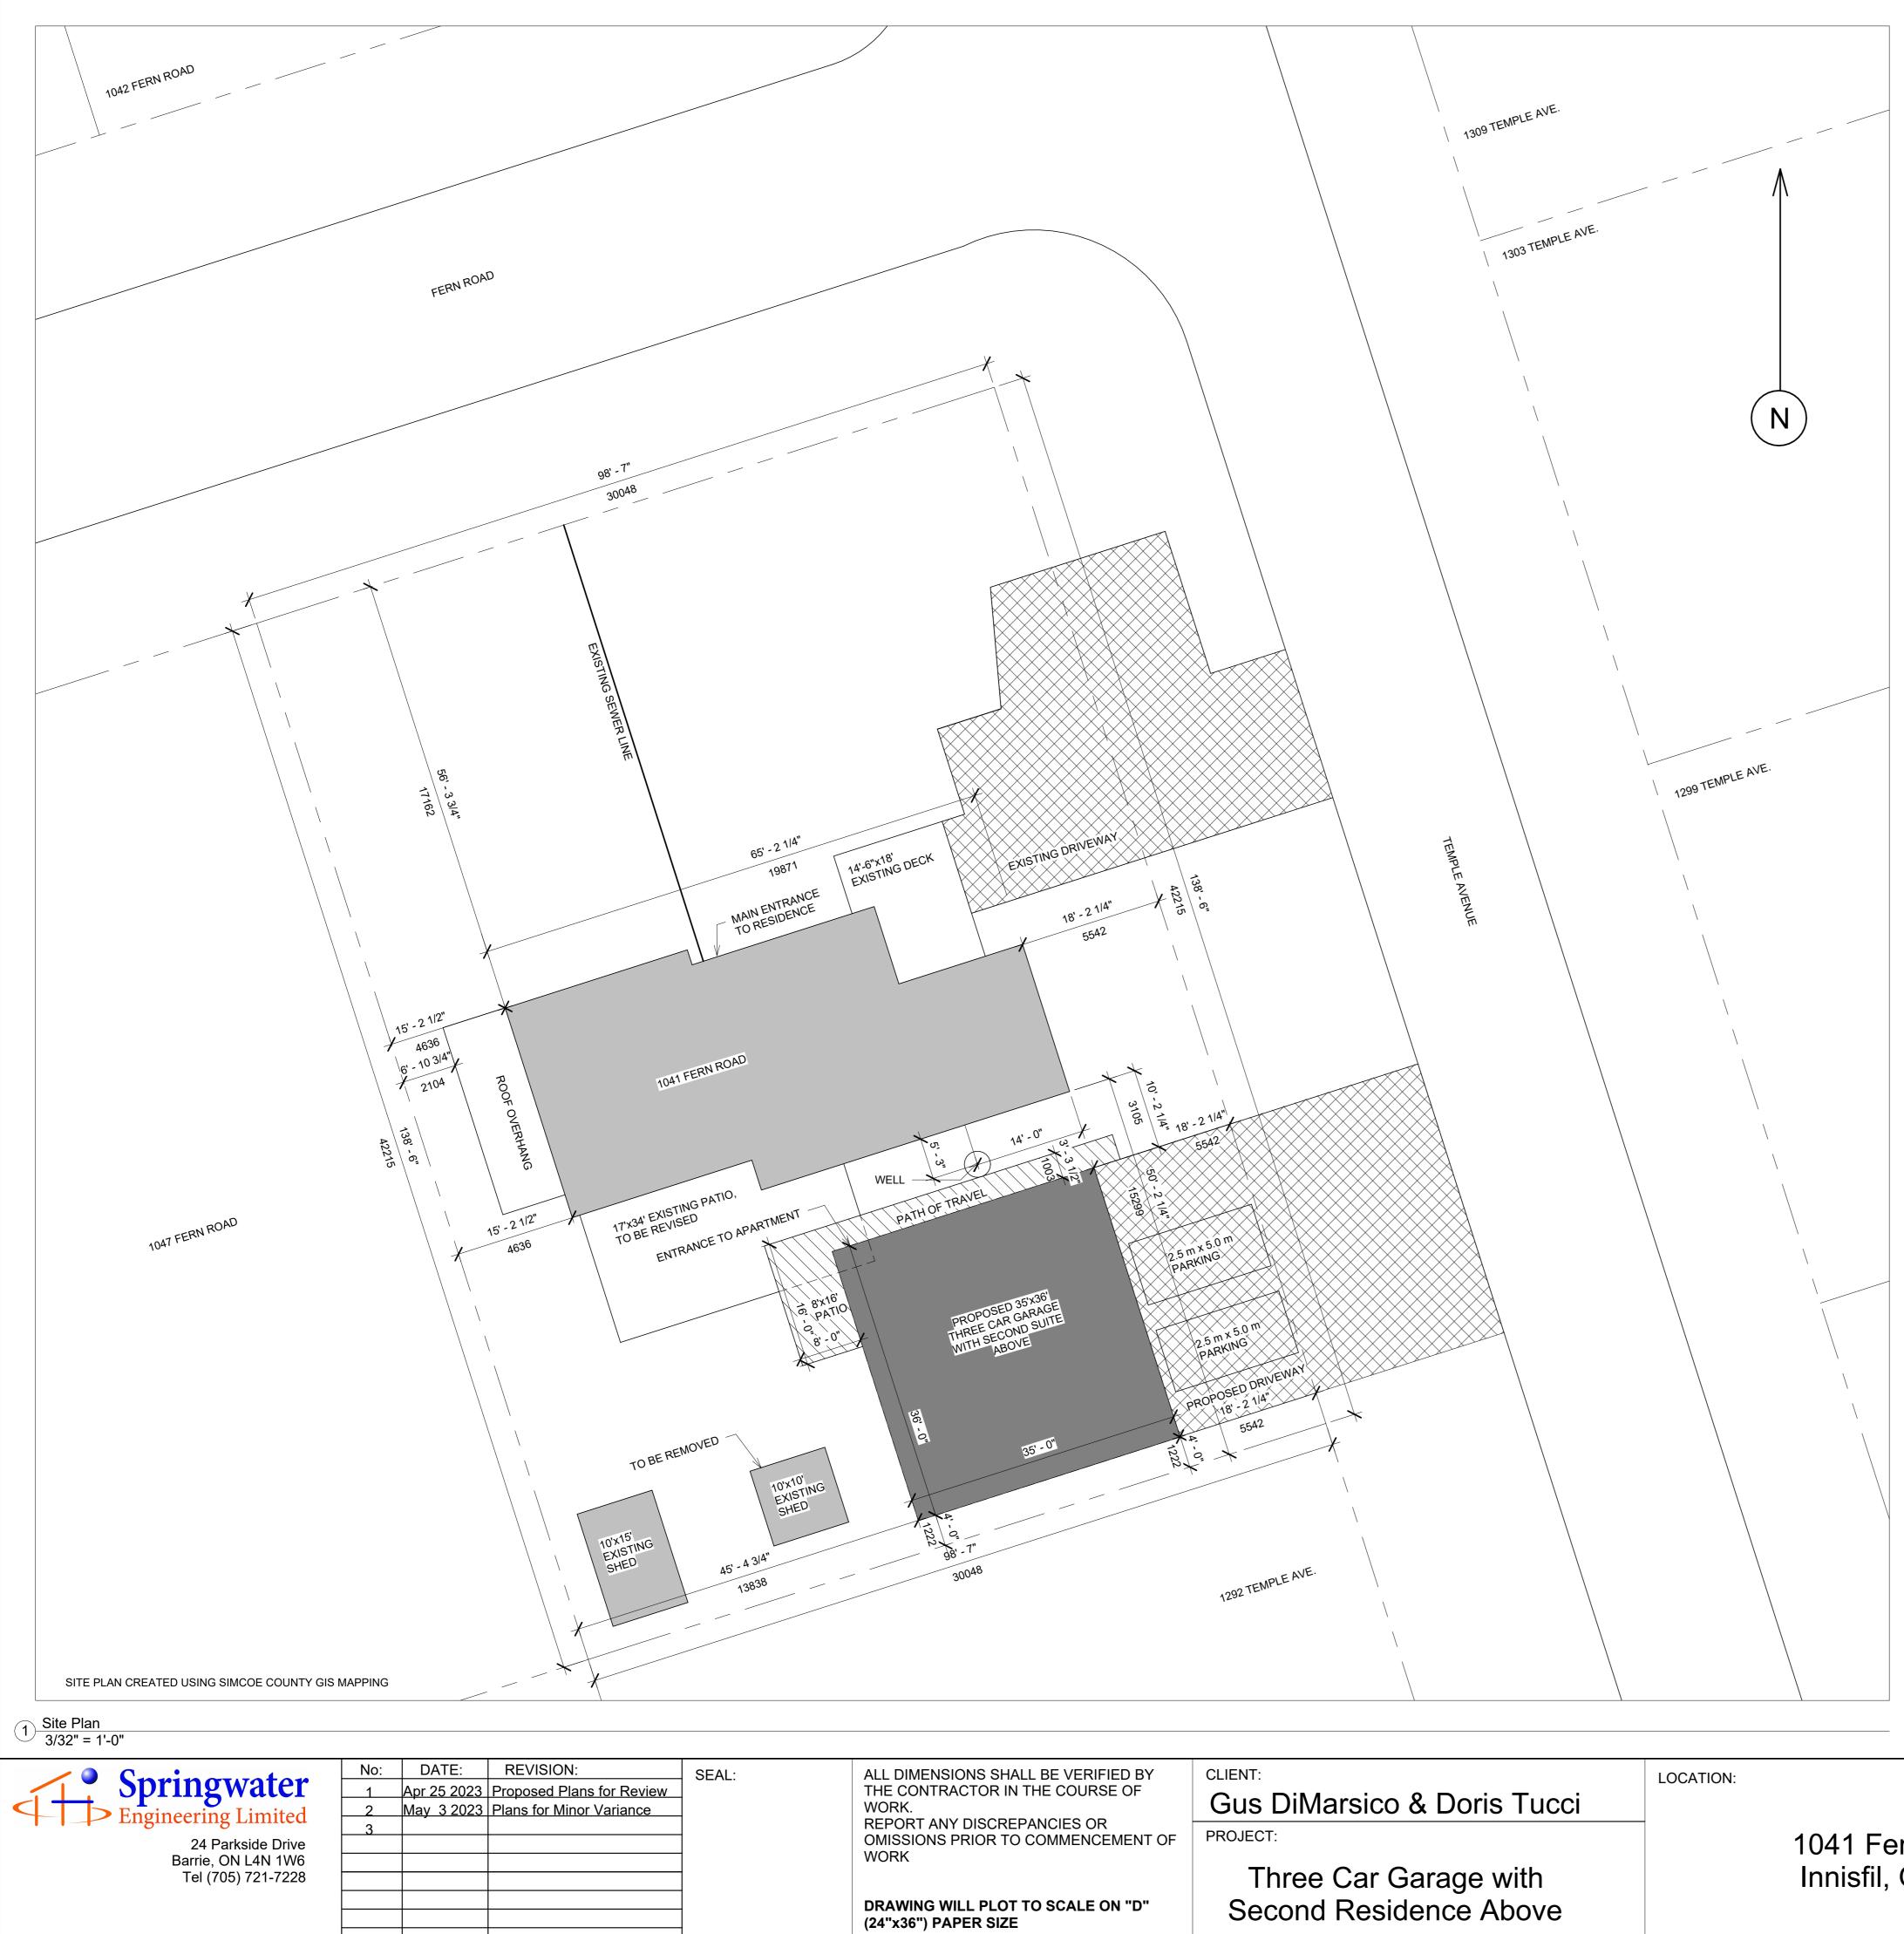


1041 Fern Road Innisfil, Ontario


ZONING - ACCESSORY DWELLING UNITS (RESIDENTIAL ZONES)

ACCESSORY DWELLING UNIT MAXIMUM NUMBER	AS AN ACCESSORY TO A SINGLE-DETACHED DWELLING (2) TWO ACCESSORY DWELLING UNITS PERMITTED PER LOT THAT HAS A MIN. LOT AREA OF 1000 m ² , ON A LOT LESS THAN 1000 m ² A MAXIMUM OF ONE (1) DETACHED ACCESSORY UNIT SHALL BE PERMITTED
GROSS FLOOR AREA	SHALL NOT BE GREATER THAN 50% OF THE GROSS FLOOR AREA OF THE PRINCIPAL DWELLING ON THE LOT, UP TO A MAX. GROSS FLOOR AREA OF 100 SQUARE METRES
NUMBER OF BEDROOMS	MAXIMUM OF THREE (3)
SEVERANCE	SHALL NOT BE SEVERED FROM THE LOT THAT CONTAINS THE
SEVERANCE	PRINCIPAL DWELLING
PARKING	A MINIMUM OF 2 OFF-STREET PARKING SPACES MUST BE
PARKING	
	PROVIDED WHEN A LOT HAS ONE (1) ACCESSORY DWELLING UNIT,
	TANDEM PARKING IS PERMITTED, EXTERIOR PARKING SPACES
	SHAL BE A MINIMUM OF 2.5 m x 5 m (8.2 ft x 16.4 ft)
HEIGHT	THE MAX. HEIGHT SHALL NOT EXCEED THE HEIGHT OF THE
	PRINICIPAL DWELLING OR 6 m (19.69 ft) WHICHEVER IS LESS
BALCONY	SHALL NOT BE PERMITTED ON A DETACHED ACCESSORY
	DWELLING UNIT
LOCATION	ANY DETACHED ACCESSORY DWELLING UNIT SHALL NOT BE
	LOCATED WITHIN THE FRONT YARD, AND NOT MORE THAN
	60 m (196.85 ft) FROM THE PRINCIPAL DWELLING. ANY DWELLING
	UNIT LOCATED IN A REAR YARD SHALL BE A COMBINED MAX. OF
	50% OF THE REAR YARD, UP TO A MAX. OF 50 m ² IN FOOTPRINT
	COVERAGE, WITH A MIN. OF 25% OF THE REAR YARD MAINTAINED
	AS LANDSCAPED OPEN SPACE
ENTRANCE	ANY UNIT LOCATED IN A REAR YARD SHALL BE ACCESSED BY A
	CONTINUOUS, UNOBSTRUCTED PATH OF TRAVEL OF AT LEAST
	1 m (3.28 ft) WIDE BETWEEN THE MAIN WALL OF THE BUILDING AND
	THE SIDE LOT LINE
REGISTRATION	THE PROPERTY OWNER MUST REGISTER EACH ACCESSORY
REGIOTRATION	DWELLING UNIT WITH THE TOWN AND SHALL BE IN COMPLIANCE
	WITH ANY APPLICABLE ACCESSORY DWELLING UNITS REGISTRATION
	BYLAW
GARAGE / HUMAN HABITATION	NOT UNLESS SPECIFIC PLANNING PERMISSIONS HAVE BEEN GRANTE
NUMBER OF DRIVEWAYS	ONLY ONE (1) DRIVEWAY SHALL BE PERMITTED PER RESIDENTIALLY
	ZONED LOT IN A SETTLEMENT AREA

	REQUIRED	EXISTING	PROPOSED
ZONE	R1	R1	R1
MINIMUM LOT AREA, EXTERIOR LOT	600m ²	1269 m ² , 13653.79 ft ²	NO CHANGE
MINIMUM LOT FRONTAGE	15 m	30.05 m, 98'-7"	NO CHANGE
MIN. FRONT YARD SETBACK	8 m	17.16 m, 56'-3 3/4"	NO CHANGE
MIN. INTERIOR SIDE YARD, WEST	1.2 m	4.64 m, 15'-2 1/2"	NO CHANGE
MIN. EXTERIOR SIDE YARD, EAST	6 m	5.54 m, 18'-2 1/4"	NO CHANGE
MIN. REAR YARD	6 m	15.30 m, 50'-2 1/4"	NO CHANGE
MAX. LOT COVERAGE (ALL STRUCTURES)	35%	20%	23%
MIN. LANDSCAPED OPEN SPACE	30%	75%	62%
MAX. BUILDING HEIGHT	9 m	9 m	-
DETACHED ACCESSORY DWELLING U	NIT		
MIN. SETBACK, FRONT	6 m, 19'-8"	-	N/A
MIN. SETBACK, INTERIOR SIDE	1.2 m, 47.2"	-	13.8 m, 45'-4 3/4
MIN. SETBACK, EXTERIOR SIDE	3 m, 9'-10"	-	5.54 m, 18'-2 1/4"
MIN. SETBACK, REAR	1.2 m, 47.2"	-	1.2 m, 4'-0"
MAX. HEIGHT (MID POINT) OR PRINCIPAL BUILDING, LEAST	6 m, 19'-8"	-	6.34 m, 20'-9 3/4' MAIN ROOF
MAX. HEIGHT (MID POINT) OR PRINCIPAL BUILDING, LEAST	6 m, 19'-8"	-	7.01 m, 23'-0" DORMER ROOF
LOT COVERAGE	10%	-	9.2%
GROSS FLOOR AREA	50 m ² , 538.2 ft ²	-	116 m ² , 1250 ft ²
MAX. DISTANCE FROM PRINCIPAL	60 m, 196'-10"	-	3.1 m, 10'-2 1/4"


DRAWING:		Drawn by:	WJE
		Date:	March 1, 2023
Site Plan and Zoning		Scale:	As indicated
Matrix	DWG No:	Job#:	2084
	A100		

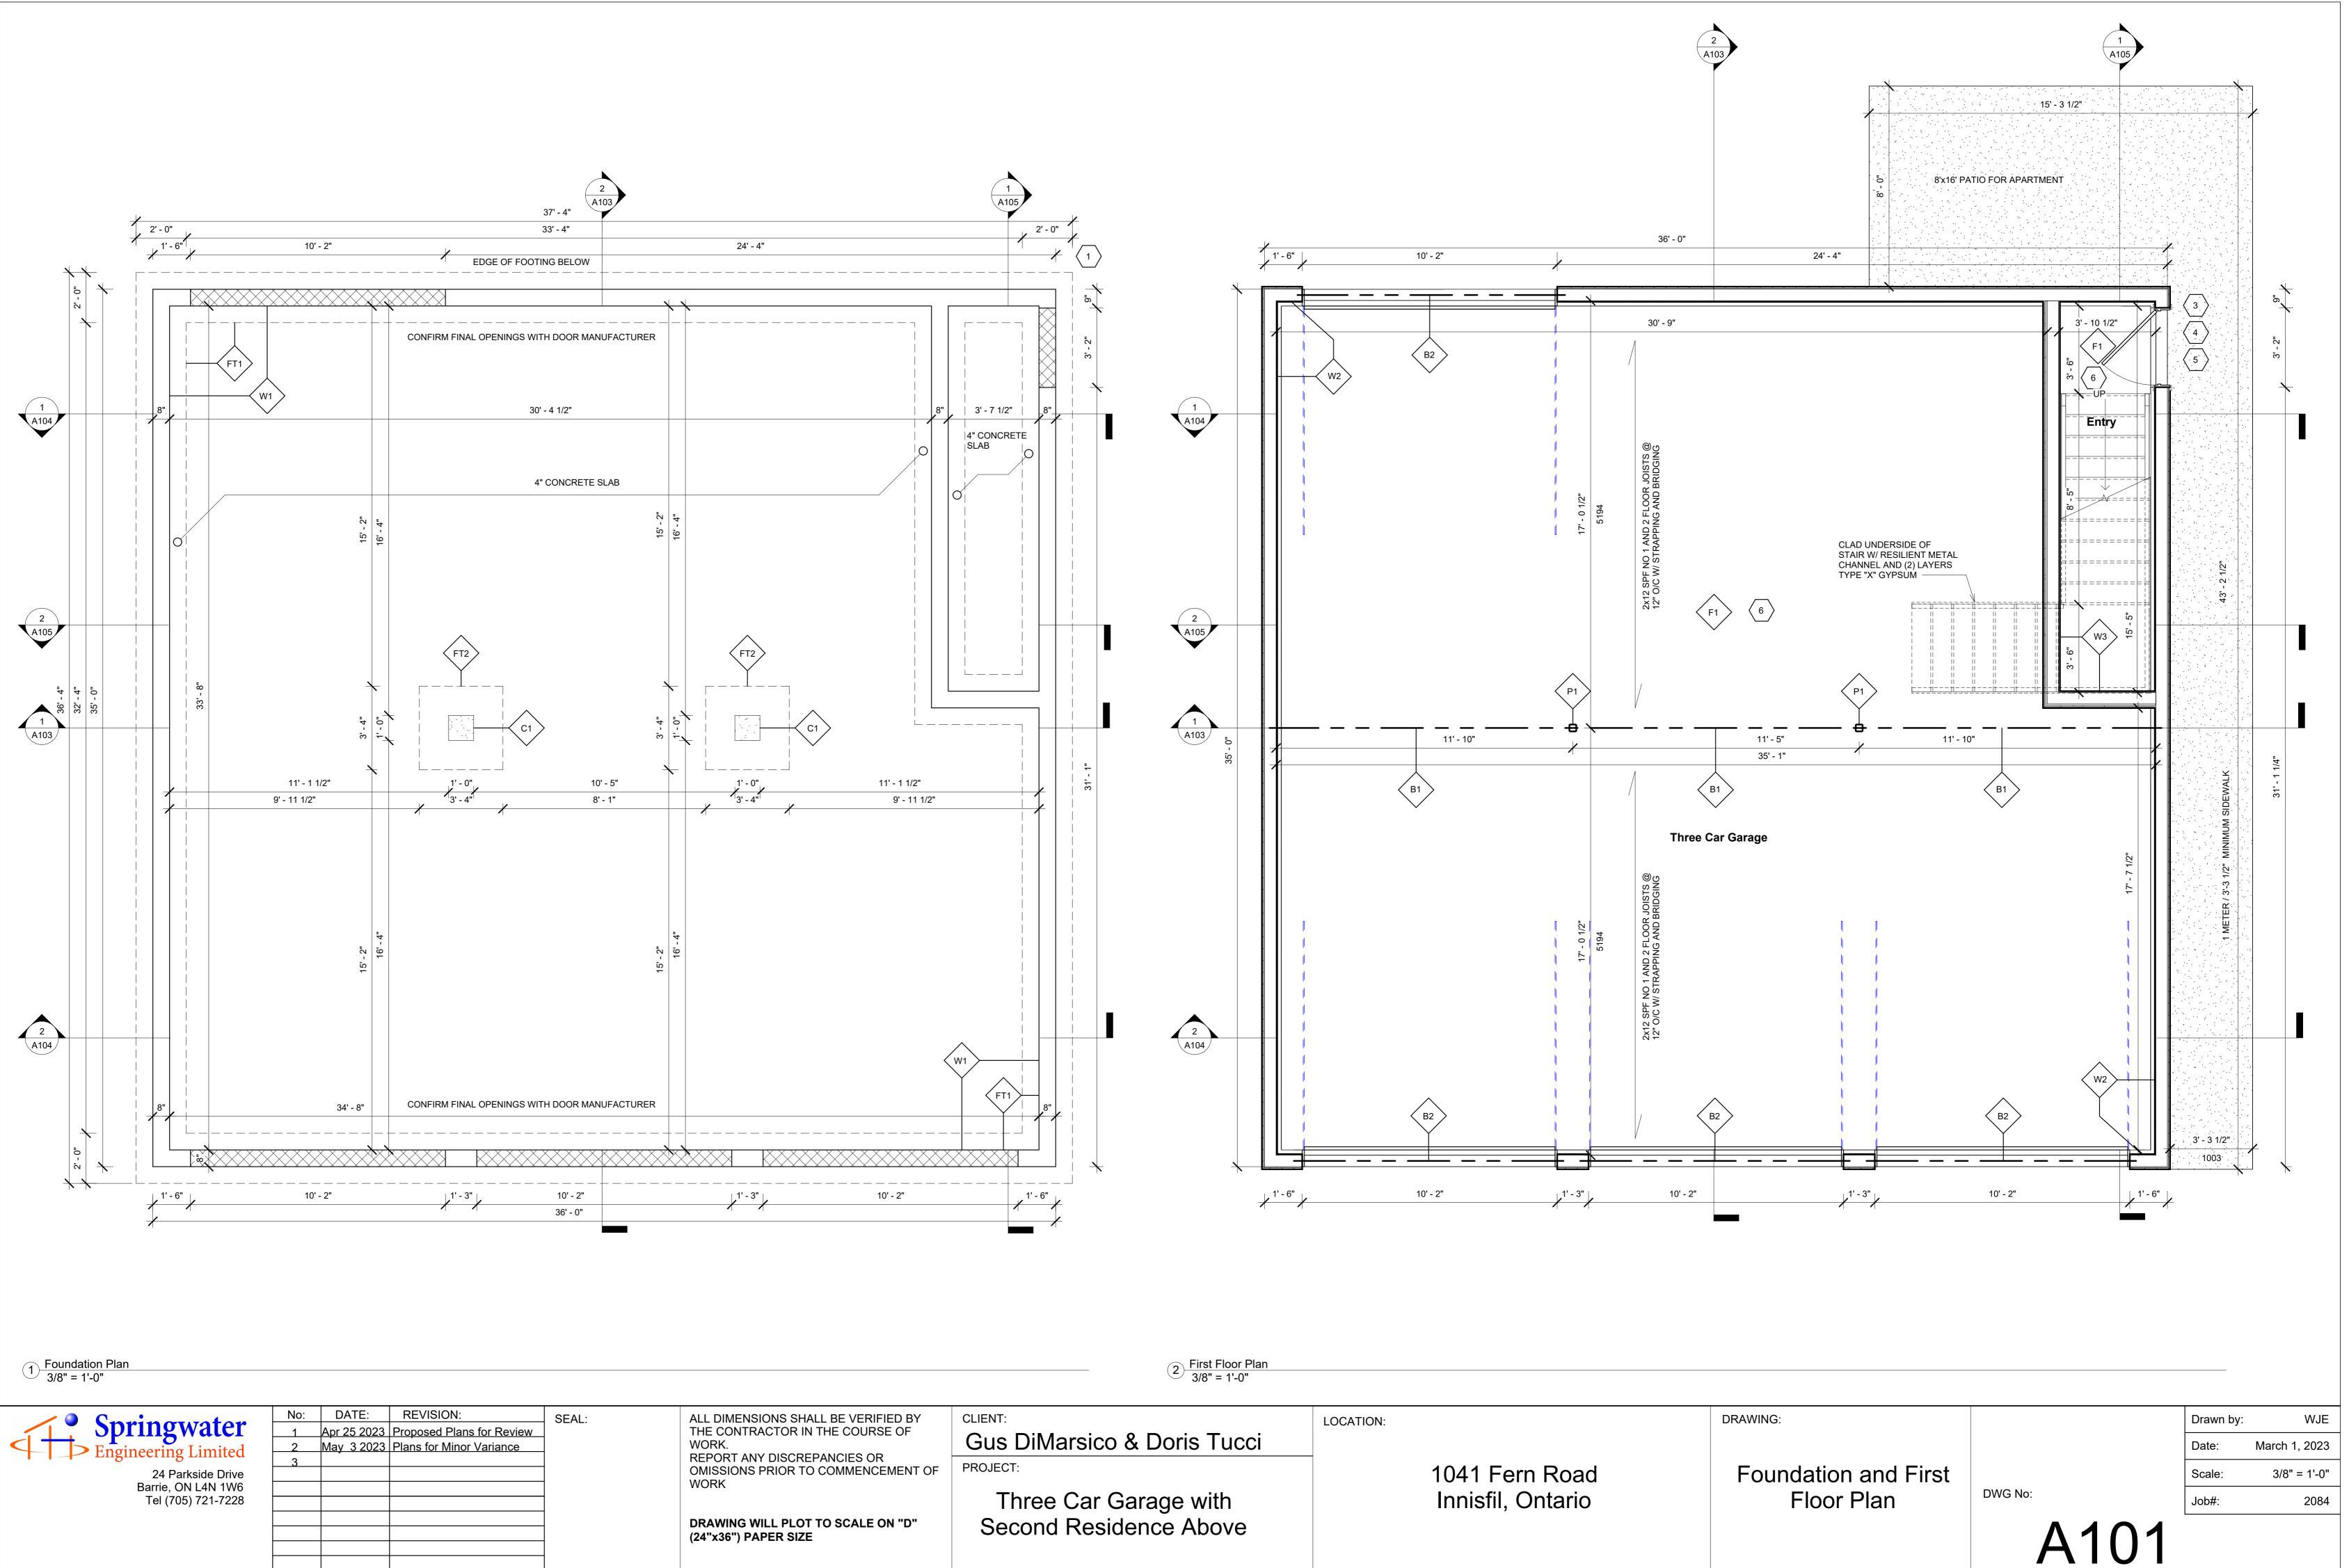

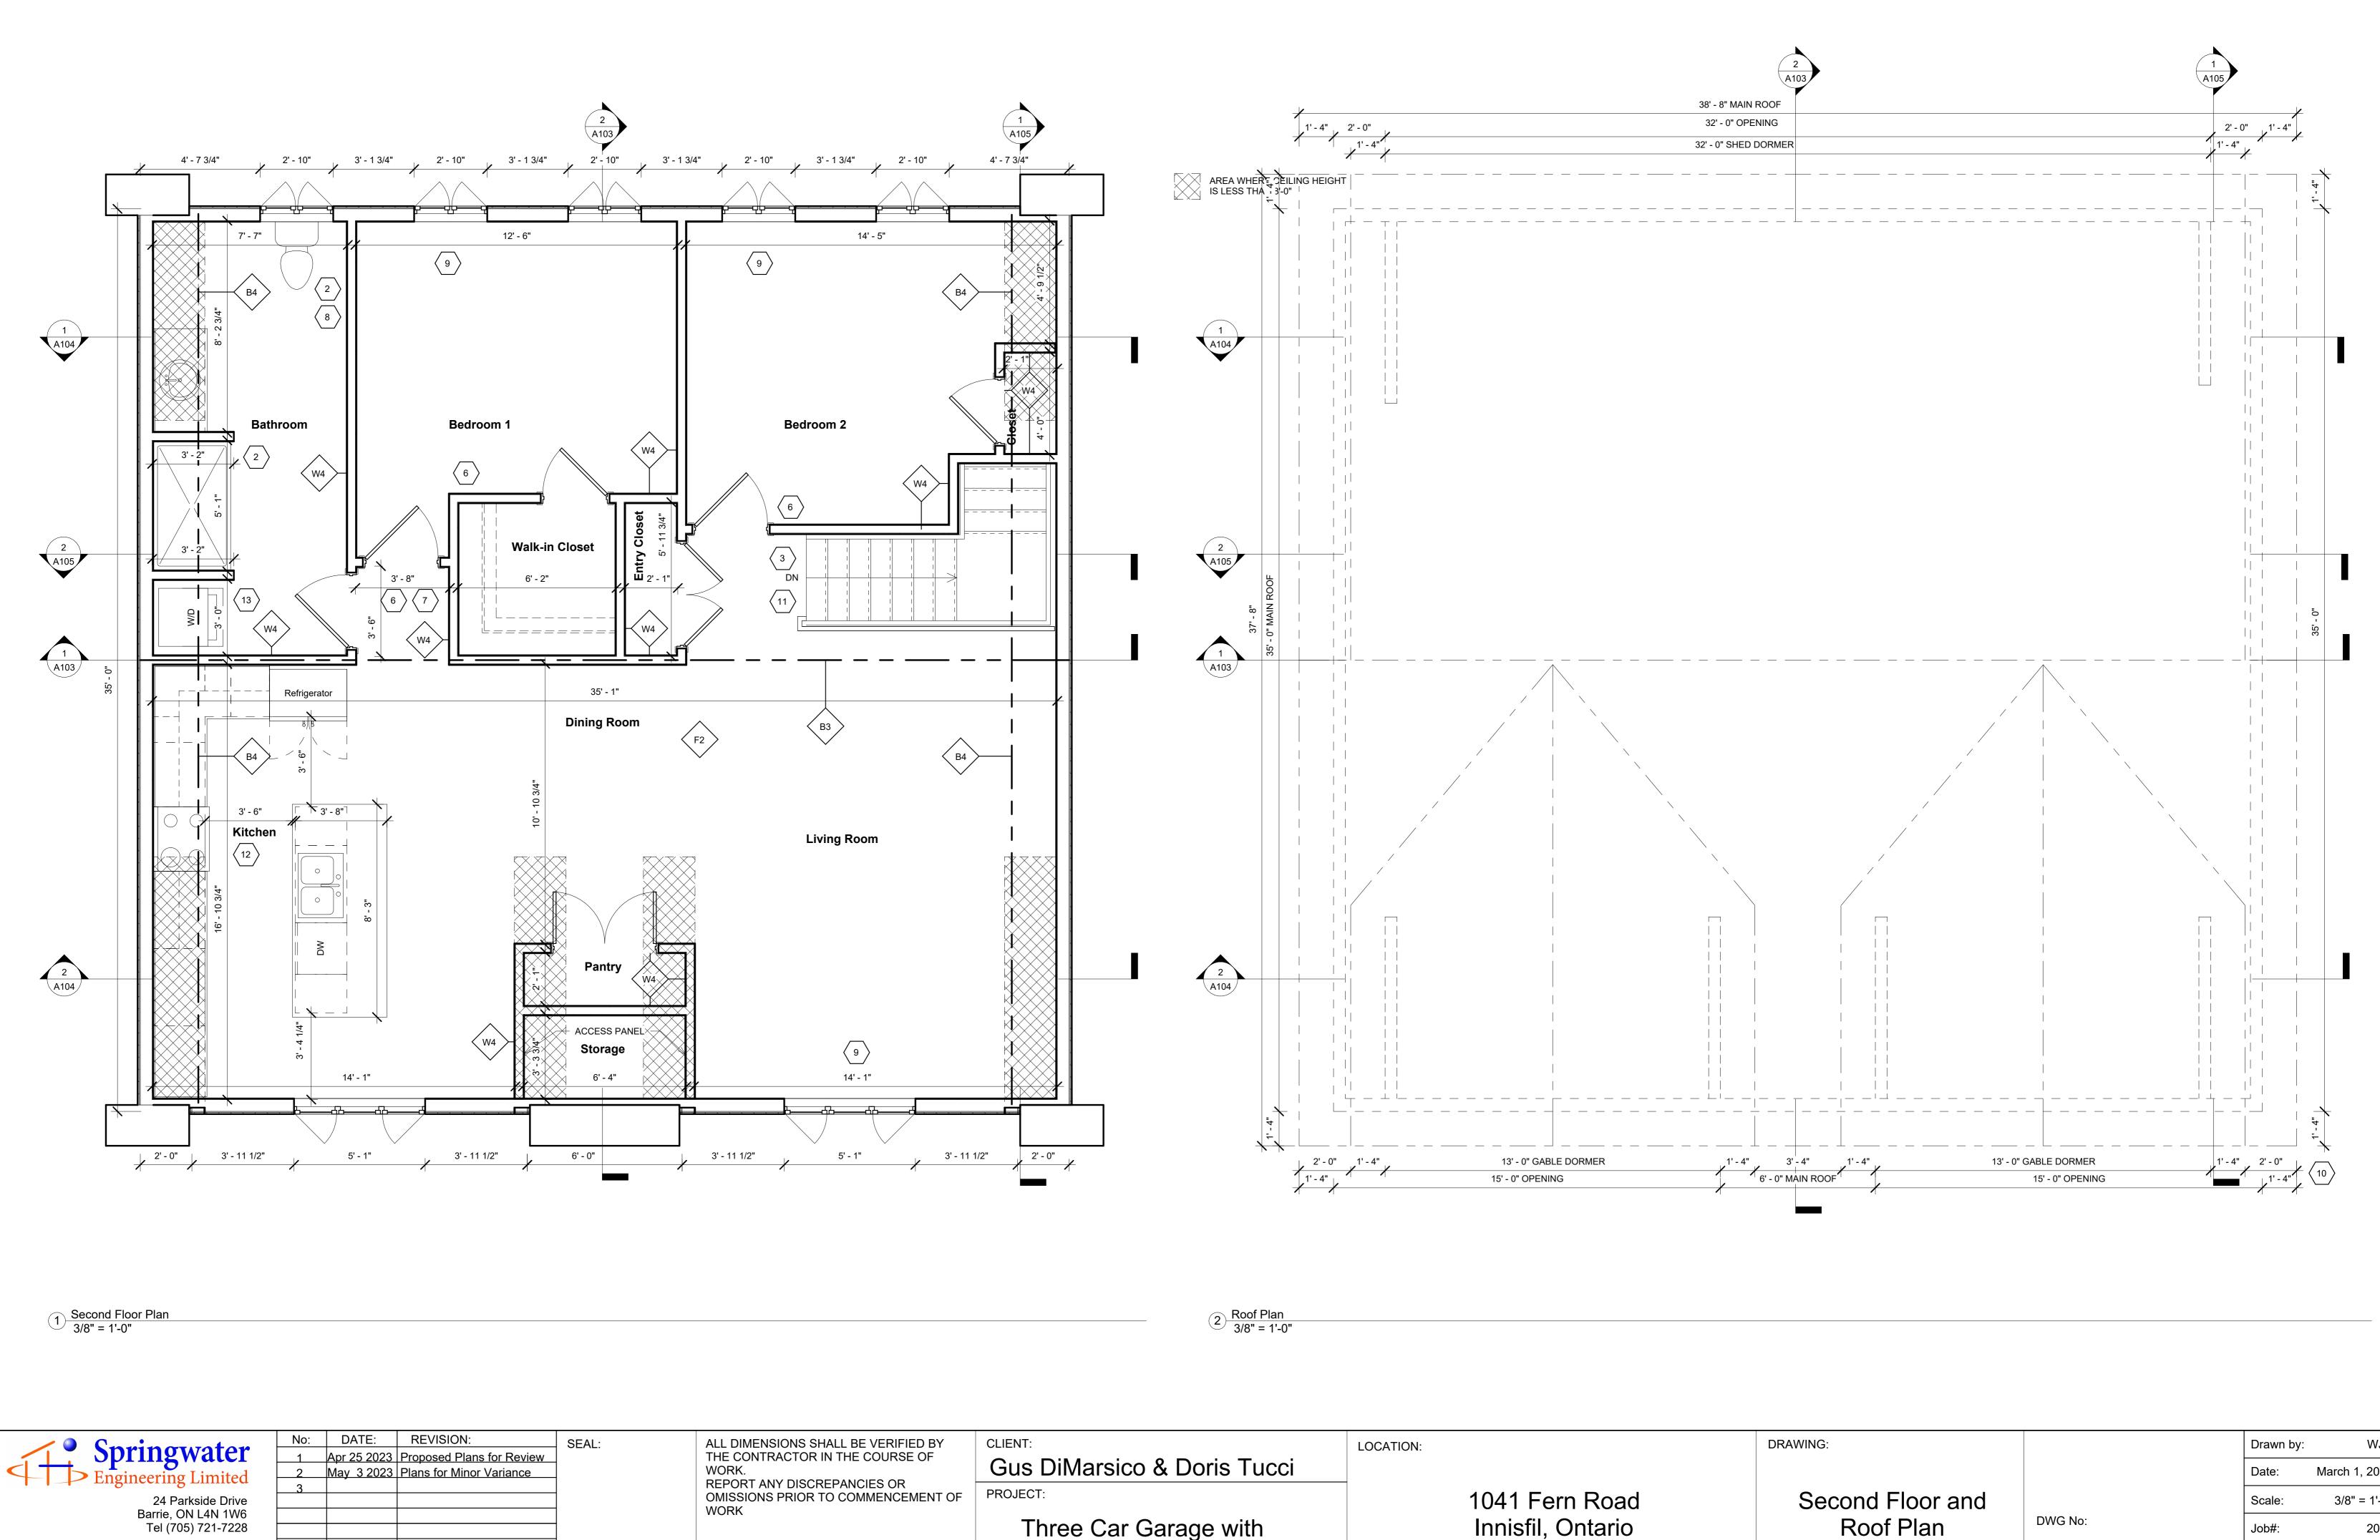


ALL DIMENSIONS SHALL BE VERIFIED BY THE CONTRACTOR IN THE COURSE OF WORK.	CLIENT: Gus DiMarsico & Doris Tucci	LOCATION:		
	REPORT ANY DISCREPANCIES OR OMISSIONS PRIOR TO COMMENCEMENT OF WORK	PROJECT:		1041 Fern Road Innisfil, Ontario
	DRAWING WILL PLOT TO SCALE ON "D" (24"x36") PAPER SIZE	Three Car Garage with Second Residence Above		minisii, Ontano

DRAWING:		Drawn by:	WJE
		Date:	March 1, 2023
Second Floor and		Scale:	3/8" = 1'-0"
Roof Plan	DWG No:	Job#:	2084
	A102		

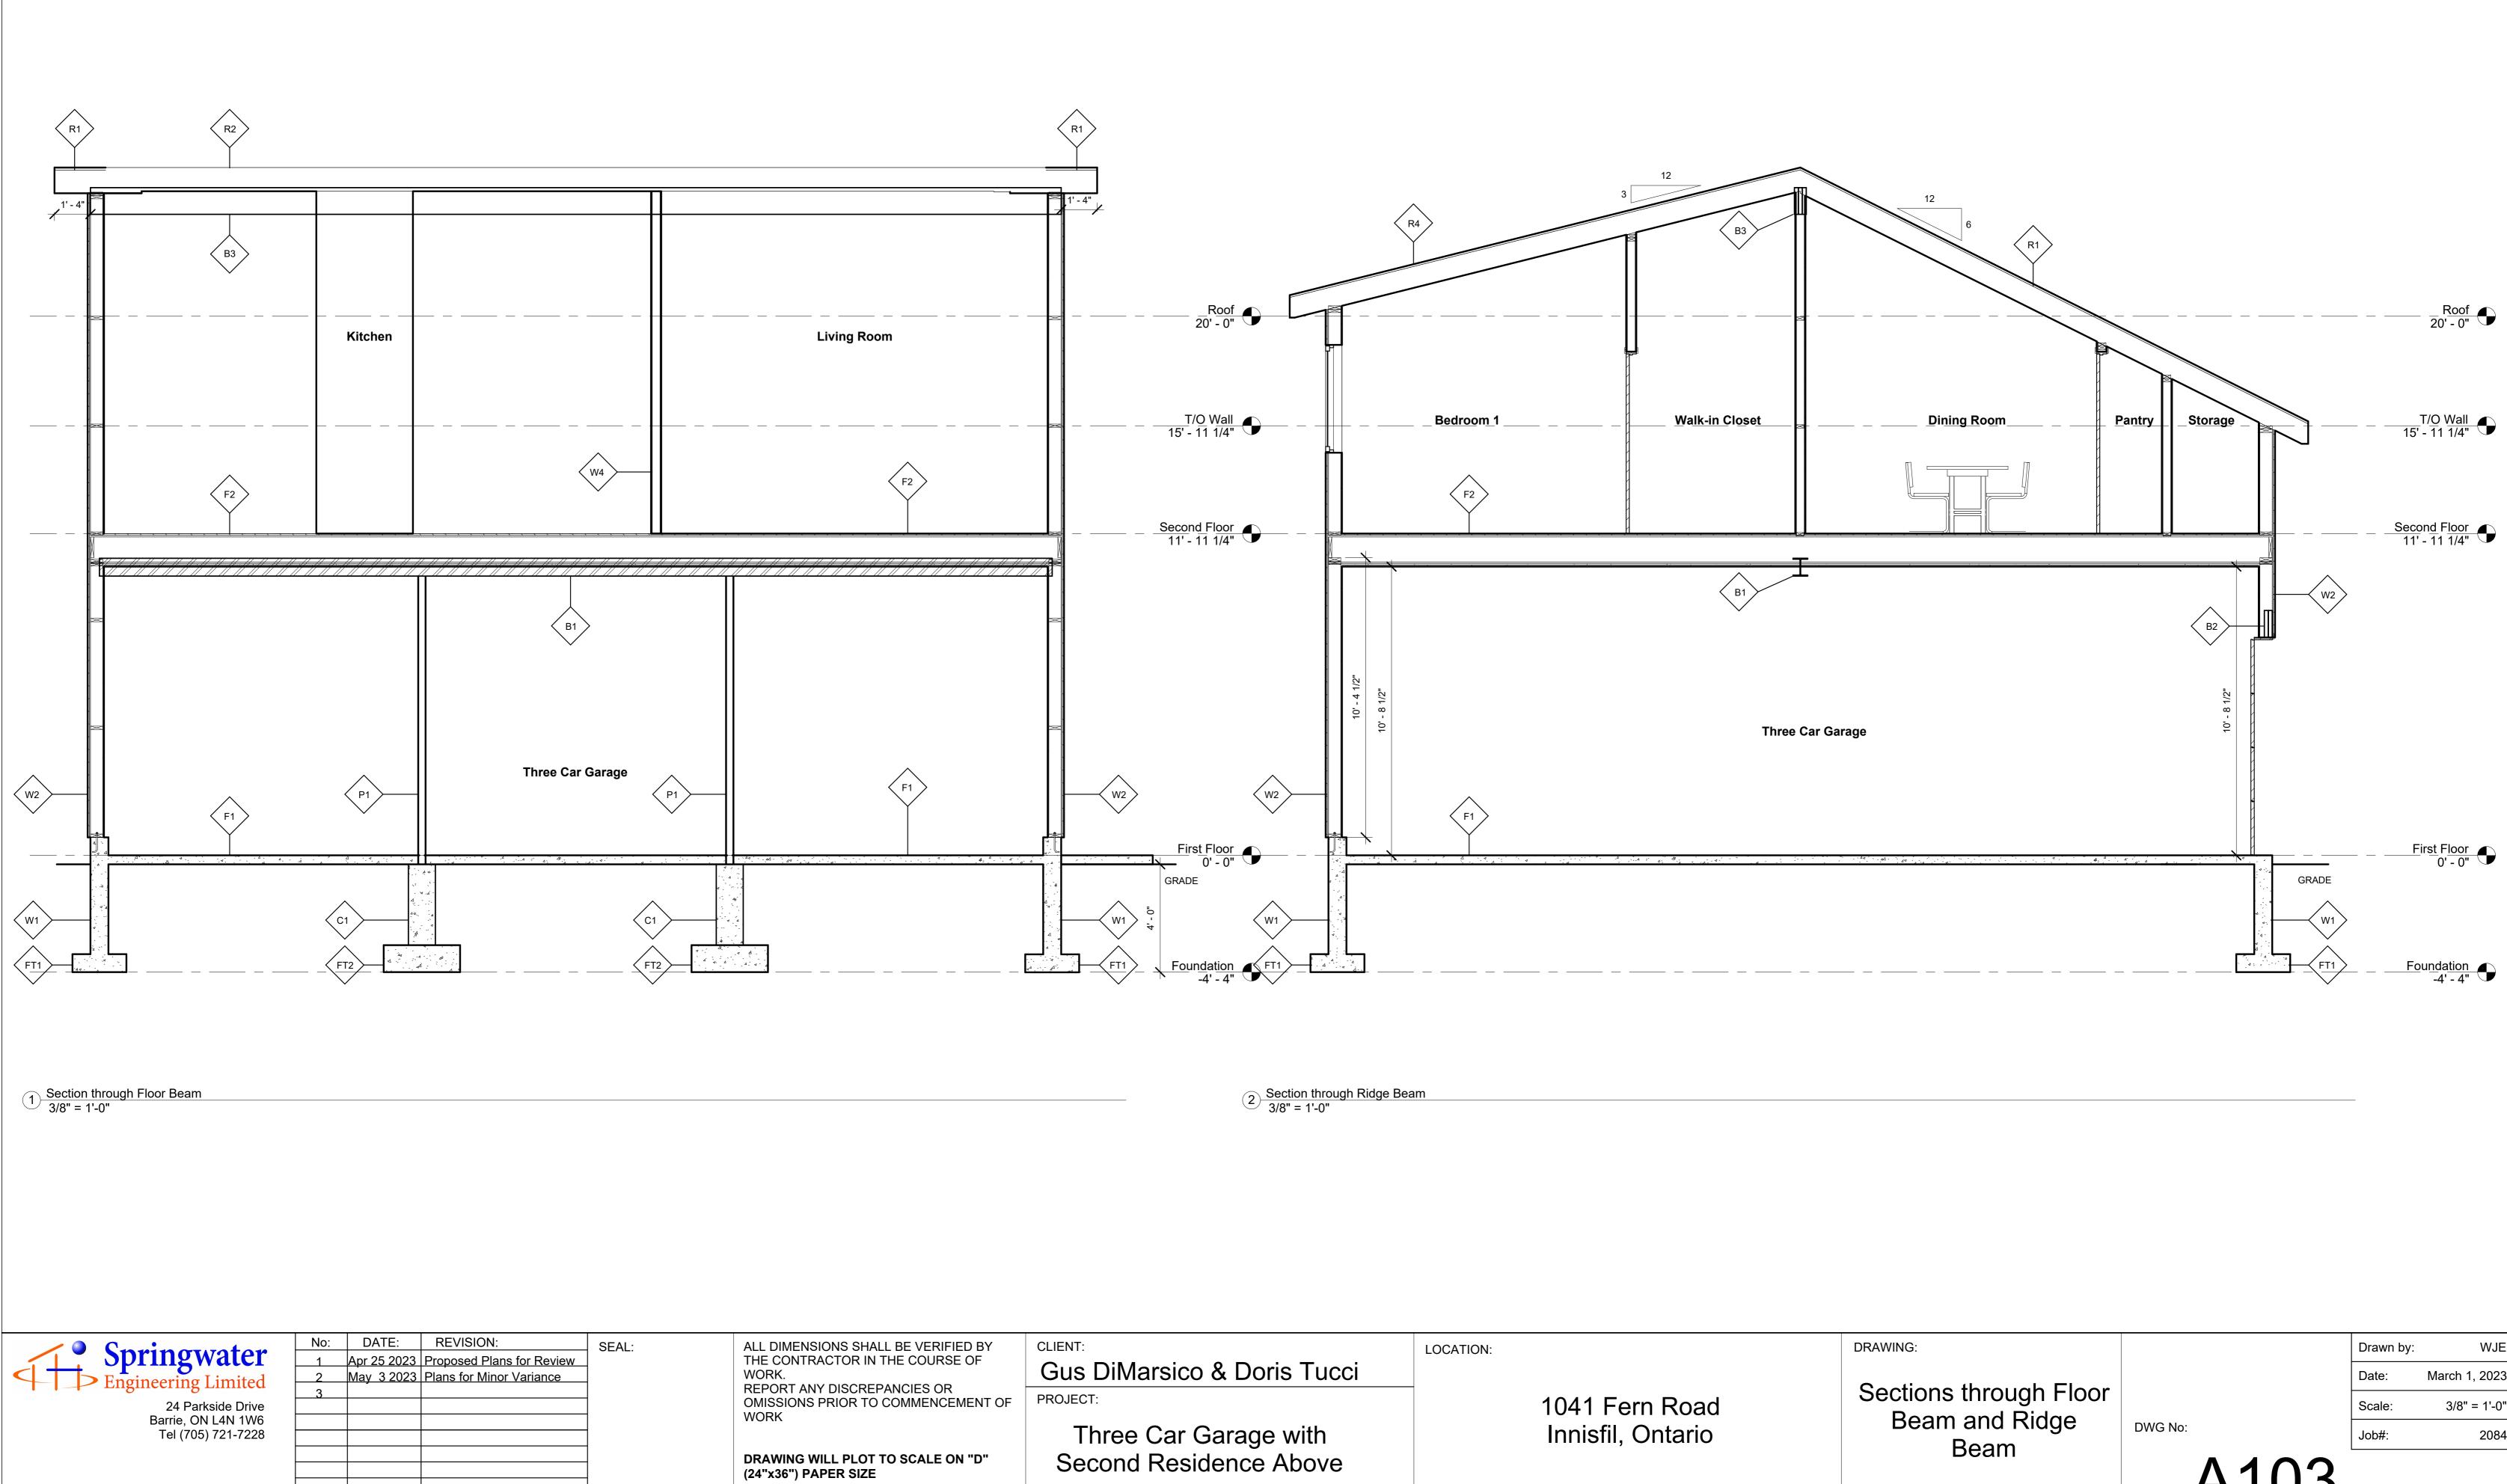


NS SHALL BE VERIFIED BY TOR IN THE COURSE OF DISCREPANCIES OR RIOR TO COMMENCEMENT OF	CLIENT:	LOCATION:	
	Gus DiMarsico & Doris Tucci		
	PROJECT:		1041 Fern Road
L PLOT TO SCALE ON "D" R SIZE	Three Car Garage with Second Residence Above		Innisfil, Ontario

DRAWING:		Drawn by:	WJE
Sactiona through Elea		Date:	March 1, 2023
Sections through Floor		Scale:	3/8" = 1'-0"
Beam and Ridge Beam	DWG No:	Job#:	2084
Deam	A103		
	AIUJ		

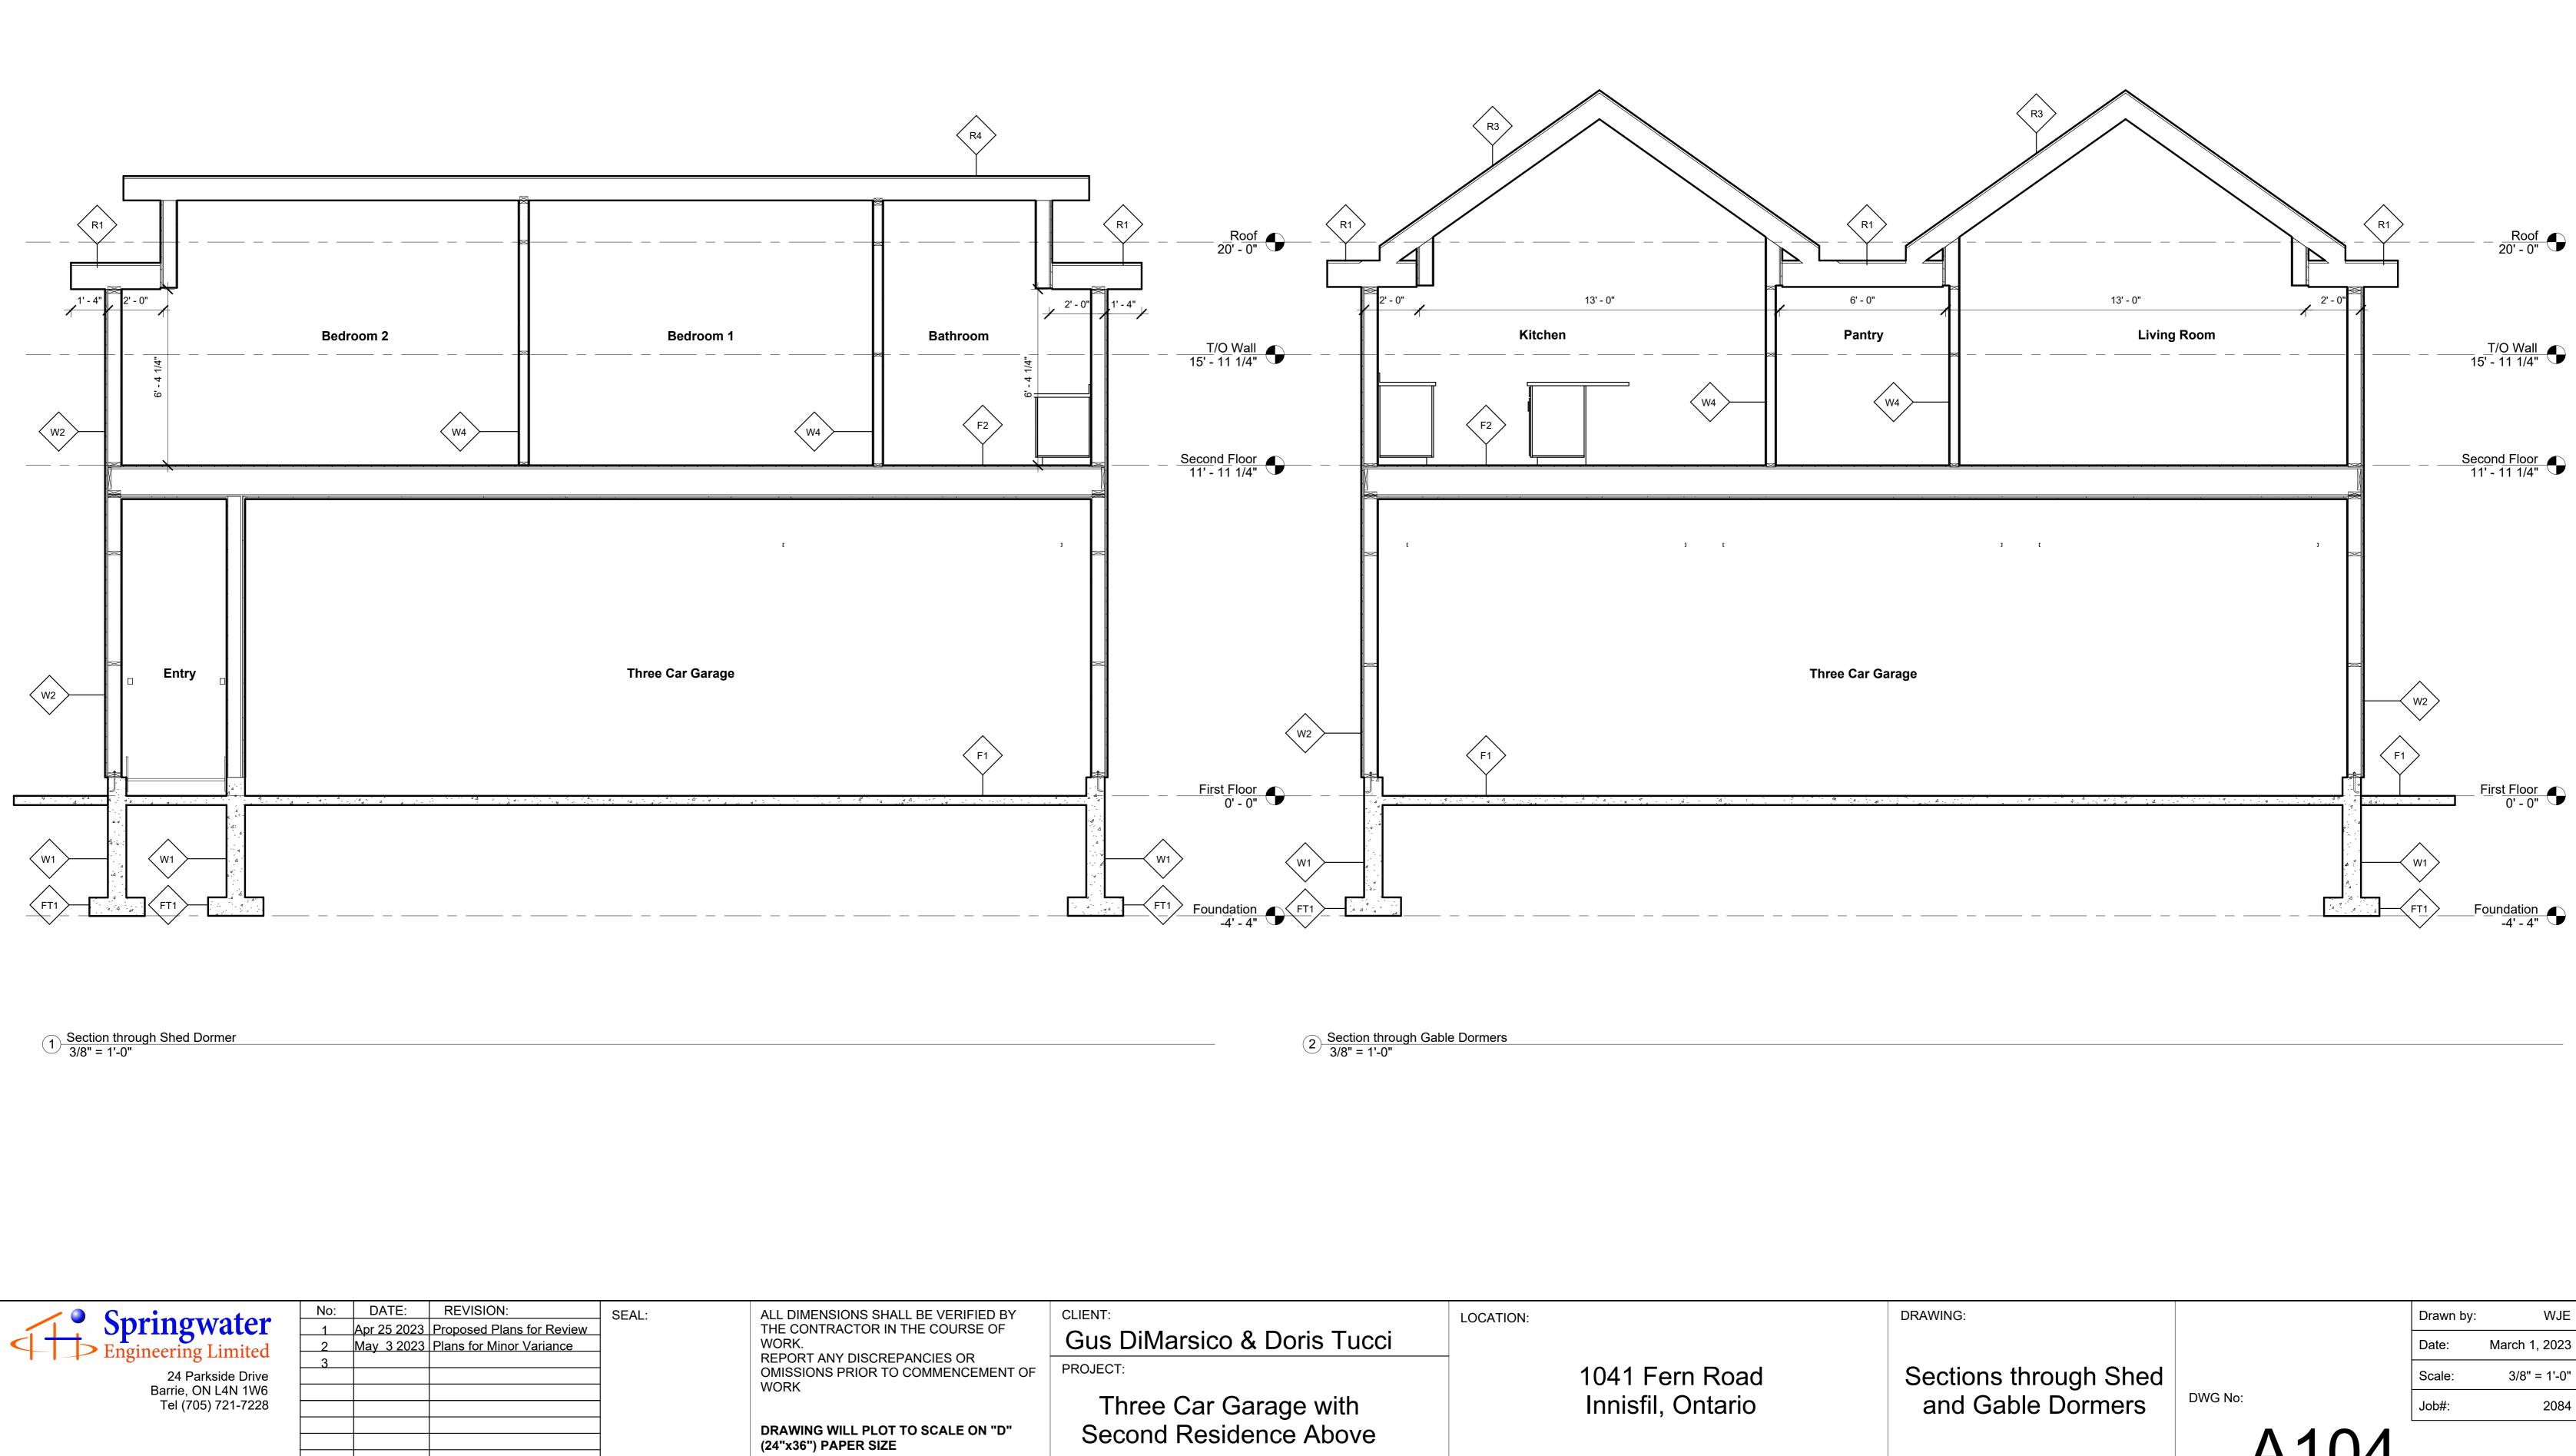


NS SHALL BE VERIFIED BY	CLIENT:	LOCATION:	
TOR IN THE COURSE OF	Gus DiMarsico & Doris Tucci		
DISCREPANCIES OR RIOR TO COMMENCEMENT OF	PROJECT:		1041 Fern Road
L PLOT TO SCALE ON "D" ER SIZE	Three Car Garage with Second Residence Above		Innisfil, Ontario

DRAWING:		Drawn by:	WJE
		Date:	March 1, 2023
Sections through Shed		Scale:	3/8" = 1'-0"
and Gable Dormers	DWG No:	Job#:	2084
	A104		
	H 104		

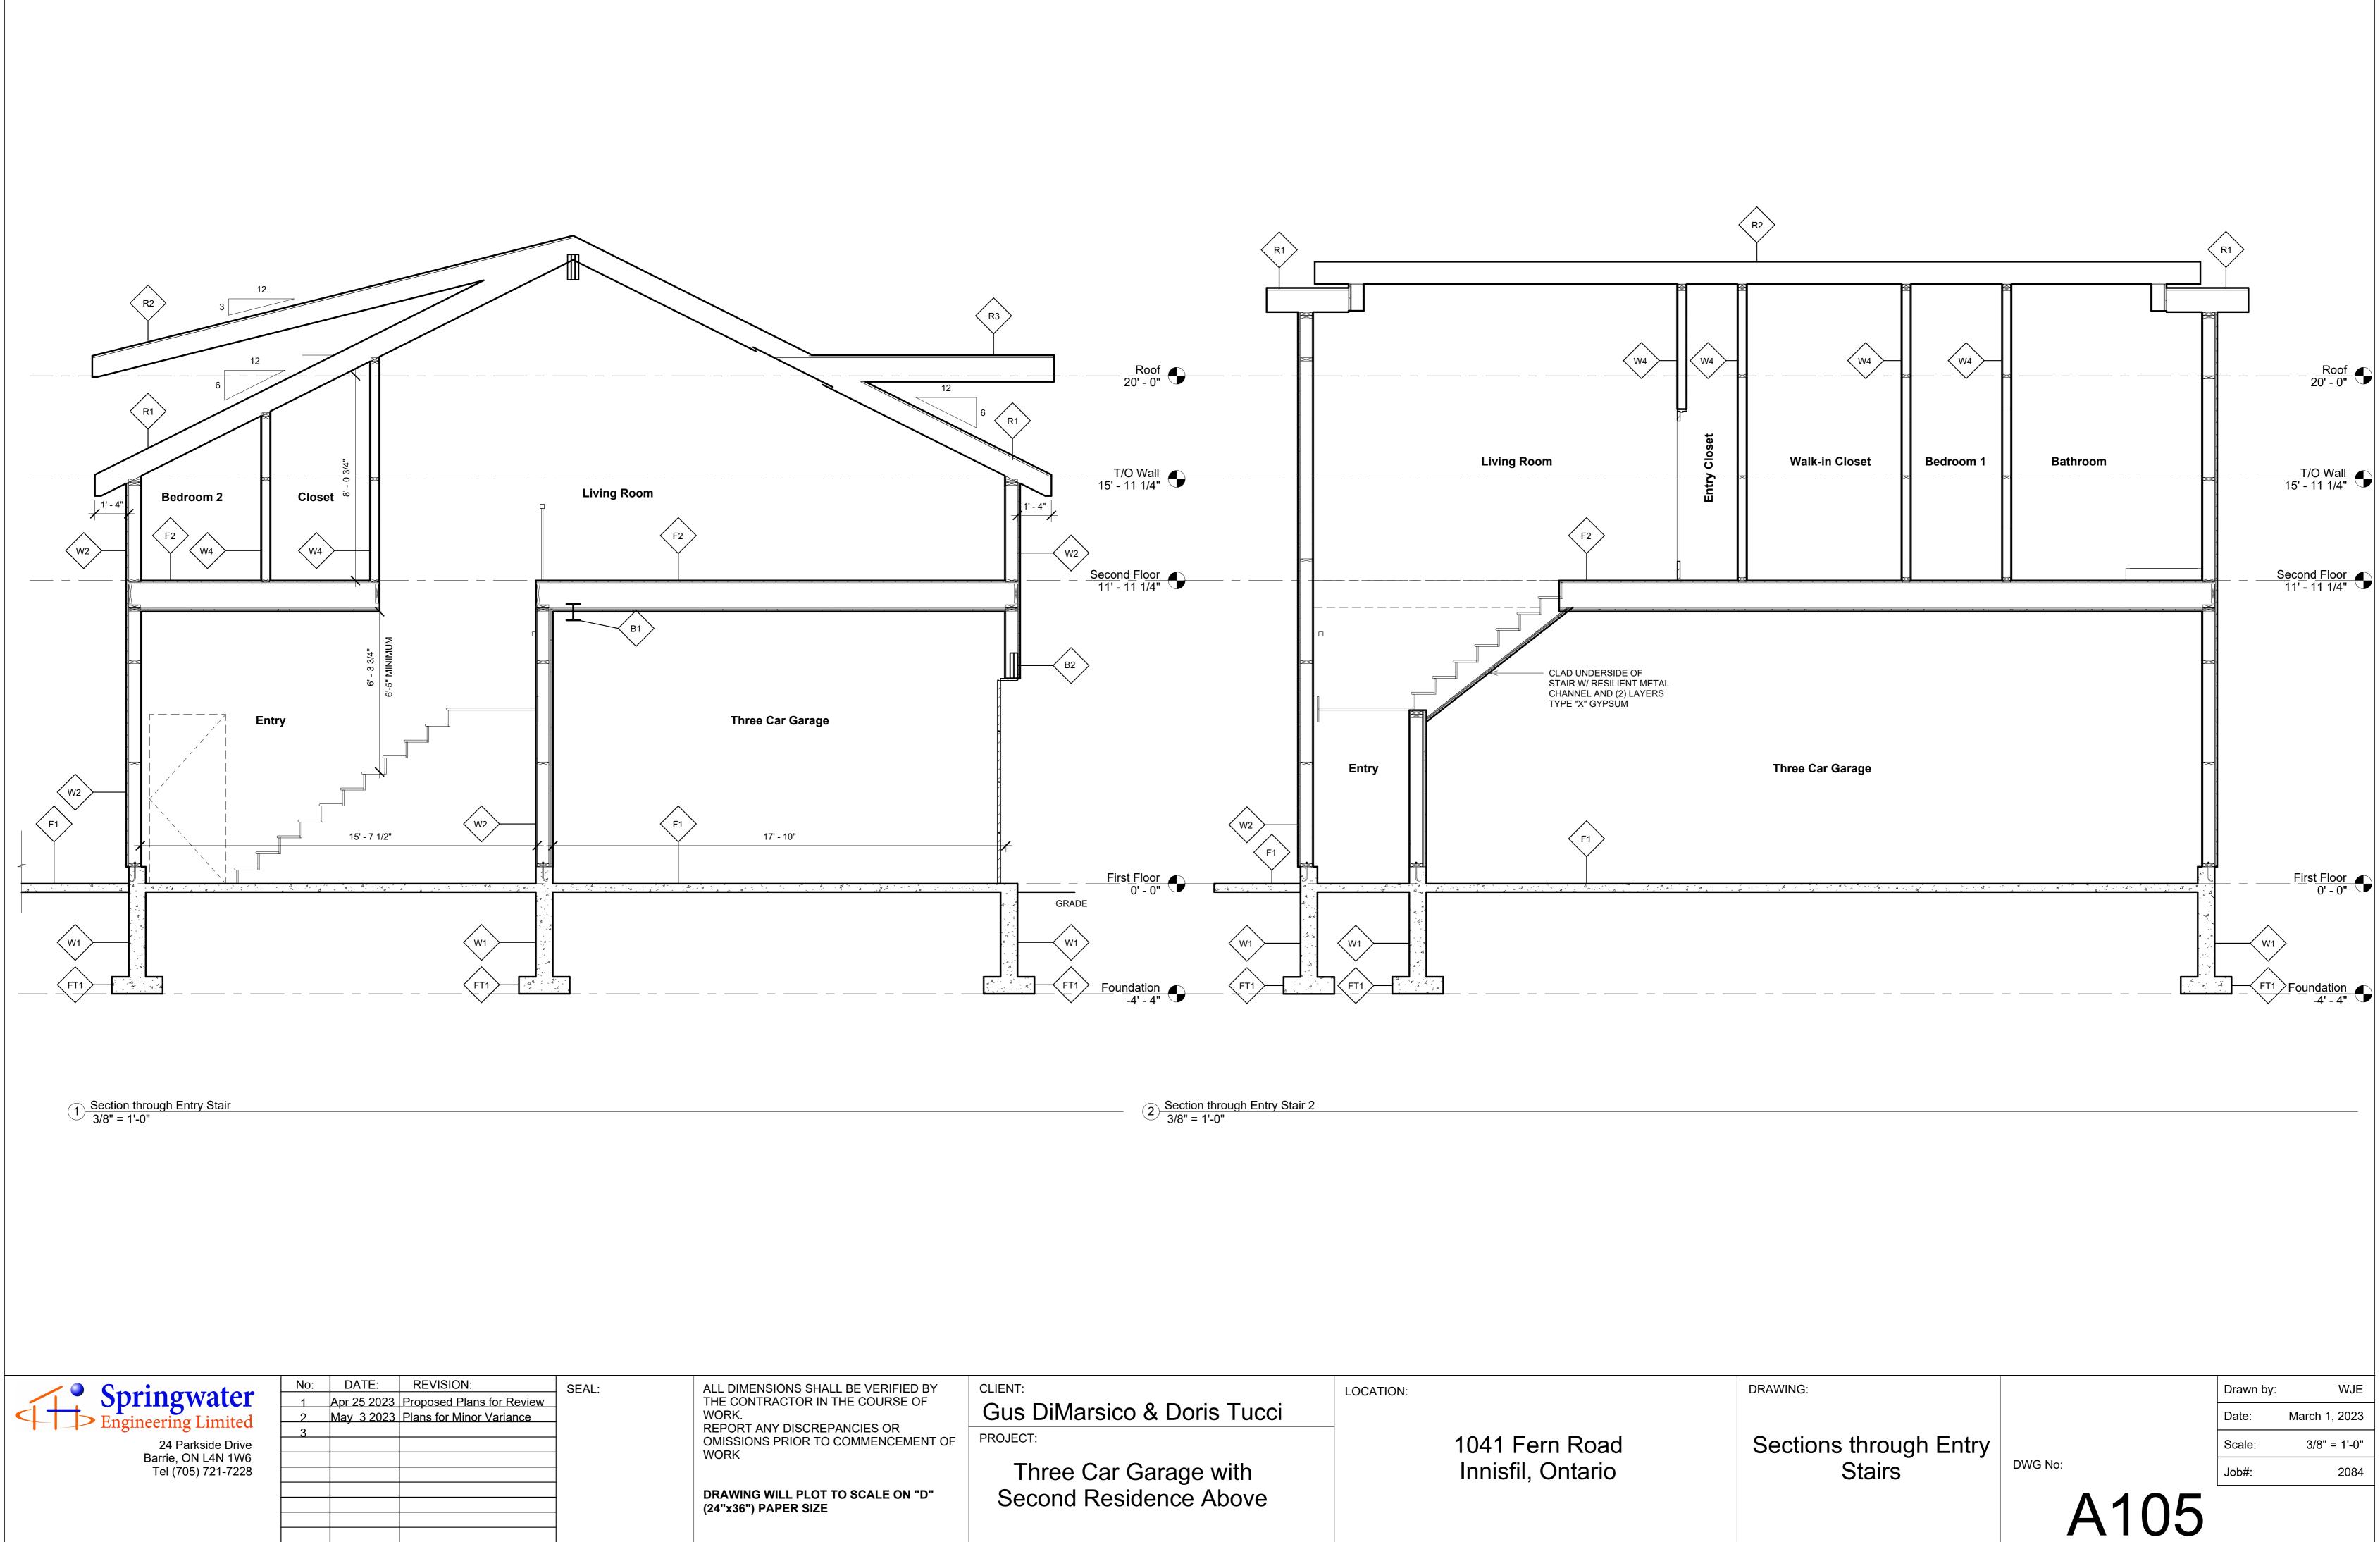

NS SHALL BE VERIFIED BY	CLIENT:	LOCATION:	
TOR IN THE COURSE OF	Gus DiMarsico & Doris Tucci		
DISCREPANCIES OR IOR TO COMMENCEMENT OF	PROJECT:		1041 Fern Road
- PLOT TO SCALE ON "D" R SIZE	Three Car Garage with Second Residence Above		Innisfil, Ontario

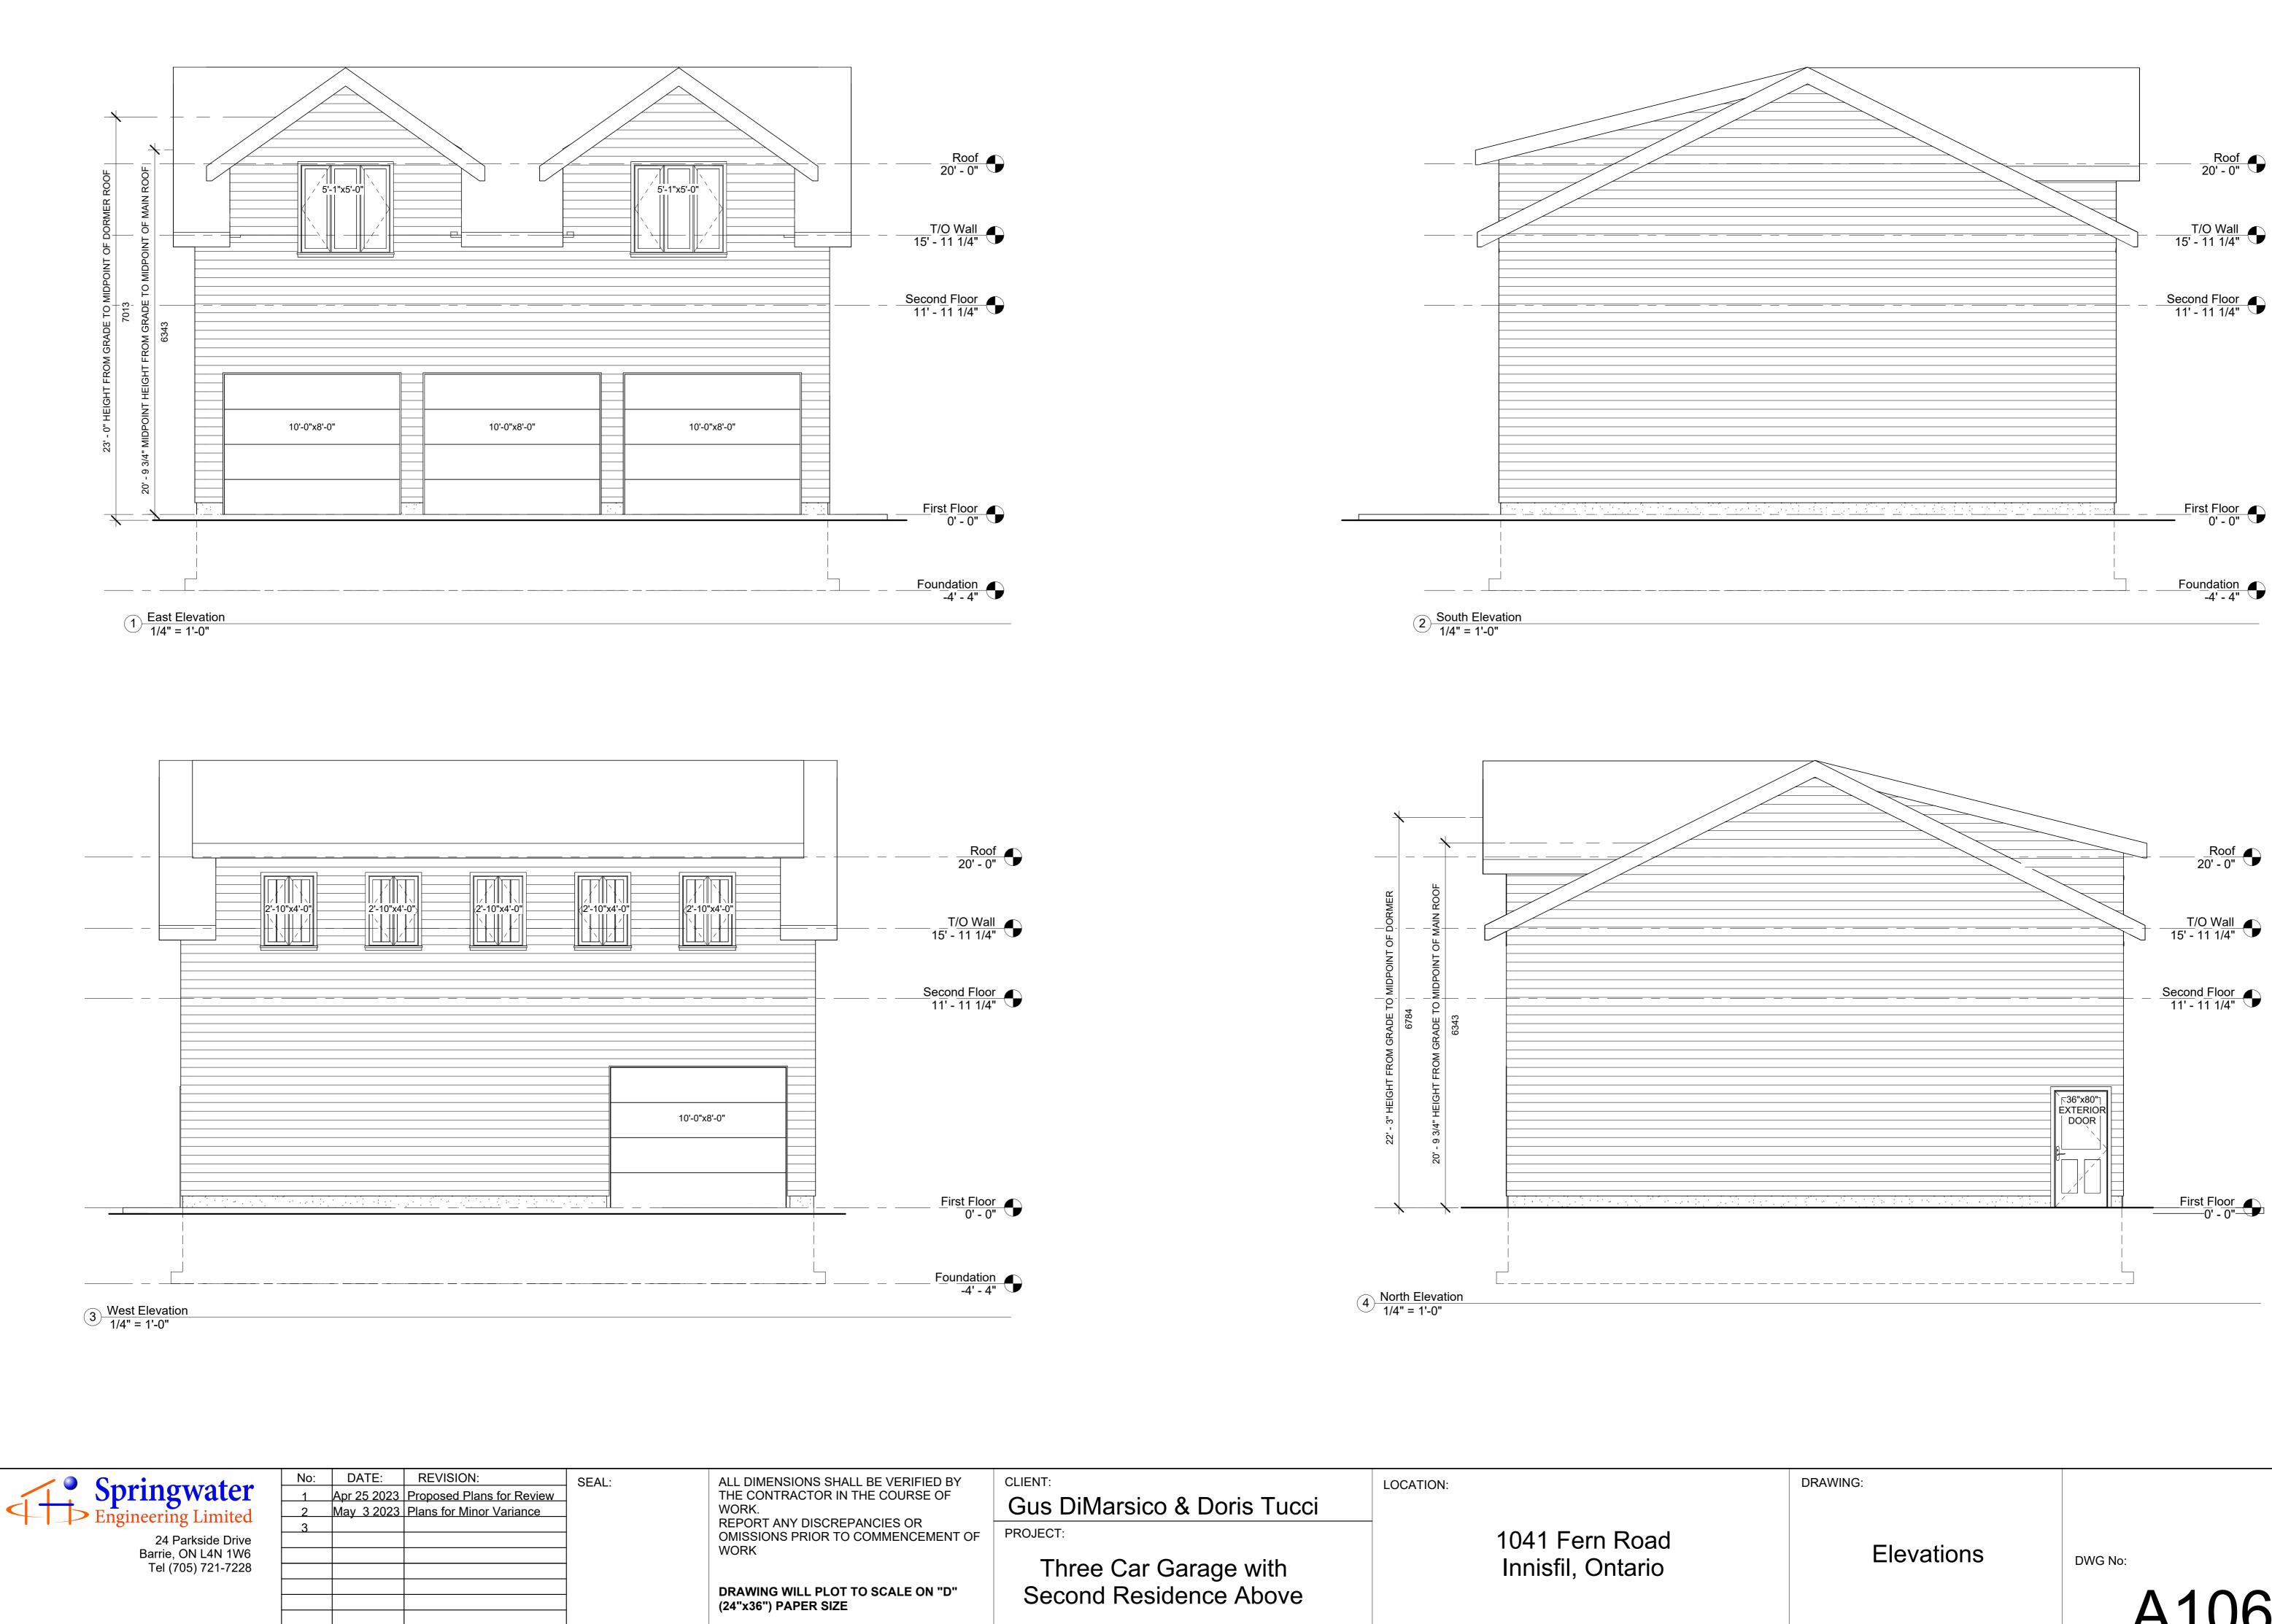


NS SHALL BE VERIFIED BY TOR IN THE COURSE OF	CLIENT:	LOCATION:	
	Gus DiMarsico & Doris Tucci		
ISCREPANCIES OR	PROJECT:		1041 Fern Road
- PLOT TO SCALE ON "D" R SIZE	Three Car Garage with Second Residence Above		Innisfil, Ontario

	DRAWING:		Drawn by:	WJE
			Date:	March 1, 2023
	Flavationa		Scale:	1/4" = 1'-0"
Elevations	DWG No:	Job#:	2084	
		A106		



DRAWING:		Drawn by:	WJE
		Date:	March 1, 2023
Dondoringo		Scale:	
Renderings	DWG No:	Job#:	2084
	A107		

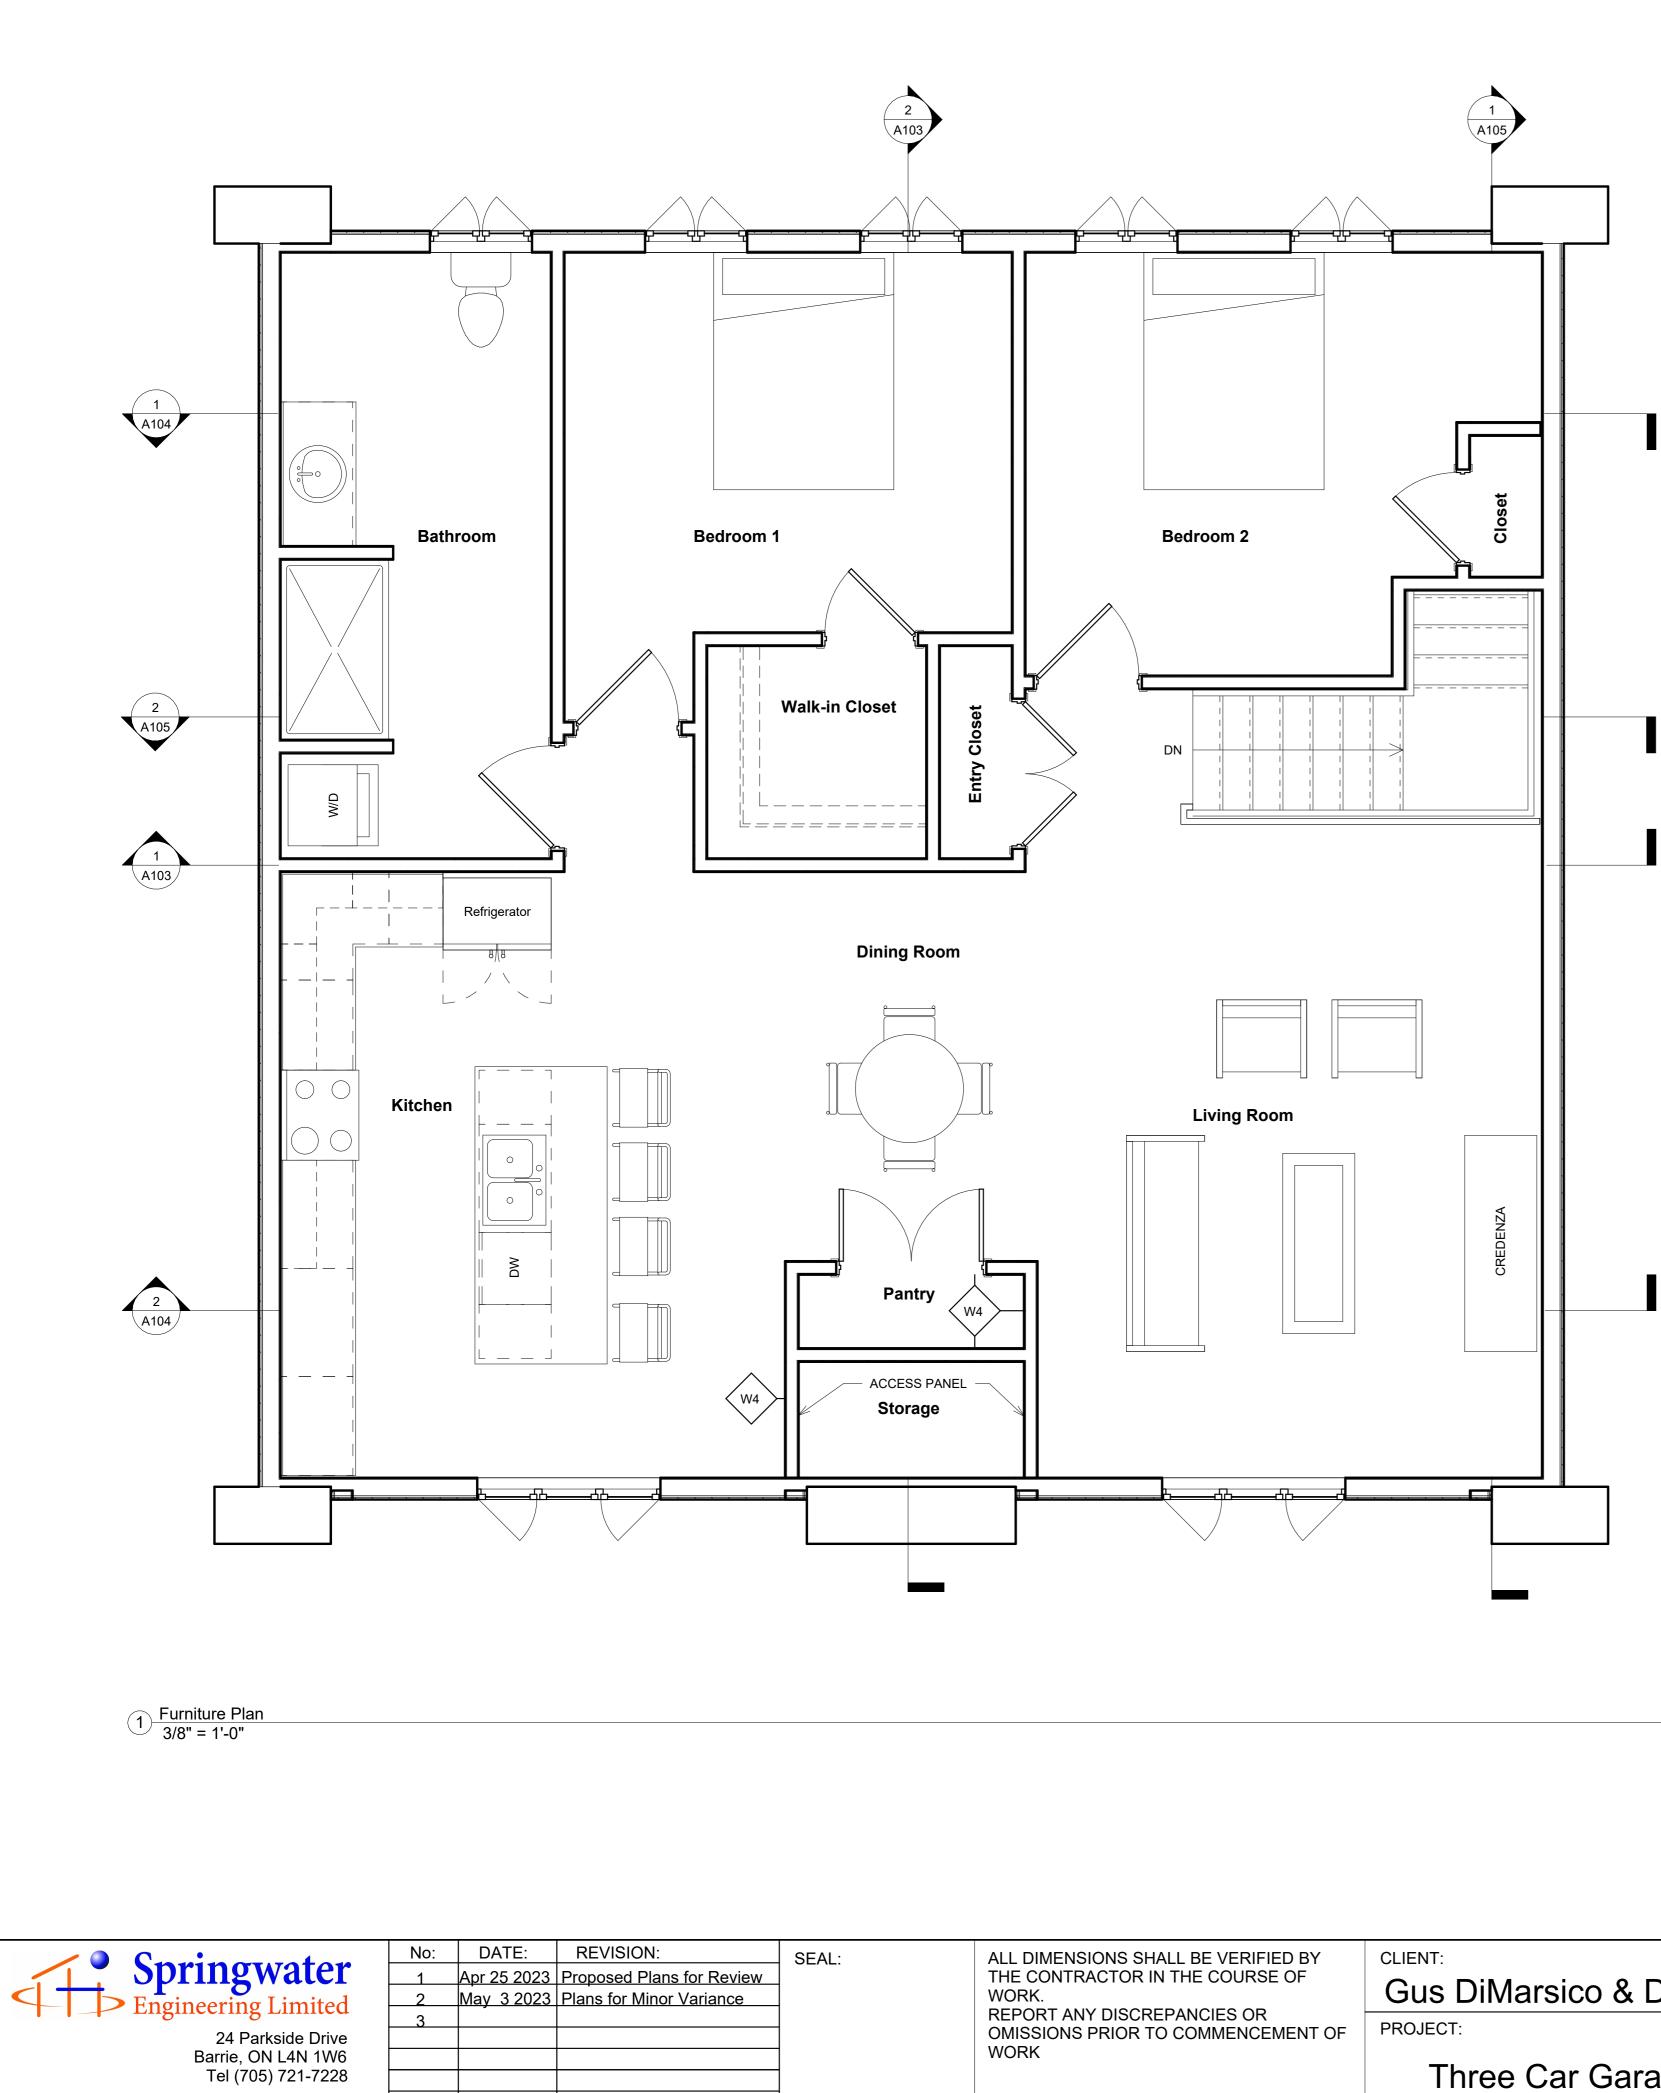

NS SHALL BE VERIFIED BY	CLIENT:	LOCATION:	
TOR IN THE COURSE OF	Gus DiMarsico & Doris Tucci		
DISCREPANCIES OR IOR TO COMMENCEMENT OF	PROJECT:		1041 Fern Road
- PLOT TO SCALE ON "D" R SIZE	Three Car Garage with Second Residence Above		Innisfil, Ontario

DRAWING:		Drawn by:	WJE
		Date:	March 1, 2023
Furniture Plan		Scale:	3/8" = 1'-0"
Furfillure Flan	DWG No:	Job#:	2084
	A108		

							[
FOOTING LEG						1	BEAM LEG	-	I -	1
		TAG SEC	TION 	DESCRIPTION <u>CONTINUOUS FOOTING</u> 24"x8" FOOTING, MIN. 220 PSI (20MPa) CON 28 DAYS, FOOTING TO REST ON UNDISTU OR COMPACTED GRANULAR FILL WITH MI BEARING CAPACITY, FOOTING TO HAVE C	RBED SOIL, ROCK N. 10.9 psi (75 kPa)	REMARKS	SYMBOL	- B1		DESCRIPTION REMARKS FLOOR BEAM W8x21 STEEL BEAM
	- <u>4</u> 	FT2		PAD FOOTING 40"x40"x12" FOOTING W/ 5-15M BOTTOM R COVER (BOTH WAYS) , MIN. 220 PSI (20MP 28 DAYS, FOOTING TO REST ON UNDISTUI OR COMPACTED GRANULAR FILL WITH MI	EBAR WITH 3" a) CONCRETE AFTER RBED SOIL, ROCK			- B2		LVL GARAGE DOOR LINTEL 2 PLY 1 3/4"x 11 7/8" LVL 2900Fb-2.0E BUILT UP W/ 2 ROWS OF 10dx3 1/2" NAILS @ 8" C/C, 3 JACK AND 2 KING STUDS EACH END RIDGE BEAM
			 	BEARING CAPACITY				- B3		?
WALL LEGEND	TAG	SECTION	DESCRIPTION		REMARKS			B4		DORMER SUPPORT RAFTERS (3)2x10
	W1		FOUNDATION 8" POURED CC	WALL DNCRETE WALL	SURFACES OF THE GRADE SHALL BE I	N FROST SUSCEPTIBLE SOIL, FOUNDATION WALL BELOW DAMPPROOFED AS PER	ROOF LEC	GEND TAG	SECTION	DESCRIPTION
			EXTERIOR WA	OWNER	OBC 9.13		-	R1		MAIN ROOF 2x10 ROOF RAFTERS @ 16" O/C 6:12 SLOPE, 16" OVERHANG
	< w2		7/16" EXTERIO 2"x6" STUDS @ R22+5ci INSUL	ATION APOUR BARRIER				R2		SHED DORMER ROOF 2x10 ROOF RAFTERS @ 16" O/C 3:12 SLOPE, 16" OVERHANG
	W3		5/8" "TYPE X" (2"x6" STUDS (3 1/2" THICK A	BSORPTIVE MATERIAL	SB-3 WALL TYPE 1 HOUR FIRE SEP 51 SOUND TRANS	ARATION		R3		GABLE DORMER ROOF 2x10 ROOF RAFTERS @ 16" O/C 8 1/2:12 SLOPE 16" OVERHANG
	W4		R22+5ci INSUL RESILIENT ME 2 LAYERS 5/8" PARTITION WA 1/2" GYPSUM V 2"x4" STUDS @ 1/2" GYPSUM V	TAL CHANNEL @ 24" O/C "TYPE X" GYPSUM WALL BOARD <u>ALL</u> WALL BOARD 9 16" O.C.		-	2 <u>4"</u> E LOC WA INS (d.) WE	CATION & EX ERIOR WALL LL STUDS AL TALLATION (THE LOCATI T WALL PRO	TENT CONDITION NOTES DJACENT TO WA OF GRAB BARS. (ON OF THE BLO(TECTION	EPING TILE WRAPPED WITH FILTER CLOTH SET ON MIN. 6" GRAVEL BED, CONNECT TO STORM DRAINAGE SYSTEM, NS TER CLOSETS AND SHOWER/BATH TUBS IN MAIN BATHROOM ARE TO BE REINFORCED TO PERMIT THE FUTURE DBC 9.5.2.3. THE LOCATION OF THE BLOCKING TO BE INSTALLED FORTHE WATER CLOSET TO MEET OBC 3.8.3.8. (1) CKING TO BE INSTALLED FOR THE SHOWER/BATH TUBS TO MEET OBC 3.8.3.13 (1)(f) UND BATHTUBS AND SHOWERS SHALL BE APPLIED OVER WATERPROOF BACKER BOARD. JOINTS BETWEEN WALL
FLOOR LEGEN	<u> </u>						TILE Tue	ES AND BATH BS AND TILE'	HTUBS SHALL BE	CAULKED WITH MATERIAL CONFORMING TO CGSB 19-GP-22M "SEALING COMPOUND MILDEW RESISTANT FOR
SYMBOL -	TAG	SECTION	- 4" CONCRETE	.AB	DAYS FOR UNREI CONCRETE W/ 5-8 ENTRAINMENT AS <u>FILL</u> ANY FILL PLACED COARSE CLEAN G BE COMPACTED T GRADE. COARSE CONTAINING NOT THAT WILL PASS J BELOW SLAB. MA 9.16.2. <u>DAMPPROOFING</u> DAMPPROOFING SLAB W/ MINIMUM	S PER OBC 9.3.1.6. UNDER SLAB, OTHER THAN GRANULAR MATERIAL, SHALL TO 98% SPMDD. SLOPE TO CLEAN GRANULAR MATERIAL MORE THAN 10% OF MATERIAL A 1/8" SIEVE SHALL BE PLACED TEF.IALS UNDER SLAB AS PER INSTALLED AS PER 9.13.2.6. REQUIRED UNDER BASEMENT 10.05mm THICK POLY OR TYPE TERIAL W/ JOINTS LAPPED	3 LIG 3-W 3-W STA 4 EXT AN ENT 5 MAI TO PRO 6 SMM OBO OBO 7 CAF OBO ALA 8 EXH	CATIONS OF <u>HTING</u> (AY SWITCHE AIRWAYS WIT <u>FERIOR LIGH</u> EXTERIOR L ITRANCE TO B IN DOOR BE OPERABI OVIDED IN DO <u>OKE ALARMS</u> C 9.10.18. RE C 9.10.19.3. (I C 9.10.19.5. S <u>RBON MONO</u> C 9.33.4 WHE ARM WILL SO <u>HAUST</u>	WATERPROOF V ES LOCATED AT TH 4 OR MORE R ITH 4 OR MORE R IGHTING OUTLE BUILDINGS OF R UILDINGS OF R COURES AUDIBLI OOR OR A SIDEL SOURES AUDIBLI DONE SMOKE A SMOKE ALARMS CUIDE DETECTOR RE THERE IS A SOUND	SOLID FUEL BURNING APPLIANCE A CMD SHALL BE PROVIDED, CMD TO BE WIRED SO WHEN ACTIVATED THE SMOKE
-	F2		3/4" T&G SUB 2"x10" FLOOR 9 1/4" THICK / R31 INSULAT RESILIENT M	LJOISTS @ 16" O.C. ABSORPTIVE MATERIAL	EXTERIOR WALLS	ARATION	9 WIN (10) ROO OBC	ANGE PER H IDOW REQU NG ROOM & <u>OF VENTILAT</u> C 9.19.1.1. & 0	OUR <u>IREMENTS</u> DINING ROOM R <u>FION</u>	EXTERIOR FOR BATHROOMS 9.32.3.4. WASHROOMS TO BE MECHANICALLY VENTED TO PROVIDE AT LEAST ONE AIR REQUIRES 10% OF AREA OF NATURAL LIGHT. BEDROOM REQUIRES 5% OF NATURAL LIGHT PICAL ROOF 1/300 OF INSULATION CEILING AREA WITH MIN. 25% AT SOFFIT, CATHEDRAL ROOF 1/500 OF INSULATION I SOFFIT
COLUMN LE	GEND TAG	SECTION	DESCRIPTIO		REMARKS		(11) <u>INT</u>	ERIOR / EXT	ERIOR STAIRS	
	C1		<u>12" x12" PIER</u> 4'-0" MIN. BEI		REWIARKS		Min Min Min Rai Rai Nin <u>Int</u> Ob(Fin Ag <i>i</i>	I. RISE 125mi I. RUN 255mr I. NOSING 25 I. HEADROOI L HEIGHT AT L HEIGHT AT I. STAIR WID <u>ERIOR / EXTI</u> C 9.8.7. ISHED NATU AINST AN INT	m (4 7/8"), MAX. F n (10"), MAX. RUN imm (1") M 1.95m (6'-5") T LANDING 1070m STAIRS MIN. 863 TH BETWEEN GL ERIOR HANDRAII RAL WOOD HAN FERIOR WALL TH	nm (42.12") 5mm (34"), MAX. 965mm (38") JARDS 900mm (36")
							RE0 EX1	QUIRED IN AI	NY ÓTHER INTEF DRAIL / GUARDS	ARE REQUIRED WHERE STEPS HAVE MORE THAN 3 RISERS AND SHALL BE MIN. 900mm (36") UNLESS WHERE HEIGHT XCEEDS 5'-11", EXTERIOR GUARDS SHALL BE 1070mm (42.12") IN HEIGHT
POST LEGEN SYMBOL	ID TAG;	SECTION	DESCRIPTIO	N	REMARKS		NO <u>GU/</u>	MEMBER FC ARDS	ORMING PART OF	GUARD BETWEEN 140mm (5 1/2") and 900mm (36") ABOVE FLOOR SURFACE SHALL FACILITATE CLIMBING
	P1	> 	HSS POST 3 1/2"x3 1/2"x7 6 1/2"x8"x3/4" 8"x8"x1/2" BO				9.8. <u>DAN</u> WO 0.05	8.6.(2) DESIG MPROOFING OD FRAMING 5mm POLYET	GNED TO PREVER <u>STAIRS</u> G NOT TREATED	WITH A PRESERVATIVE IN CONTACT WITH CONCRETE SHALL BE SEPARATED FROM THE CONCRETE WITH A MIN. OF YPE (5) 45# ROLL ROOFING OR OTHER DAMPROOFING MATERIAL, EXCEPT WHERE THE WOOD MEMBER IS AT LEAST
								<u>CHEN EXHAL</u> PPED RANGE		T DIRECTLY TO EXTERIOR AS PER 9.10.22
								TSIDE THRO	VENT AS PER 9	.32, 6.2.3.8. CLOTHES DRYER TO BE CAPPED TO PREVENT BACK DRAFT. TO BE DISCHARGED DIRECTLY TO THE WALL WITH DUCT INDEPENDENT OF OTHER EXHAUST DUCTS. INSTALLED SUCH THAT THE ENTIRE DUCT CAN BE SMOOTH CORROSION RESISTANT MATERIAL

Springwater Engineering Limited 24 Parkside Drive Barrie, ON L4N 1W6 Tel (705) 721-7228	No:DATE:REVISION:1Apr 25 2023Proposed Plans for Review2May 3 2023Plans for Minor Variance3	SEAL:	ALL DIMENSIONS SHALL BE VERIFIED BY THE CONTRACTOR IN THE COURSE OF WORK. REPORT ANY DISCREPANCIES OR OMISSIONS PRIOR TO COMMENCEMENT OF WORK DRAWING WILL PLOT TO SCALE ON "D"	CLIENT: Gus DiMarsico & Doris Tucci PROJECT: Three Car Garage with Second Residence Above	LOCATION:	1041 Fern Road Innisfil, Ontario
			DRAWING WILL PLOT TO SCALE ON "D" (24"x36") PAPER SIZE	Second Residence Above		

BATCHING. PRODUCTS 2. NOMINAL MAXIMUM COARSE AGGREGATE SIZE - 1/2". 4. WELDED WIRE FABRIC TO CONFORM TO CSA G30.5. 6. CONCRETE MINIMUM COMPRESSIVE STRENGTH AT 28 DAYS SHALL BE AS FOLLOWS:

GENERAL NOTES:

SPRINGWATER ENGINEERING.

SYSTEM, LINTELS ONLY.

S = 1.775 kPa S = 37.07 psf

LOCATION: INNISFIL, ONTARIO DEAD LOAD: 0.72 kPa (15 psf) LIVE LOAD: 2.4 kPa (50 psf) Ss = 2.5 kPa / Sr = 0.4 kPa S = (0.55*2.5)+0.4 = 1.775 kPa

FOUNDATIONS / BACKFILLING AND COMPACTION

PROTECT EXCA
KEEP EXCAVAT
LINI ESS OTHER

	- 1
PROVIDE POS	ľ
	л

PROV	/IDE	PERII
DENS	SELY	COM

WOOD FRAMING NOTES:
1. WOOD CONSTRUCTION SHALL
2. LUMBER: - UNLESS OTHERWISI
THE TIME OF INSTALLATION. ALL
3. UNLESS NOTED OTHERWISE, A
4. COMPLY WITH THE REQUIREM
9.23.16.A.

5. NAILS, SPIKES, AND STAPLES:
FRAMING UNLESS OTHERWISE N
6. ROUGH HARDWARE: - BOLTS, N
7. WOOD PRESERVATIVES (PRES
BELOW GRADE TO BE PRESSURE
8. ALL WOOD PRODUCT EXPOSE
9. FRAMING ANCHORS: - FRAMING
STRUCTURAL DRAWINGS, ARE AI
INSTALLED IN STRICT ACCORDAN
10. SPLICES, NOTCHING, AND DR
11. MANUFACTURED LUMBER OR
INSTALLED AS PER THE MANUFA
12.NUMBER, SIZE, AND LOCATION
ONTARIO BUILDING CODE PART §
13. MINIMUM BEARING OF WOOD
14. MINIMUM BEARING OF WOOD
15. MINIMUM BEARING OF WOOD
16. ALL MULTIPLE WOOD MEMBEI

STEEL NOTES

TEELINUTES
. ALL STRUCTURAL STEEL SHAL
. ALL STRUCTURAL STEEL SHAL
. ALL STRUCTURAL STEEL (UNL
LATES, CHANNELS AND ANGLES
. ALL BEARING PLATES ARE TO
. ALL STRUCTURAL STEEL SHAL
CCORDANCE WITH THE REQUIR

6. ALL WELDING SHALL BE CARR
lo.2.
7. UNLESS NOTED OTHERWISE, A

5. ALL DULTS, NUTS AND WASHE
9. ALL ANCHOR BOLTS, NUTS ANI
10. ALL BASE PLATED SHALL BE G
11. NO HOLES SHALL BE CUT IN S
12. INSPECTION AND TESTING OF
ACCORDANCE WITH CAN/CSA-S16
13. SPLICES IN STEEL MEMBERS (
14. ALL WELDED JOINTS IN ARCHI
15. TOUCH UP SHOP PRIMER TO E
16. WE RECOMMEND THAT ALL EX

1. THIS DRAWING SET IS THE PROPERTY OF SPRINGWATER ENGINEERING LIMITED (SEL) AND MAY NOT BE REPRODUCED OR USED WITHOUT THE EXPRESSED WRITTEN CONSENT OF

2. ALL DRAWINGS TO BE READ IN CONJUNCTION WITH GENERAL NOTES AND SPECIFICATIONS. 3. DO NOT SCALE DRAWINGS. CONTRACTOR TO VERIFY ALL EXISTING CONDITIONS. CONTRACTOR TO VERIFY ALL LEVELS AND DIMENSIONS PROVIDED AND REQUIRED TO PERFORM THE WORK. ANY DISCREPANCIES ARE TO BE REPORTED TO SPRINGWATER ENGINEERING IMMEDIATELY TO OBTAIN CLARIFICATION PRIOR TO COMMENCING WORK. 4. DESIGN LOADS ARE NOTED. THEY SHALL NOT BE EXCEEDED DURING CONSTRUCTION. UNLESS SPECIFICALLY NOTED OTHERWISE ON THE DRAWINGS, NO PROVISION HAS BEEN MADE IN THE DESIGN FOR CONDITIONS OCCURRING DURING CONSTRUCTION. THE CONTRACTOR IS TO PROVIDE ALL NECESSARY BRACING AND SHORING REQUIRED FOR STRESSES AND INSTABILITY OCCURRING FROM ANY CAUSE DURING CONSTRUCTION.

5. NO SUBSTITUTIONS. CONTRACTOR AGREES TO USE ALL SPECIFIED MATERIALS WITHOUT SUBSTITUTION. NON SPECIFIED MATERIALS MUST BE APPROVED SPRINGWATER ENGINEERING PRIOR TO USE. NON SPECIFIED OR APPROVED MATERIALS WILL BE REMOVED AND REPLACED WITH SPECIFIED MATERIALS AT CONTRACTOR'S COST. 6. THE CONTRACTOR SHALL BE SOLELY RESPONSIBLE FOR CONSTRUCTION MEANS, METHODS, TECHNIQUES, SEQUENCES, AND PROCEDURES AND FOR CO-ORDINATING THE VARIOUS PARTS OF THE WORK. ADDITIONAL COSTS INCURRED AS A RESULT OF ANY OF THE ABOVE ARE THE RESPONSIBILITY OF THE CONTRACTOR. 7. TYPICAL STRUCTURAL DETAILS ARE SHOWN ON DRAWINGS. IF DETAILS DIFFER ON OTHER DRAWINGS, THE MOST STRINGENT SHALL GOVERN. ALL WORK SHALL BE CARRIED OUT IN ACCORDANCE WITH THE REQUIREMENTS OF THE ONTARIO BUILDING CODE 2012 (OBC 2012) AND THE OCCUPATIONAL HEALTH AND SAFETY ACT. 8. PROVIDE ALL ACCESSORY ITEMS OR MATERIALS, SUCH AS BRACKETS, CLEATS, UNDERLAYS, OVERLAYS, CONNECTORS, FASTENERS, COVER PLATES, SEALANTS, LUBRICANTS, CLEANERS, BONDING AGENTS, AND SIMILAR ITEMS, WHETHER SPECIFIED OR NOT, SO THAT THE WORK IS COMPLETE AND WILL PERFORM AS REQUIRED. 9. SPRINGWATER ENGINEERING LIMITED'S SCOPE IS LIMITED TO STRUCTURAL DESIGN AND DETAILS OF THE PROPOSED NEW WALLS, SLAB ON GRADE, FLOOR SYSTEM, ROOF

CAST-IN-PLACE CONCRETE AND REINFORCEMENT

1. ALL CONCRETE CONSTRUCTION SHALL CONFORM TO CSA A23.1, CSA A23.2 AND CSA A23.3. 2. CONCRETE QUALITY IS TO BE TESTED BY THE OWNERS' AGENCY ACCORDING TO CSA A23.2 INCLUDING STRENGTH, AIR CONTENT AND SLUMP TESTS FOR EACH CONCRETE POUR, WITH REPORTS SUBMITTED TO THE ENGINEER.

3. THE CONTRACTOR SHALL NOT PROCEED WITH PLACING CONCRETE THAT FAILS TO MEET THE SPECIFIED SLUMP OR AIR CONTENT REQUIREMENTS OR EXCEEDS 2 HOURS AFTER

1. PORTLAND CEMENT, WATER AND AGGREGATES SHALL CONFORM TO CSA A23.1 AND SHALL HAVE THE FOLLOWING PROPERTIES:

3. REINFORCING STEEL SHALL BE DEFORMED BARS CONFORMING TO CSA G30.18 - GRADE 400 MPA UNLESS NOTED OTHERWISE

5. REINFORCING STEEL SHALL BE DETAILED, BENT, PLACED AND SUPPORTED IN CONFORMANCE WITH CSA A23.3, ACI STANDARD 315 AND THE REINFORCING STEEL - MANUAL OF STANDARD PRACTICE PUBLISHED BY THE REINFORCING STEEL INSTITUTE OF CANADA.

A. EXTERIOR SLABS ON GRADE, FLATWORK 32 MPA WITH 5-8% AIR ENTRAINMENT

EXECUTION: 1. UNLESS NOTED OTHERWISE CONCRETE COVER FOR REINFORCEMENT SHALL MEET THE FOLLOWING REQUIREMENTS: A. WHEN CAST AGAINST EARTH 75MM (3") 2. PROVIDE CORNER BARS AND HOOKED DOWELS (26"x26") AT CORNERS. 3. ADD FLOOR HARDENERS, WATERPROOFING AGENTS IF REQUIRED PER OWNER'S PREFERENCE.

1. ALL FOOTINGS TO BEAR ON COMPACTED GRANULAR ON UNDISTURBED SOIL WITH MINIMUM ALLOWABLE SOIL BEARING CAPACITY OF 150KPA.

EXECUTION: 1. REMOVE TOPSOIL AND OTHER ORGANIC MATERIAL FROM THE BUILDING AREA. AVATED SURFACE FROM WATER OR FROST DAMAGE, WHERE APPLICABLE.

TIONS CONTINUOUSLY DRY BEFORE CONCRETE IS PLACED.

ERWISE NOTED, PROVIDE IMMEDIATELY UNDER SLABS-ON-GRADE A MINIMUM OF 150MM (6 ") OF COMPACTED GRANULAR A MATERIAL SITIVE DRAINAGE FOR ALL EXTERIOR SURFACES, AND INTERIOR SURFACES PROVIDED WITH DRAINS, WITH CONSTANT SLOPES TO DRAINS OR DRAINAGE COURSES, AND AWAY FROM CONSTRUCTION. 6. PROVIDE PERIMETER DRAINING TILE WHERE SURROUNDING SOIL IS NOT FREE DRAINING.

IPACTED GRANULAR BASE OVER BEDROCK

CONFORM TO ONTARIO BUILDING CODE 2012, PART 9 UNLESS NOTED OTHERWISE.

E NOTED TO BE SPRUCE-PINE-FIR (SPF), GRADE NO.1/NO.2, CONFORMING TO CSA STANDARD 0141 WITH A MAXIMUM MOISTURE CONTENT OF 19 % AT LUMBER SHALL BEAR THE GRADING STAMP OF AN AGENCY APPROVED BY THE CANADIAN LUMBER STANDARDS ADMINISTRATION BOARD. ALL TIMBER MEMBERS TO BE DOUGLAS FIR #1 GRADE.

IENTS OF ONTARIO BUILDING CODE FOR SUB-FLOORING IN TABLE 9.23.14.A, ROOF SHEATHING IN TABLE 9.23.15.A, AND WALL SHEATHING IN TABLE 5. NAILS, SPIKES, AND STAPLES: - TO CSA STANDARD B111; GALVANIZED FOR EXTERIOR WORK, OR HIGHLY HUMID AREAS AND FOR TREATED LUMBER; PLAIN ELSEWHERE. NAILING OF

NOTED, SHALL CONFORM TO TABLES 9.23.3 A, B, AND 9.23.13 A IN THE ONTARIO BUILDING CODE. NUTS, WASHERS, LAGS, PINS, SCREWS, ALL TO BE HOT DIP GALVANIZED IF EXPOSED TO EXTERIOR USE.

SSURE TREATED): - WHERE REQUIRED TO CONFORM TO CSA STANDARD 080-M. ALL WOOD PRODUCTS BEARING ON CONCRETE OR MASONRY AT OR E TREATED OR BE PROTECTED WITH A MINIMUM 0.05 POLYETHYLENE VAPOUR BARRIER, ROLL ROOFING, OR APPROVED EQUIVALENT. D DIRECTLY TO SOIL SHALL BE PRESSURE TREATED.

IG ANCHORS, JOIST HANGERS, BEAM HANGERS, POST CAPS, POST ANCHORS, BACK-UP CLIPS AND ANGLES, UNLESS OTHERWISE SHOWN ON THE ALL TO BE AS MANUFACTURED BY SIMPSON OR AN APPROVED EQUAL, AND SIZED APPROPRIATELY FOR THE CONNECTING MEMBERS. ALL ARE TO BE NCE WITH THE MANUFACTURER'S INSTRUCTIONS AND SPECIFICATIONS UTILIZING NAILS OR SCREWS WHERE REQUIRED. RILLING THROUGH MEMBERS IS NOT PERMITTED EXCEPT AS SPECIFIED BY THESE PLANS AND/OR AS APPROVED BY THE ENGINEER. R TIMBER PRODUCTS NOT SPECIFIED HEREIN ARE TO BE APPROVED BY THE ENGINEER PRIOR TO USE. MANUFACTURED WOOD PRODUCT TO BE

ACTURER'S SPECIFICATIONS AND INSTRUCTIONS. N OF BRACING, BLOCKING, AND BRIDGING BETWEEN LUMBER OR TIMBER STRUCTURAL ELEMENTS TO CONFORM TO THE REQUIREMENTS IN THE

JOISTS TO BE MINIMUM 1.5" (38mm). D BEAMS TO BE MINIMUM 3" (76mm).

ELEMENTS NOT SPECIFIED TO BE MINIMUM 3" (76mm).

ERS SHALL BE BUILT-UP IN ACCORDANCE WITH OBC 2012, PART 9 OR PER MANUFACTURER'S SPECIFICATIONS AND GUIDELINES. 17. PROVIDE ALL WOOD AND BRICK LINTELS PER OBC 2012, PART 9.

LL BE NEW STOCK.

LL BE FABRICATED AND ERECTED TO THE REQUIREMENTS OF CAN/CSA-S16.1.

LESS NOTED OTHERWISE) SHALL CONFORM TO THE REQUIREMENTS OF CAN/CSA-G40.2-/G40.21. GRADE 350W. ALL STEEL S SHALL CONFORM TO THE REQUIREMENTS OF CAN/CSA-G40.20/G40.21, GRADE 300W.

) BE CENTERED UNDER BEAMS, UNLESS OTHERWISE DETAILED ON THE STRUCTURAL DRAWINGS. LL BE CLEANED, REPAIRED AND RECEIVE ONE SHOP COAT AND FIELD TOUCH UP OF APPROVED PRIMER PAINT, IN

IREMENTS OF CAN/CSA-S16.1. RIED OUT IN ACCORDANCE WITH CAN/CSA W59 BY A FABRICATOR FULLY APPROVED UNDER CAN/CSA W47.1 DIVISION No.1 OR

ALL WELDS TO BE 1/4" ALL AROUND FILLET WELDS.

8. ALL BOLTS, NUTS AND WASHERS FOR STRUCTURAL STEEL CONNECTIONS SHALL CONFORM TO ASTM A325M.

ND WASHERS SHALL CONFORM TO ASTM A36 OR ASTM A307.

GROUTED SOLID WITH 38mm NON-SHRINK GROUT. STRUCTURAL STEEL WITHOUT THE PRIOR APPROVAL OF THE ENGINEER.

F STRUCTURAL STEEL FRAMEWORK (SUCH AS, BUT NOT LIMITED TO, BOLT TORQUE, WELD QUALITY, ALIGNMENT) SHALL BE IN 16.1 AND CSA W59 BY A QUALIFIED INSPECTION COMPANY.

OTHER THAN THOSE SHOWN ON THE DRAWINGS SHALL NOT BE PERMITTED.

IITECTURALLY EXPOSED STRUCTURAL STEEL SHALL BE GROUND SMOOTH AND SHALL HAVE ALL WELD SPLATTER REMOVED. BOLTS, WELDS AND FURNED AND SCRATCHED SURFACES AT COMPLETION OF ERECTION. XTERIOR STRUCTURAL STEEL TO BE GALVANIZED, PRIMED AND PAINTED WITH TWO COATS OF RUST-INHIBITIVE PAINT FOR BETTER DURABILITY. FINAL DECISION OF THE STRUCTURAL FINISH SHALL BE MADE BY THE OWNER.

DRAWING:		Drawn by:	WJE
		Date:	March 1, 2023
Legends, Notes		Scale:	As indicated
Legend and Notes	DWG No:	Job#:	2084
	A109		