



COMMITTEE OF ADJUSTMENT NOTICE OF PUBLIC HEARING APPLICATION NO. A-067-2022

TAKE NOTICE that an application has been received by the Town of Innisfil from **Paul Magee, Owner,** for a minor variance from Zoning By-law 080-13, pursuant to Section 45 of the *Planning Act*, R.S.O. 1990, c. P.13, as amended.

The subject property is described legally as **PLAN 1032 LOT 6**, is known municipally as **3339 Mason Drive**, and is zoned as "**Residential 1 Zone (R1)**".


The applicant is proposing to construct a detached garage with a width of 7.32 m. The applicant is seeking relief from Section 3.18.3(d) of the Zoning By-law which permits a maximum interior width of a private garage up to 50% of the width of the main wall of the principal building.

The Committee of Adjustment for the Town of Innisfil will consider this application through a conference call on **Thursday**, **January 19**, **2023**, **at 6:30 PM**.

To participate in the hearing and/or provide comments, you must register by following the link below or scanning the above QR code: https://innisfil.ca/en/building-and-development/committee-of-adjustment-hearings.aspx

Requests can also be submitted in writing to: Town of Innisfil Committee of Adjustment, 2101 Innisfil Beach Road, Innisfil, Ontario, L9S 1A1 or by email to planning@innisfil.ca.


If you wish to receive a copy of the decision of the Committee of Adjustment in respect of the proposed minor variance, you must make a written request to the Secretary-Treasurer of the Committee of Adjustment by way of email or regular mail. The Notice of Decision will also explain the process for appealing a decision to the Local Planning Appeal Tribunal.

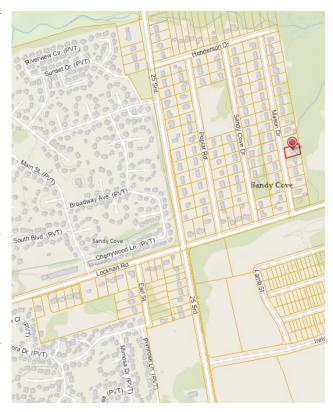

Additional information relating to the proposed application is available on the Town of Innisfil website. Accessible formats are available on request, to support participation in all aspects of the feedback process. To request an alternate format please contact Planning Services at planning@innisfil.ca.

Dated: January 3, 2023

Toomaj Haghshenas, Secretary-Treasurer thaghshenas@innisfil.ca 705-436-3710 ext. 3316

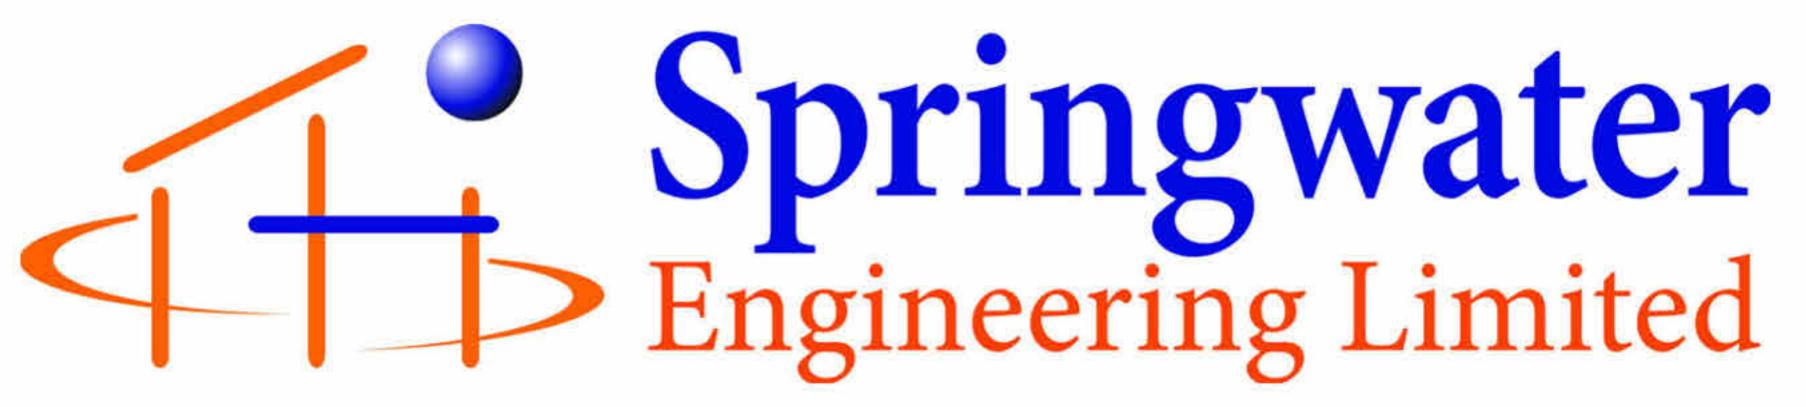

PAUL AND AREN MAGEE

3339 Mason Drive Innisfil, Ontario

PROJECT 1751 ISSUED FOR PERMIT - JULY 26, 2022

CONTACT: WIL EISSES 705-721-7228 Ext. 104 wilfredae.sel@gmail.com



LIST OF DRAWINGS

A100 - SITE PLAN AND ZONING MATRIX


A101 - FOUNDATION PLAN AND SLAB DETAILS

A102 - MAIN FLOOR PLAN AND ROOF PLAN

A103 - SECTIONS, LINTEL AND TRUSS WALL DETAIL

A104 - ELEVATIONS

A105 - RENDERINGS AND NOTES

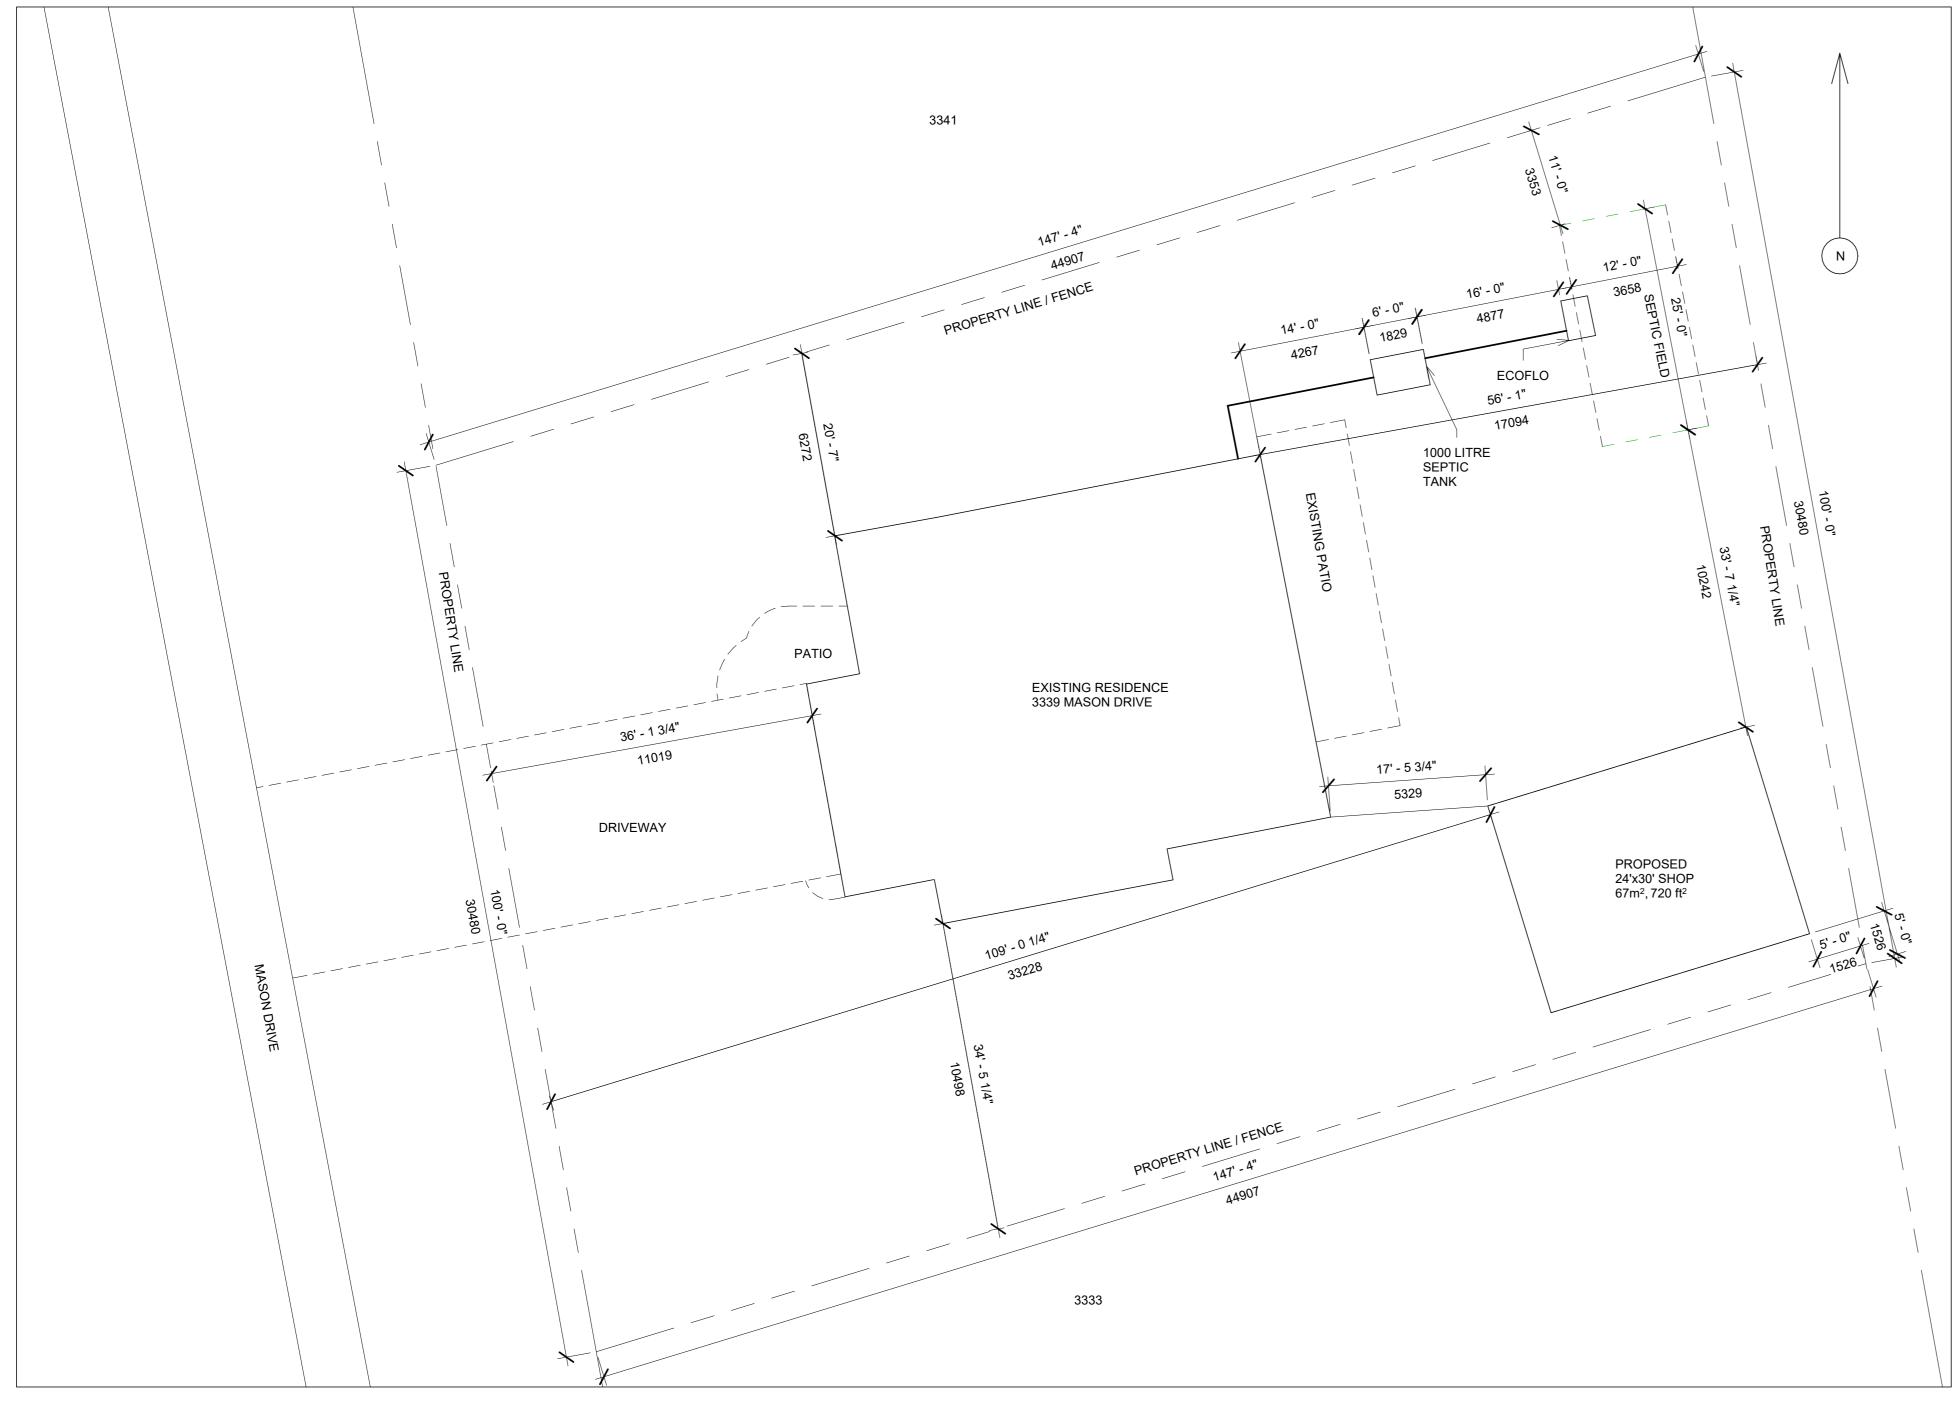

ZONING MATRIX PROPOSED REQUIRED EXISTING MINIMUM LOT AREA 1378m², 14827 ft² MINIMUM LOT FRONTAGE 30.48m, 100 ft MIN. FRONT YARD SETBACK 22m 11m, 36 ft MIN. INTERIOR SIDE YARD NORTH 6.3m, 21 ft MIN. INTERIOR SIDE YARD SOUTH 10.5m, 34 ft MIN. REAR YARD 17.1m, 56 ft MAX. LOT COVERAGE (ALL STRUCTURES) 15% MIN. LANDSCAPED OPEN SPACE 75% 71% MAX. BUILDING HEIGHT 9m ACCESSORY BUILDING MIN. SETBACK, FRONT 33.2m, 109 ft MIN. SETBACK, INTERIOR 1m SIDE 1.5m, 5 ft MIN. SETBACK, EXTERIOR N/A MIN. SETBACK, REAR 1.5m, 5 ft MAX. HEIGHT (MID POINT) 5m 4.82m, 15 ft 9 3/4" LOT COVERAGE 10% 4.9% GROSS FLOOR AREA 50m² 67m²

SITE MAP INFORMATION TAKEN FROM GIS SIMCOE COUNTY MAPPING SEPTIC BED INFORMATION FROM INSPECTION REPORT - PUMP MY TANK - JUNE 15, 2022

Site Plan 3/32" = 1'-0"

Springwater	
Engineering Limited	
24 Parkside Drive	F
Barrie, ON L4N 1W6	
Tel (705) 721-7228	
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No:	DATE:	REVISION:	SEAL:
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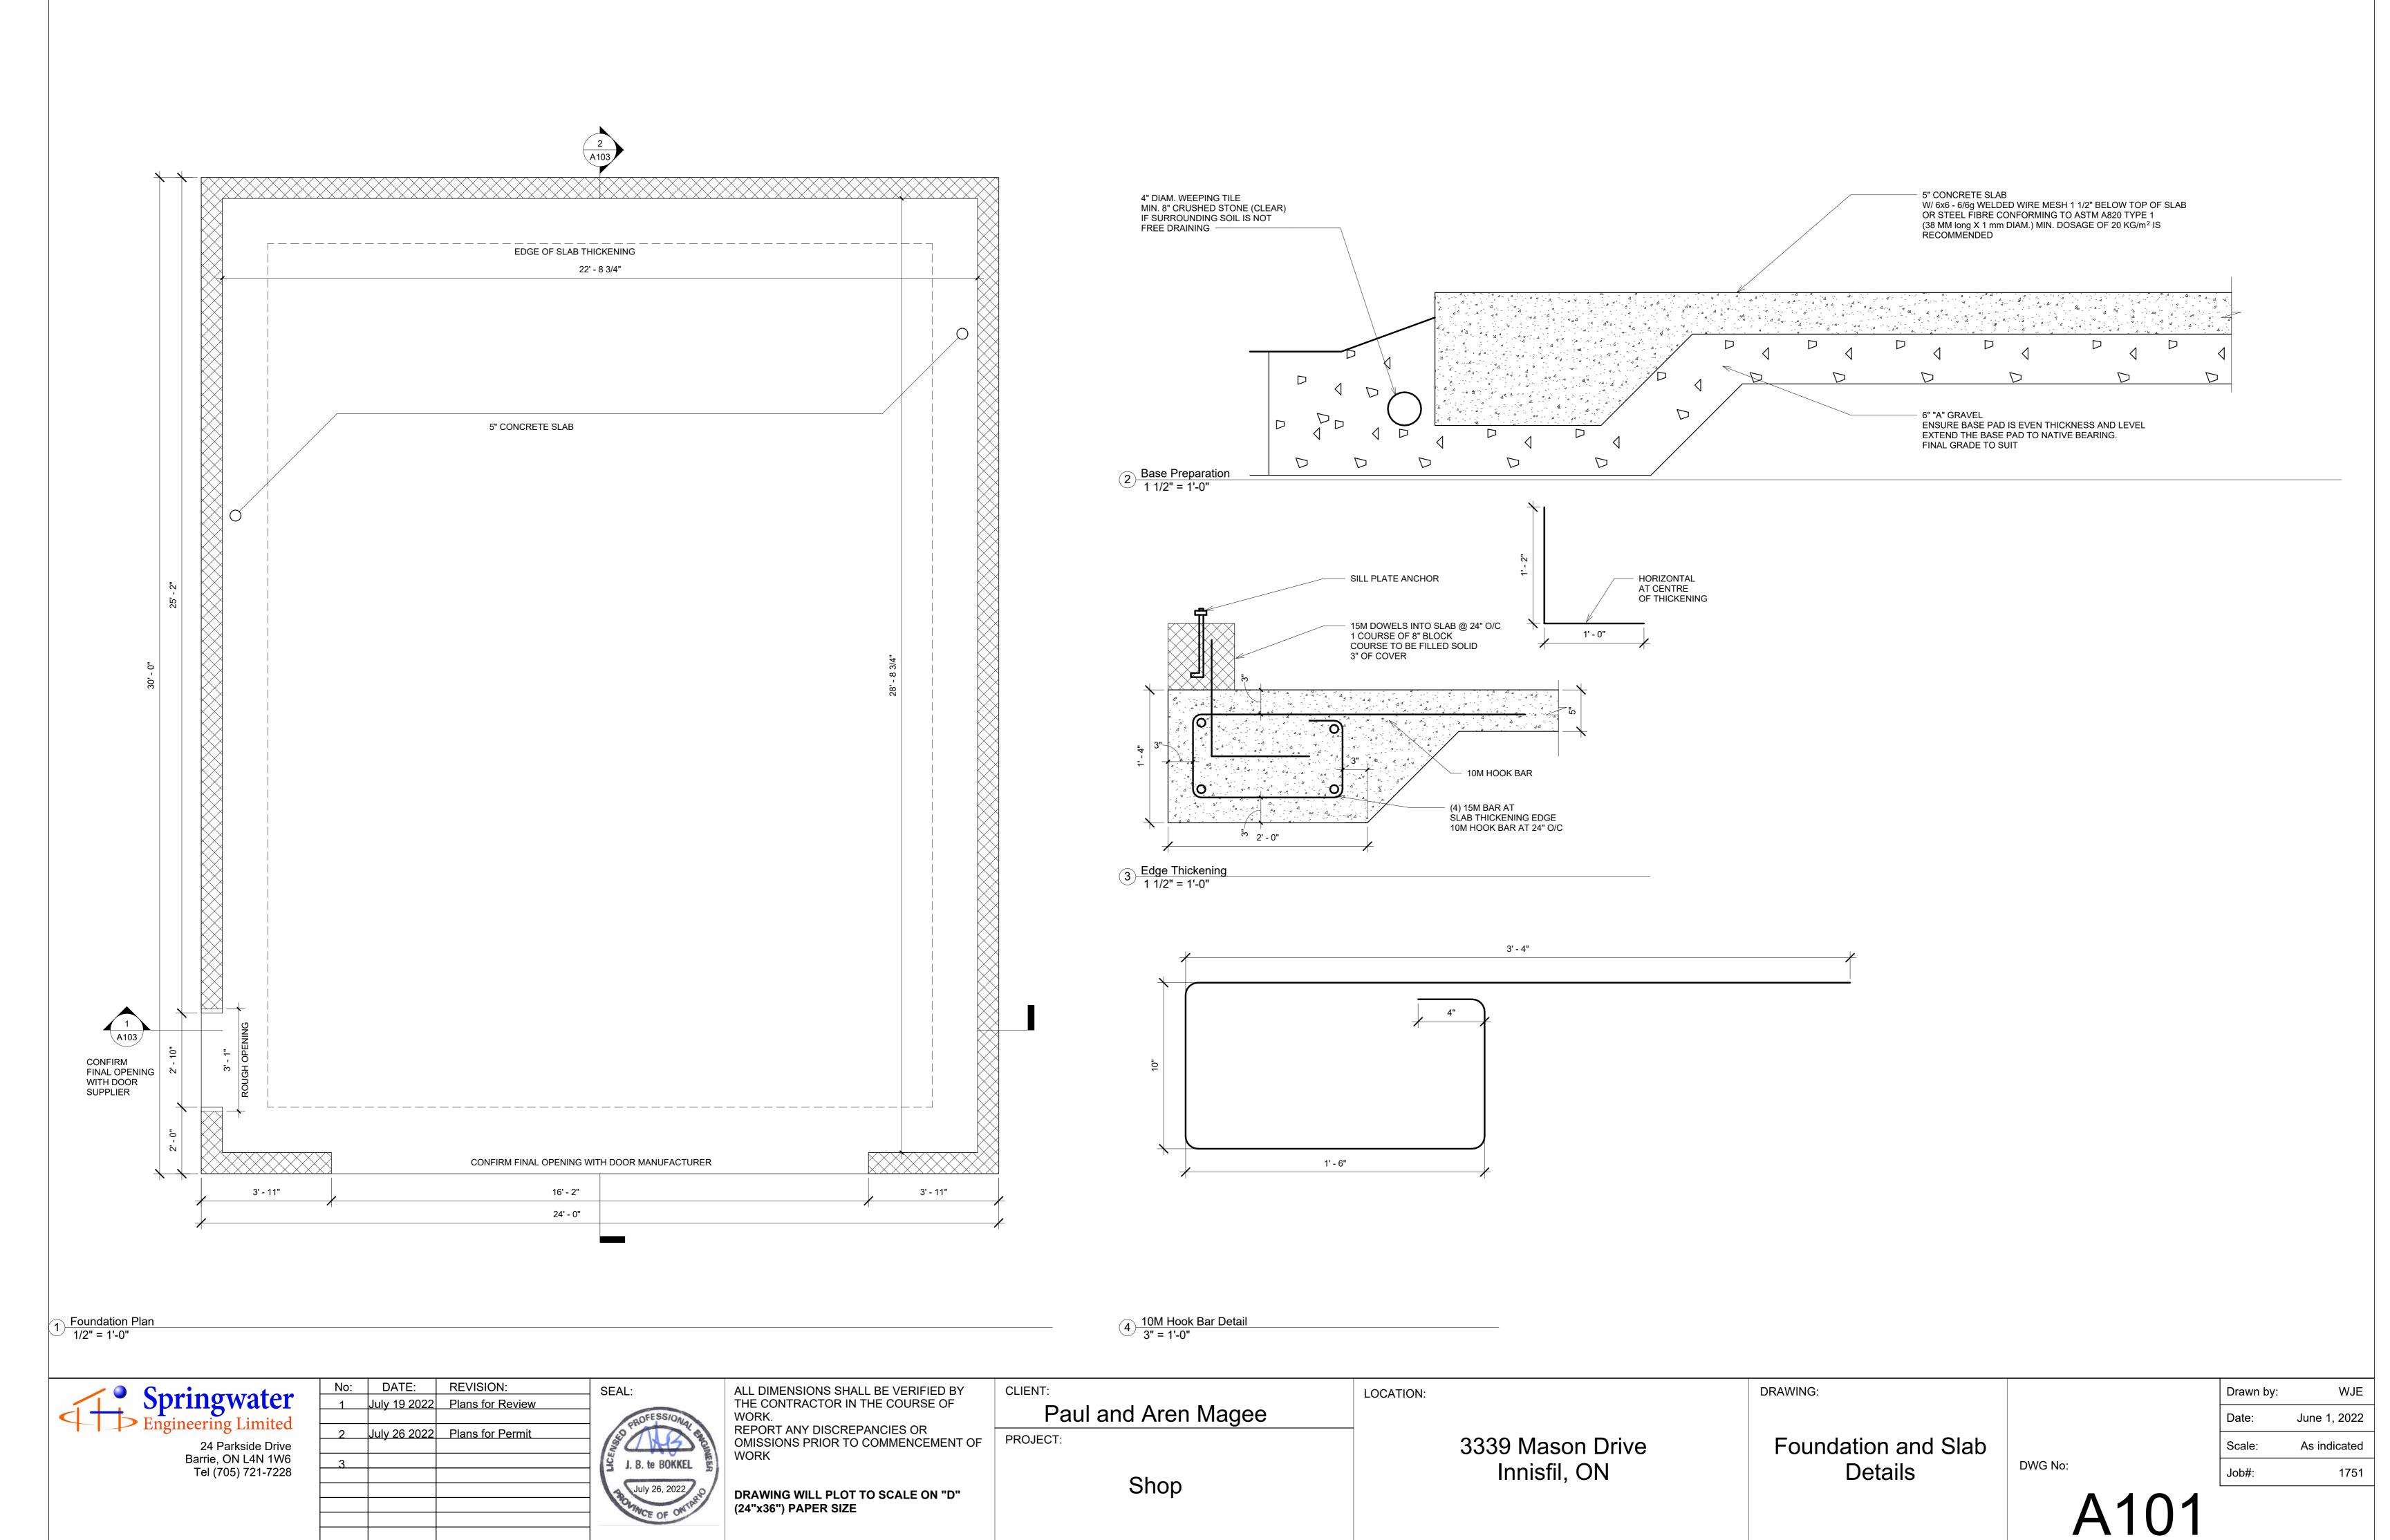
	CLIENT:	LOCATION:
	Paul and Aren Magee	
=	PROJECT:	
	Shop	


3339 Mason Drive
3339 Mason Drive
Innisfil, ON

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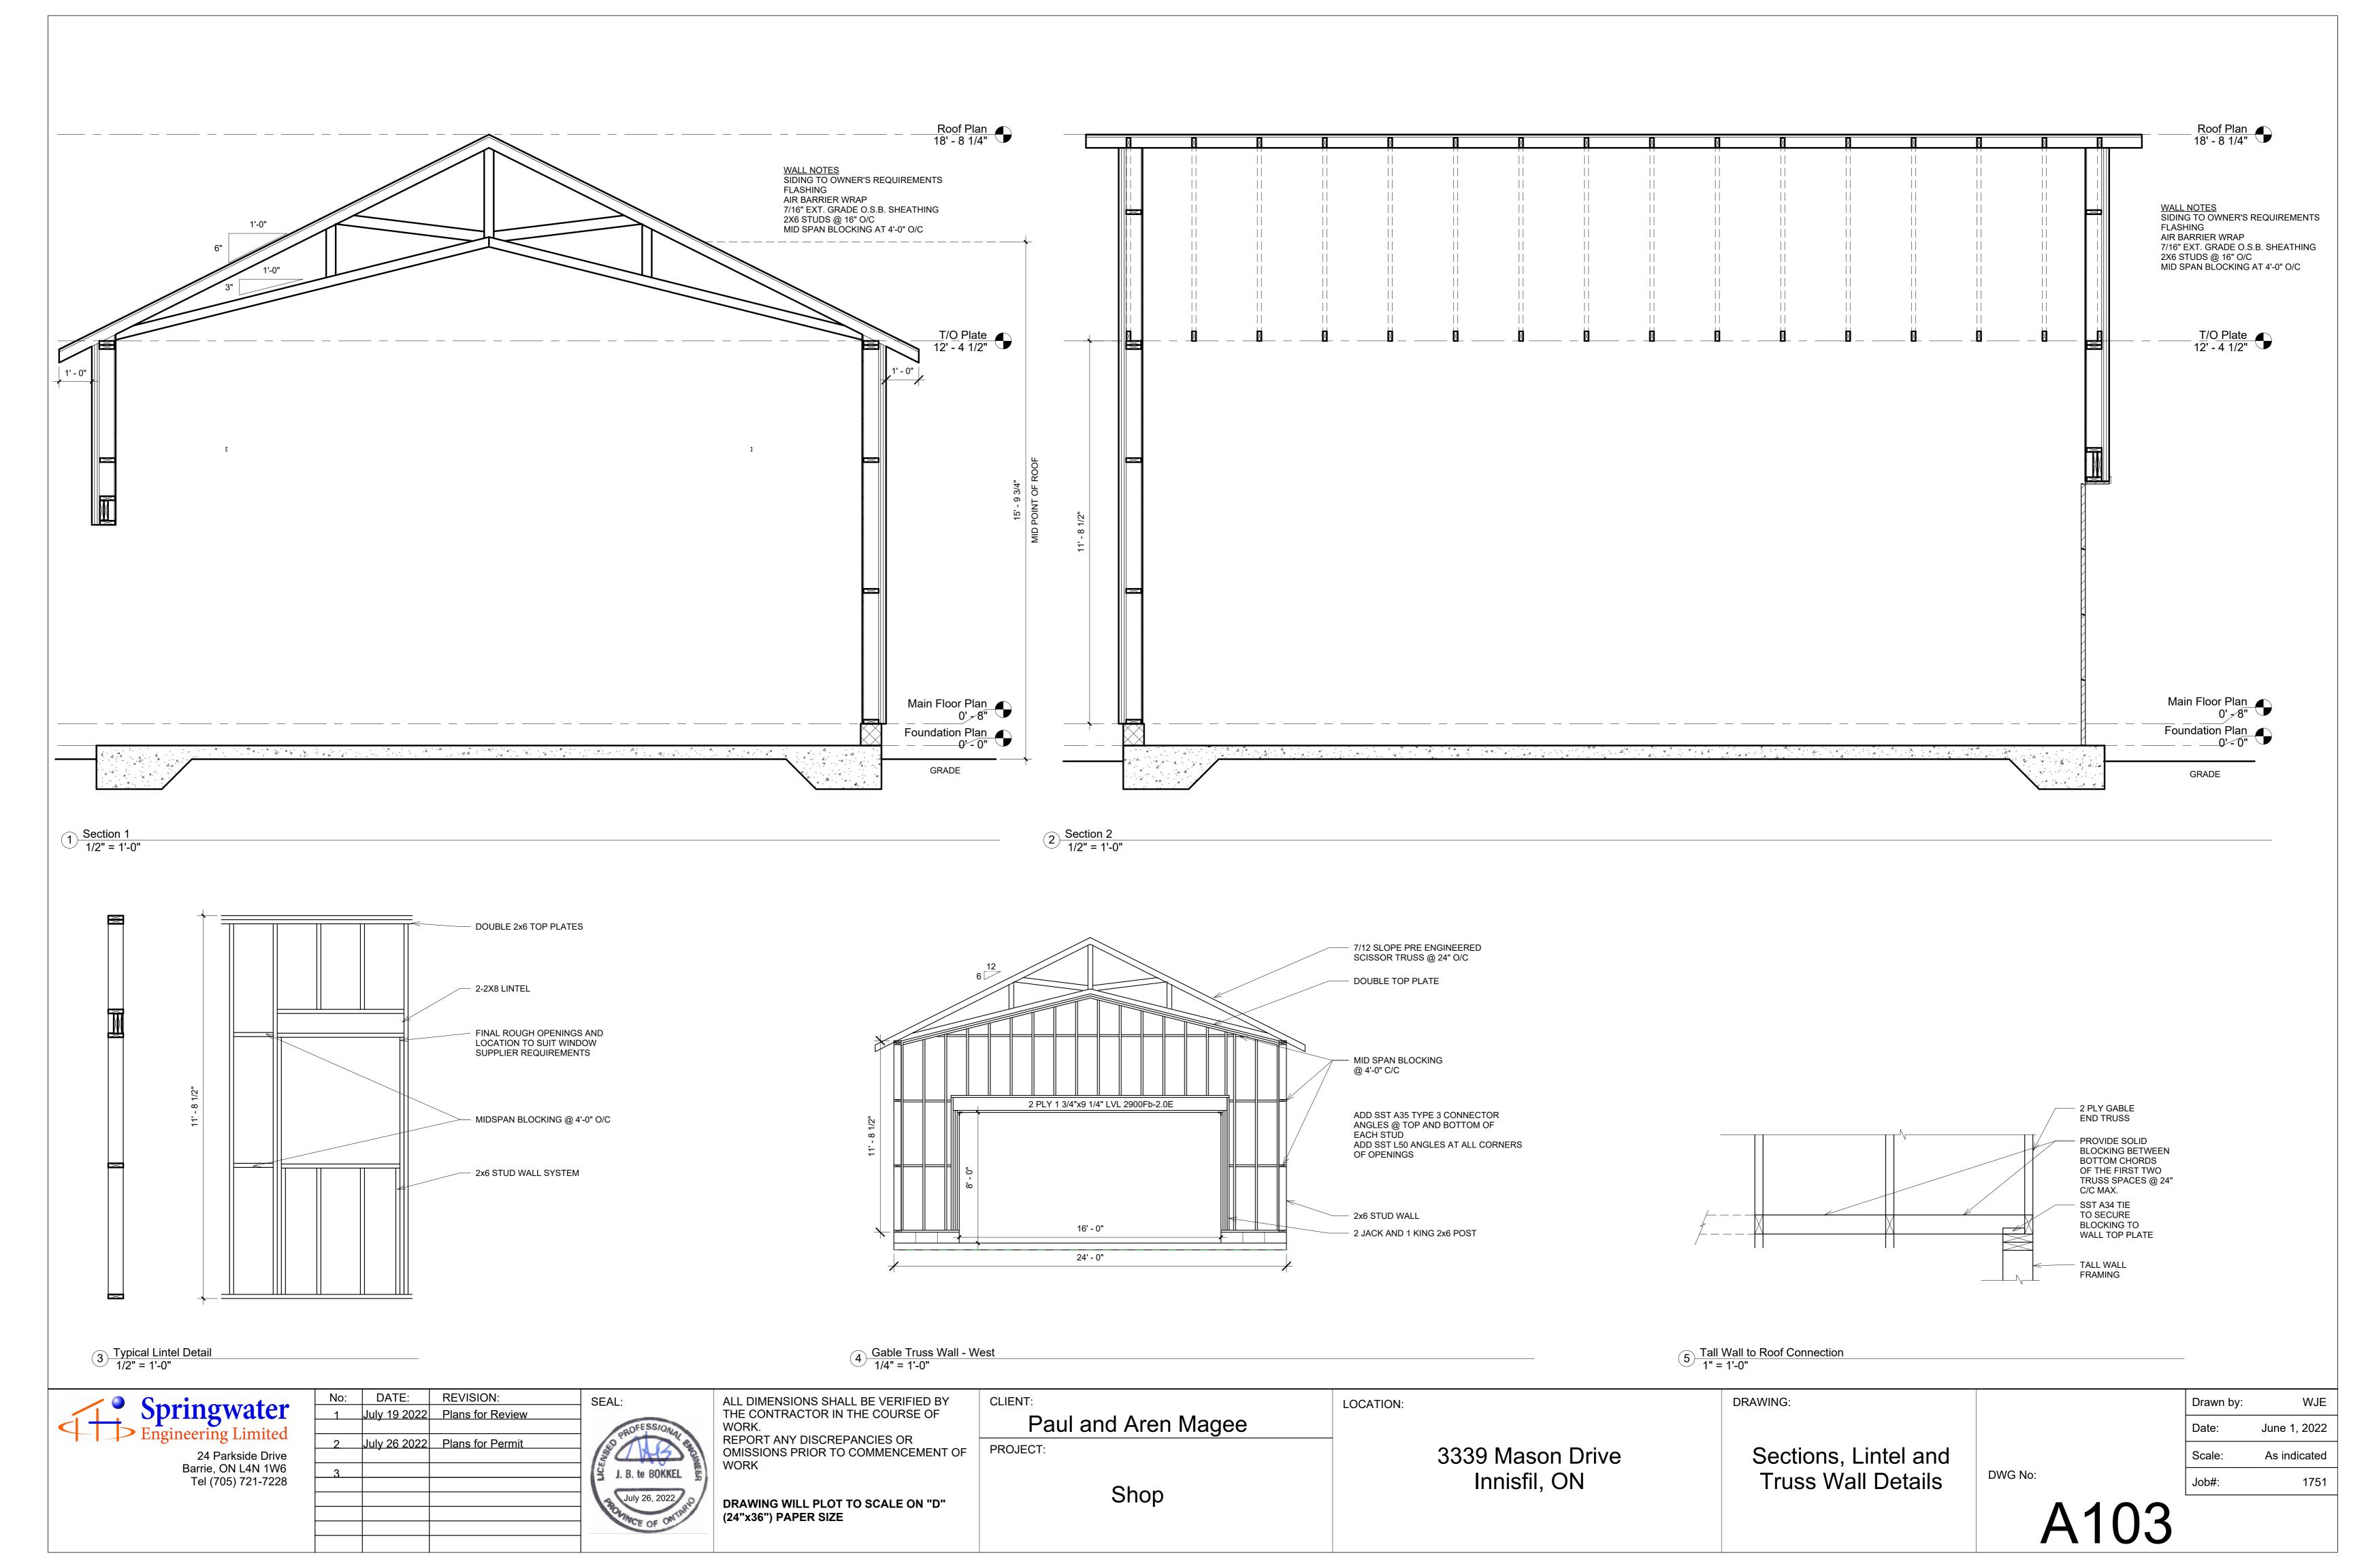
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	Date:	June 1, 2022
	Scale:	As indicated
DWG No:	Job#:	1751

A100



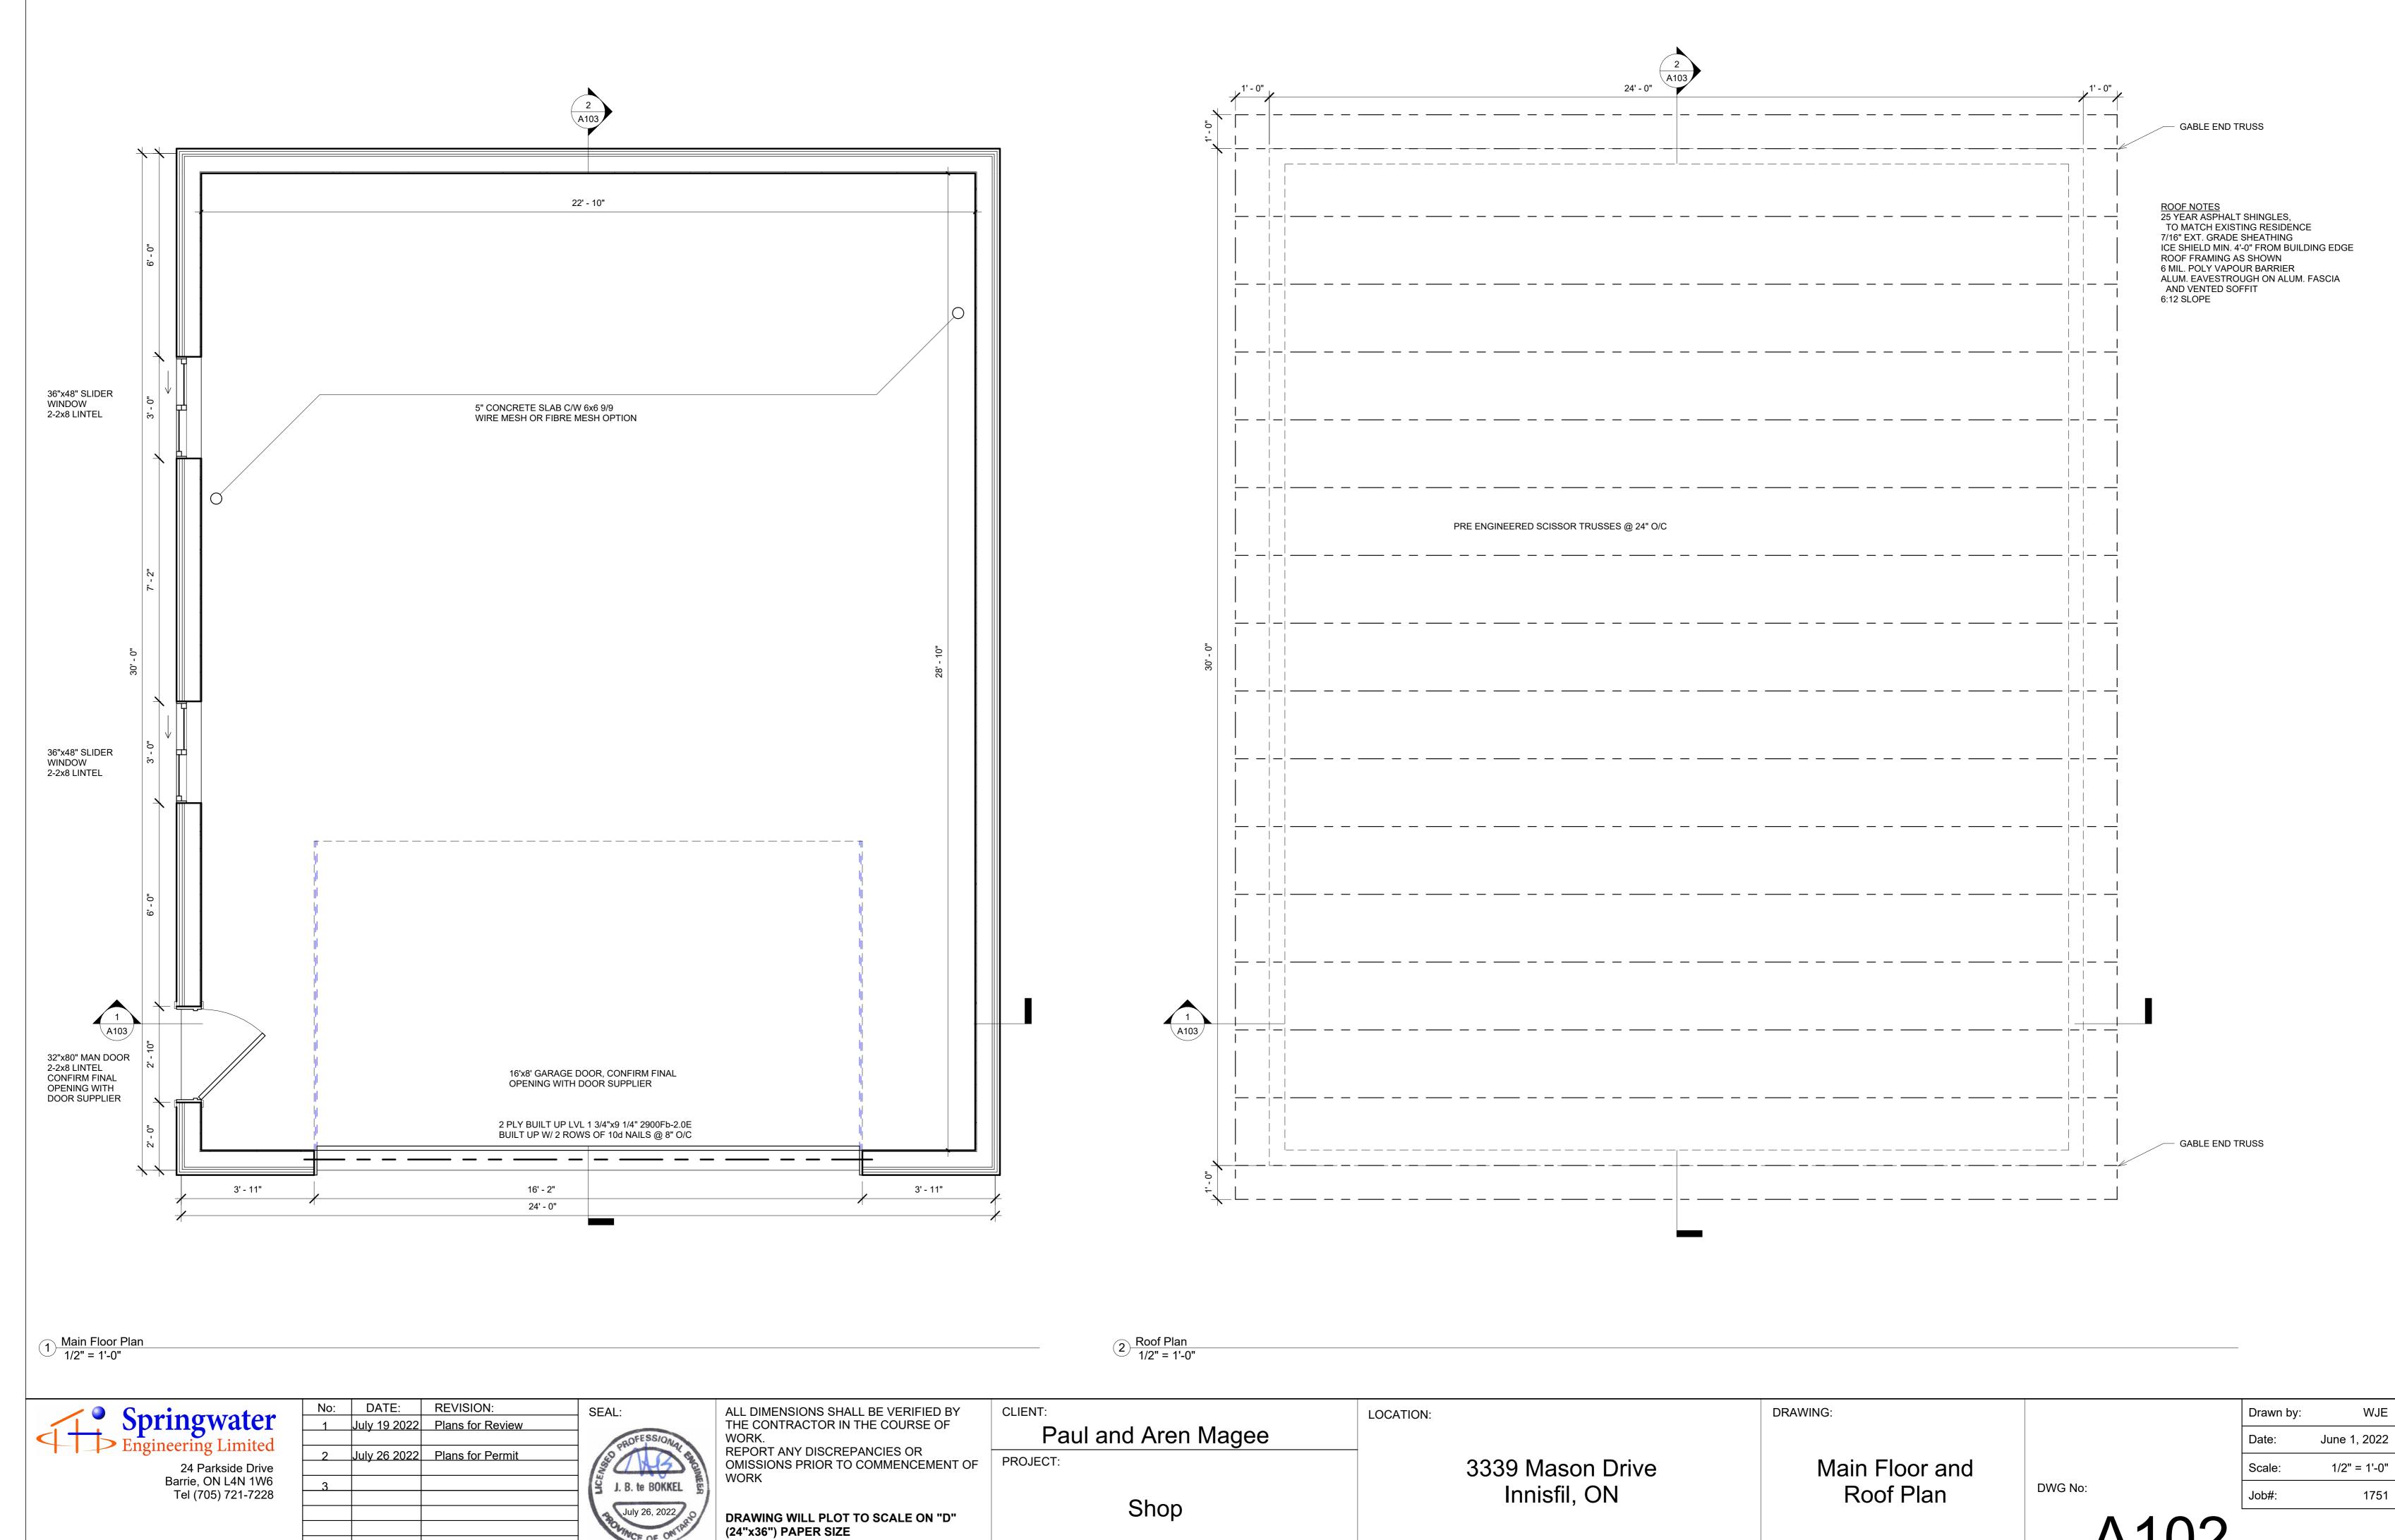

A102





Springwater
Engineering Limited
24 Parkside Drive Barrie, ON L4N 1W6 Tel (705) 721-7228

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LOCATION: Paul and Aren Magee Shop

3339 Mason Drive Innisfil, ON

Elevations

DRAWING:

Drawn by: DWG No:

WJE

1751

June 1, 2022

3/8" = 1'-0"



NORTHWEST CORNER



SOUTHWEST CORNER

Springwater Engineering Limited 24 Parkside Drive Barrie, ON L4N 1W6 Tel (705) 721-7228

REVISION:	DATE:	No:
Plans for Review	July 19 2022	11
Plans for Permit	July 26 2022	2
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IISSIONS PRIOR TO COMMENCEMENT OF

Paul and Aren Magee

Shop

LOCATION:

3339 Mason Drive Innisfil, ON

Renderings and Notes DWG No:

WITH A MINIMUM 0.05 POLYETHYLENE VAPOUR BARRIER, ROLL ROOFING, OR APPROVED EQUIVALENT.

9. FRAMING ANCHORS: - FRAMING ANCHORS, JOIST HANGERS, BEAM HANGERS, POST CAPS, POST ANCHORS, BACK-UP CLIPS AND ANGLES, UNLESS OTHERWISE SHOWN ON THE STRUCTURAL DRAWINGS, ARE ALL TO BE AS MANUFACTURED BY

10. SPLICES, NOTCHING, AND DRILLING THROUGH MEMBERS IS NOT PERMITTED EXCEPT AS SPECIFIED BY THESE PLANS

11. MANUFACTURED LUMBER OR TIMBER PRODUCTS NOT SPECIFIED HEREIN ARE TO BE APPROVED BY THE ENGINEER PRIOR TO USE. MANUFACTURED WOOD PRODUCT TO BE INSTALLED AS PER THE MANUFACTURER'S SPECIFICATIONS AND

12.NUMBER, SIZE, AND LOCATION OF BRACING, BLOCKING, AND BRIDGING BETWEEN LUMBER OR TIMBER STRUCTURAL

16. ALL MULTIPLY WOOD MEMBERS SHALL BE BUILT-UP IN ACCORDANCE WITH OBC 2012, PART 9 OR PER MANUFACTURER'S

INSTALLED IN STRICT ACCORDANCE WITH THE MANUFACTURER'S INSTRUCTIONS AND SPECIFICATIONS UTILIZING NAILS OR

SIMPSON OR AN APPROVED EQUAL, AND SIZED APPROPRIATELY FOR THE CONNECTING MEMBERS. ALL ARE TO BE

8. ALL WOOD PRODUCT EXPOSED DIRECTLY TO SOIL SHALL BE PRESSURE TREATED.

ELEMENTS TO CONFORM TO THE REQUIREMENTS IN THE ONTARIO BUILDING CODE PART 9.

15. MINIMUM BEARING OF WOOD ELEMENTS NOT SPECIFIED TO BE MINIMUM 3" (76mm).

13. MINIMUM BEARING OF WOOD JOISTS TO BE MINIMUM 1.5" (38mm). 14. MINIMUM BEARING OF WOOD BEAMS TO BE MINIMUM 3" (76mm).

18. PROVIDE ALL WOOD AND BRICK LINTELS PER OBC 2012, PART 9.

DRAWING:


17. ALL LVL BEAMS SHALL MEET OR EXCEED 2.0E, 3100Fb.

SCREWS WHERE REQUIRED.

AND/OR AS APPROVED BY THE ENGINEER.

SPECIFICATIONS AND GUIDELINES.

Drawn by: WJE June 1, 2022 1 1/2" = 1'-0" 1751

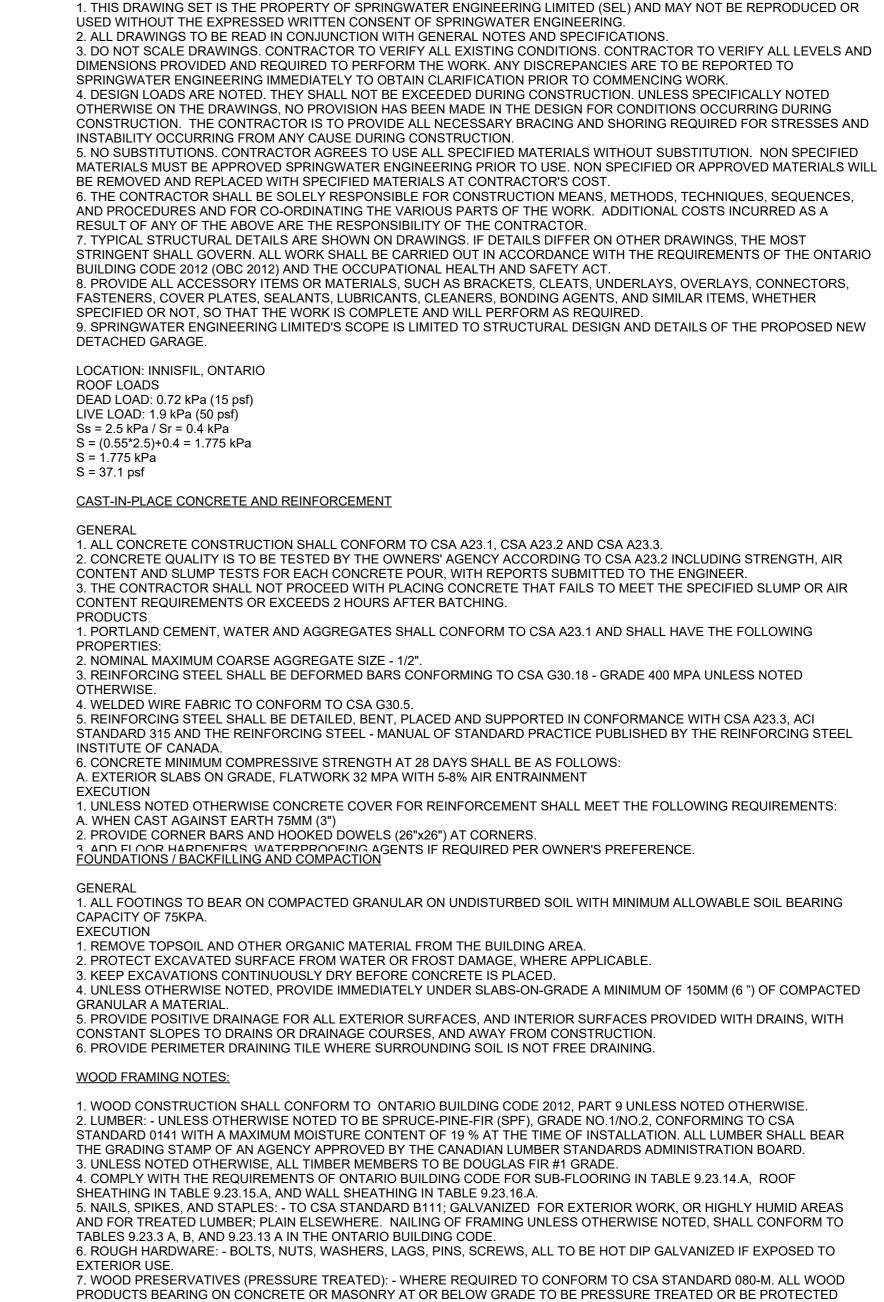

GENERAL NOTES: