



### COMMITTEE OF ADJUSTMENT NOTICE OF PUBLIC HEARING APPLICATION NO. A-066-2022

**TAKE NOTICE** that an application has been received by the Town of Innisfil from **Paul Magee, Owner,** for a minor variance from Zoning By-law 080-13, pursuant to Section 45 of the *Planning Act*, R.S.O. 1990, c. P.13, as amended.

The subject property is described legally as **PLAN 1032 LOT 6**, is known municipally as **3339 Mason Drive**, and is zoned as **"Residential 1 Zone (R1)"**.


The applicant is proposing to construct a detached garage with a gross floor area of 67 m<sup>2</sup>. The applicant is seeking relief from Section 3.3(b) of the Zoning By-law which permits a maximum gross floor area of 50 m<sup>2</sup>.

The Committee of Adjustment for the Town of Innisfil will consider this application through a conference call on **Thursday**, **January 19**, **2023**, **at 6:30 PM**.

To participate in the hearing and/or provide comments, you must register by following the link below or scanning the above QR code: <u>https://innisfil.ca/en/building-and-</u> <u>development/committee-of-adjustment-</u> <u>hearings.aspx</u>

Requests can also be submitted in writing to: Town of Innisfil Committee of Adjustment, 2101 Innisfil Beach Road, Innisfil, Ontario, L9S 1A1 or by email to <u>planning@innisfil.ca</u>.

If you wish to receive a copy of the decision of the Committee of Adjustment in respect of the proposed minor variance, you must make a written request to the Secretary-Treasurer of the Committee of Adjustment by way of email or regular mail. The Notice of Decision will also explain the process for appealing a decision to the Local Planning Appeal Tribunal.

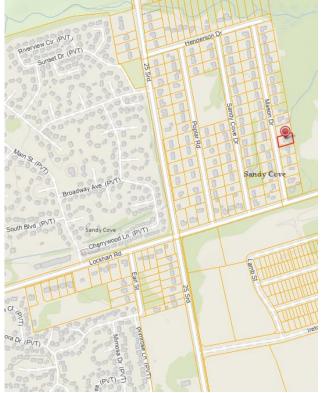


Additional information relating to the proposed application is available on the Town of Innisfil website. Accessible formats are available on request, to support participation in all aspects of the feedback process. To request an alternate format please contact Planning Services at <u>planning@innisfil.ca</u>.

Dated: January 3, 2023

Toomaj Haghshenas, Secretary-Treasurer thaghshenas@innisfil.ca 705-436-3710 ext. 3316

Town of Innisfil • 2101 Innisfil Beach Rd., Innisfil ON L9S 1A1 • 705-436-3710 • 1-888-436-3710 • Fax: 705-436-7120 www.innisfil.ca

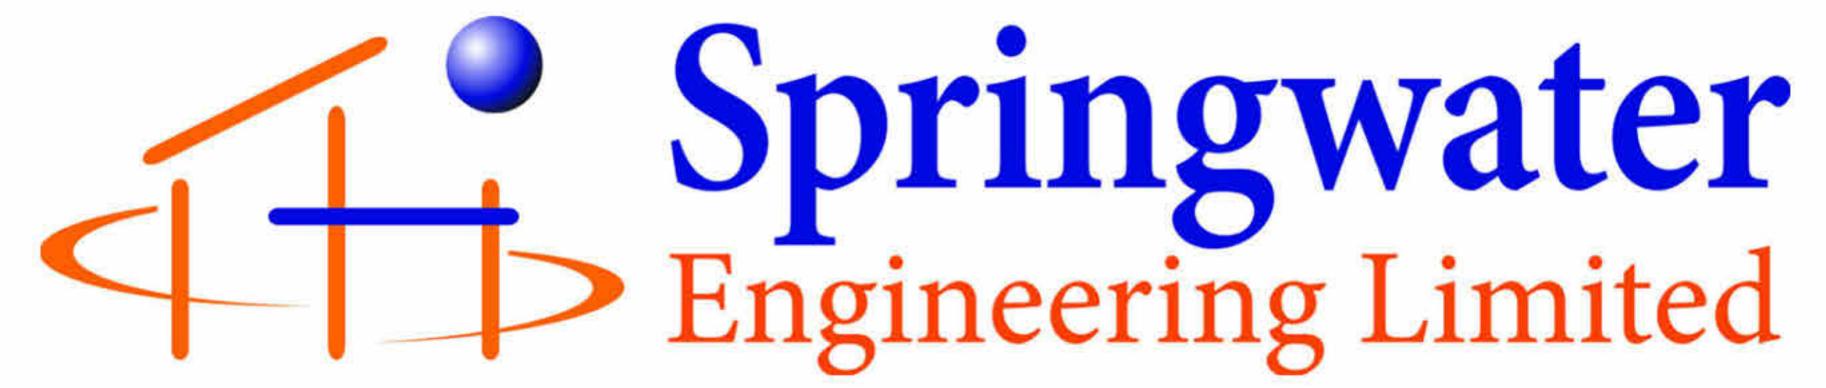




LIST OF DRAWINGS A100 - SITE PLAN AND ZONING MATRIX A101 - FOUNDATION PLAN AND SLAB DETAILS A102 - MAIN FLOOR PLAN AND ROOF PLAN A103 - SECTIONS, LINTEL AND TRUSS WALL DETAIL A104 - ELEVATIONS A105 - RENDERINGS AND NOTES

# PAUL AND AREN MAGEE

3339 Mason Drive Innisfil, Ontario

PROJECT 1751 ISSUED FOR PERMIT - JULY 26, 2022

> CONTACT: WIL EISSES 705-721-7228 Ext. 104 wilfredae.sel@gmail.com

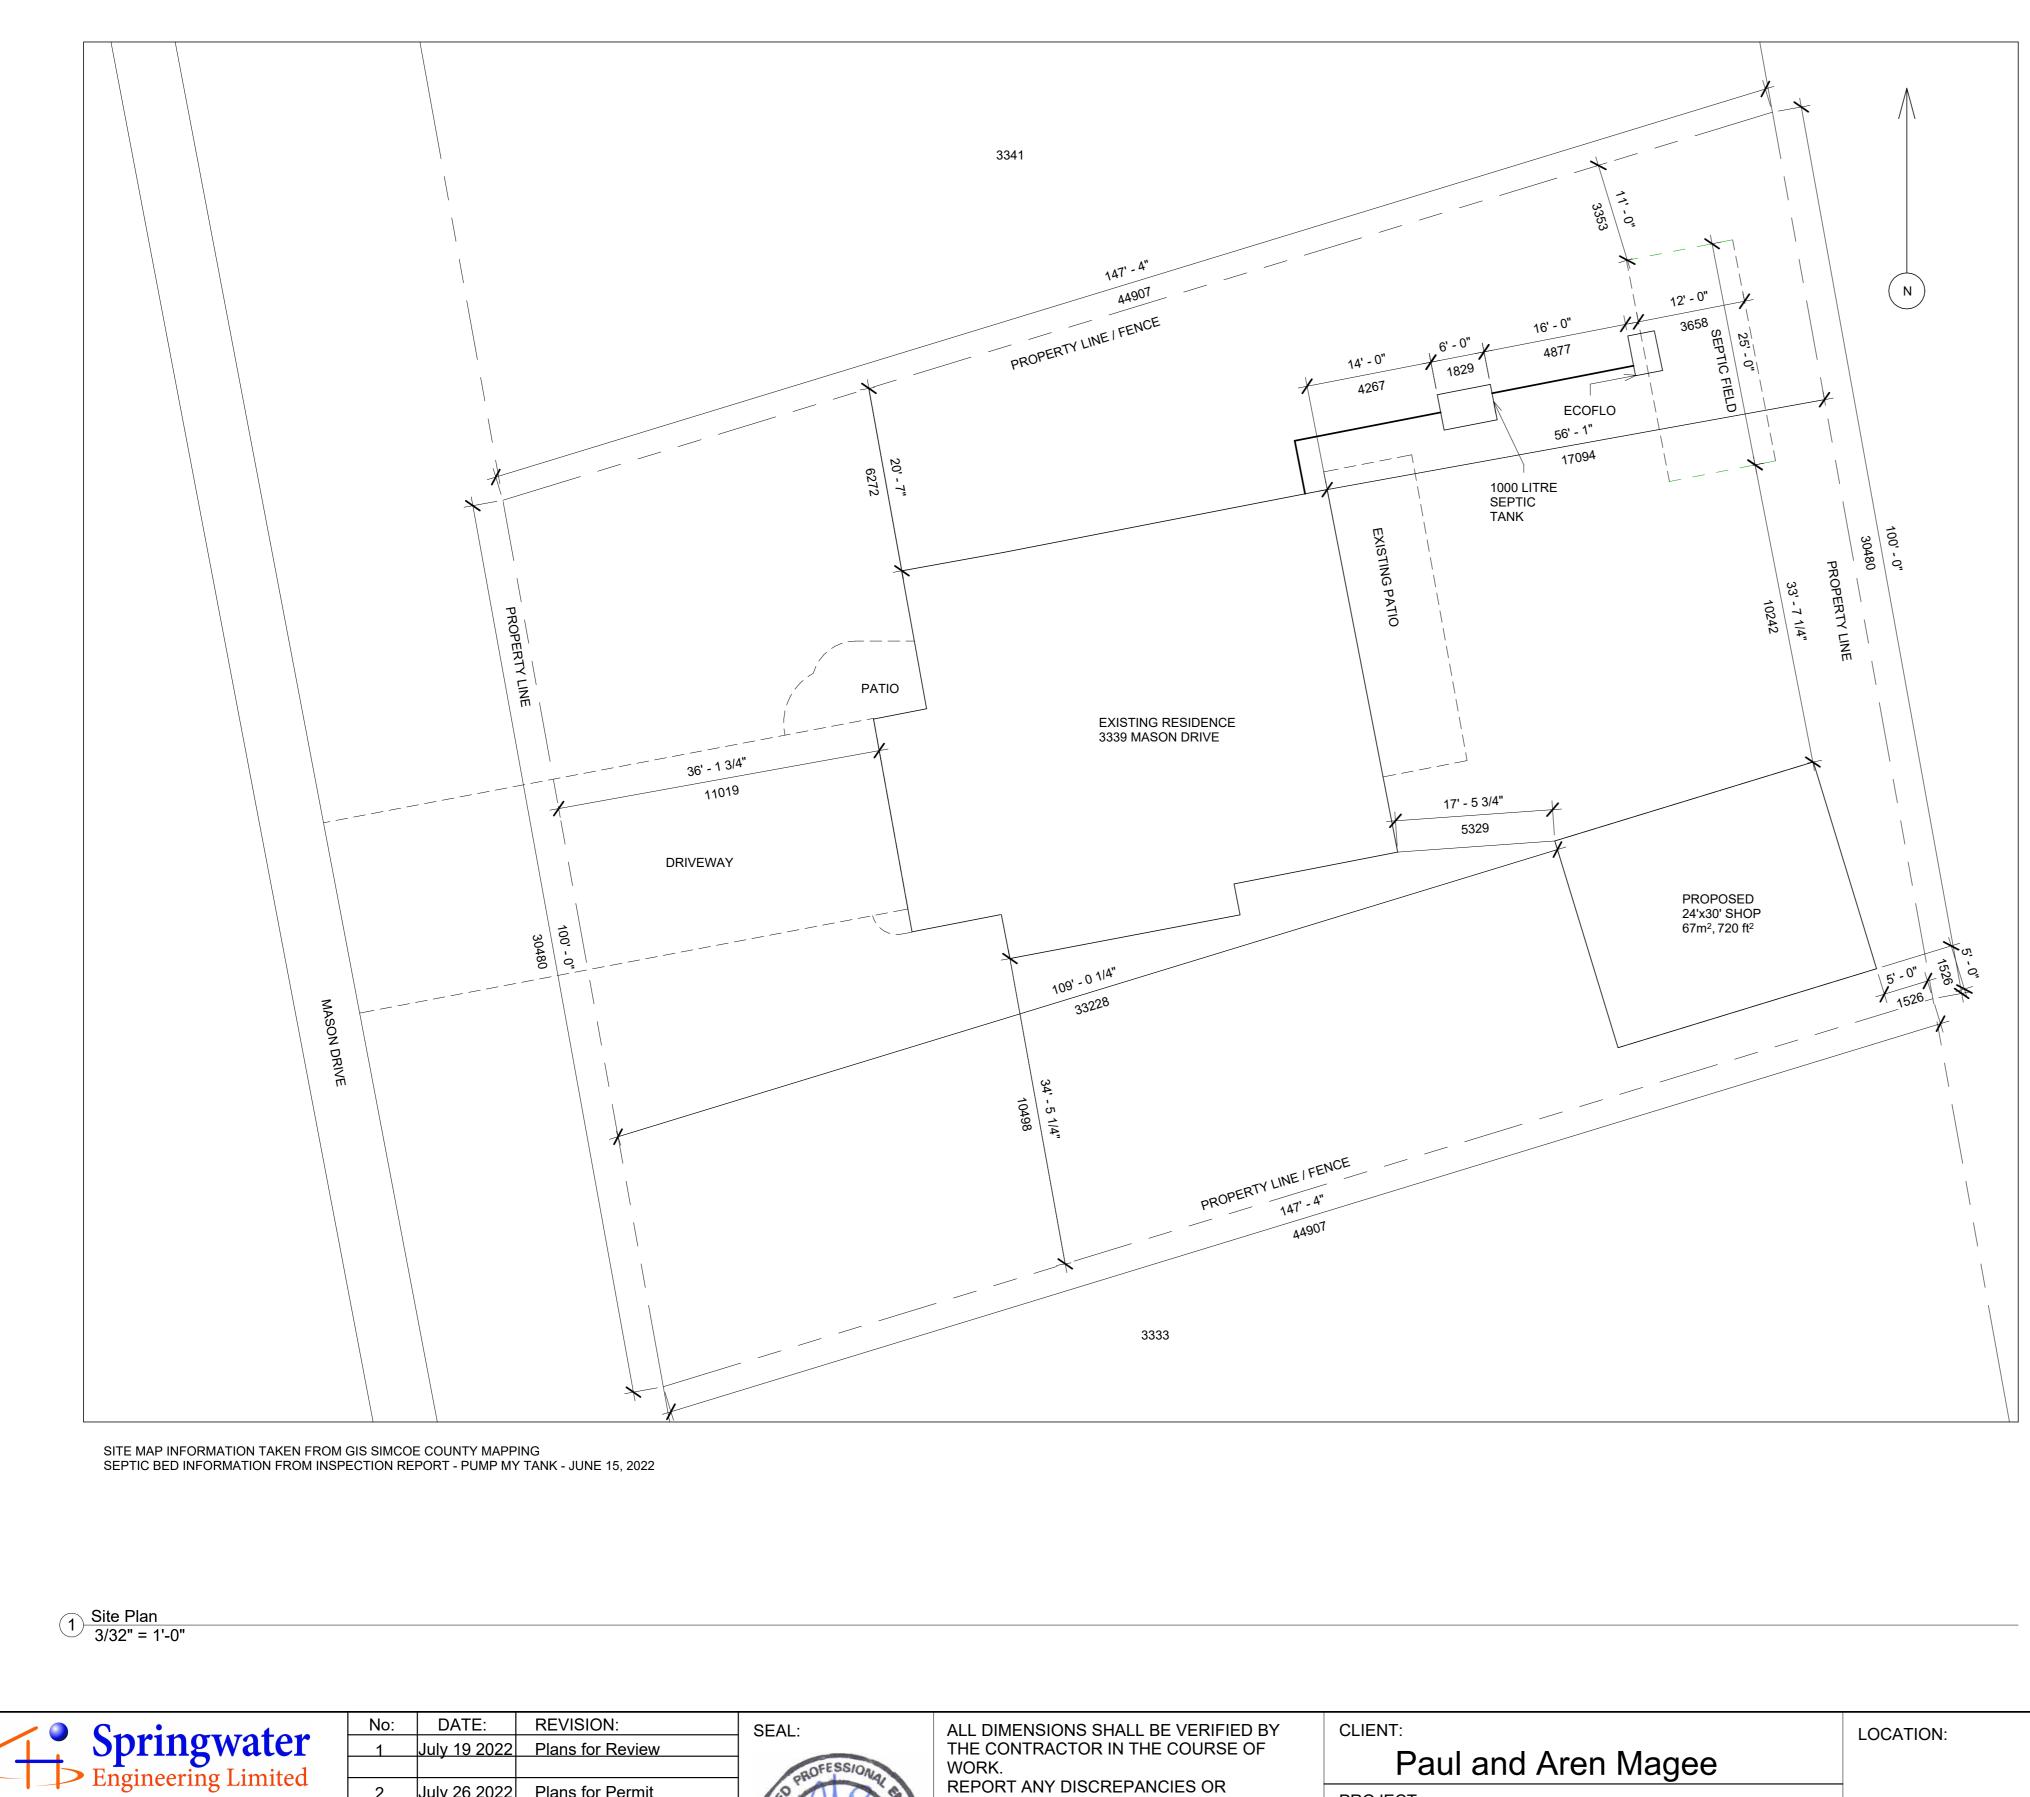

24 Parkside Drive Barrie, ON L4N 1W6 Tel (705) 721-7228

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2 July 26 2022 Plans for Permit J. B. te BOKKEL July 26, 2022 CEOF


REPORT ANY DISC OMISSIONS PRIOF WORK

DRAWING WILL P (24"x36") PAPER S

S SHALL BE VERIFIED BY OR IN THE COURSE OF	CLIENT: Paul and Aren Magee	LOCATION:
SCREPANCIES OR OR TO COMMENCEMENT OF	PROJECT:	3339 Mason Drive
PLOT TO SCALE ON "D" SIZE	Shop	Innisfil, ON

	REQUIRED	EXISTING	PROPOSED
ZONE	R1	R1	R1
MINIMUM LOT AREA	1400m <sup>2</sup>	1378m <sup>2</sup> , 14827 ft <sup>2</sup>	-
MINIMUM LOT FRONTAGE	22m	30.48m, 100 ft	-
MIN. FRONT YARD SETBACK	22m	11m, 36 ft	-
MIN. INTERIOR SIDE YARD NORTH	1.5m	6.3m, 21 ft	-
MIN. INTERIOR SIDE YARD SOUTH	1.5m	10.5m, 34 ft	-
MIN. REAR YARD	6m	17.1m, 56 ft	-
MAX. LOT COVERAGE (ALL STRUCTURES)	35%	15%	-
MIN. LANDSCAPED OPEN SPACE	30%	75%	71%
MAX. BUILDING HEIGHT	9m	9m	-
ACCESSORY BUILDING			
MIN. SETBACK, FRONT	6m	-	33.2m, 109 ft
MIN. SETBACK, INTERIOR SIDE	1m	-	1.5m, 5 ft
MIN. SETBACK, EXTERIOR SIDE	3m	-	N/A
MIN. SETBACK, REAR	1m	-	1.5m, 5 ft
MAX. HEIGHT (MID POINT)	5m	-	4.82m, 15 ft 9 3/4
LOT COVERAGE	10%	-	4.9%
GROSS FLOOR AREA	50m <sup>2</sup>	-	67m <sup>2</sup>


DRAWING:		Drawn by:	WJE
		Date:	June 1, 2022
Site Plan and Zoning		Scale:	As indicated
Matrix	DWG No:	Job#:	1751
	A100		

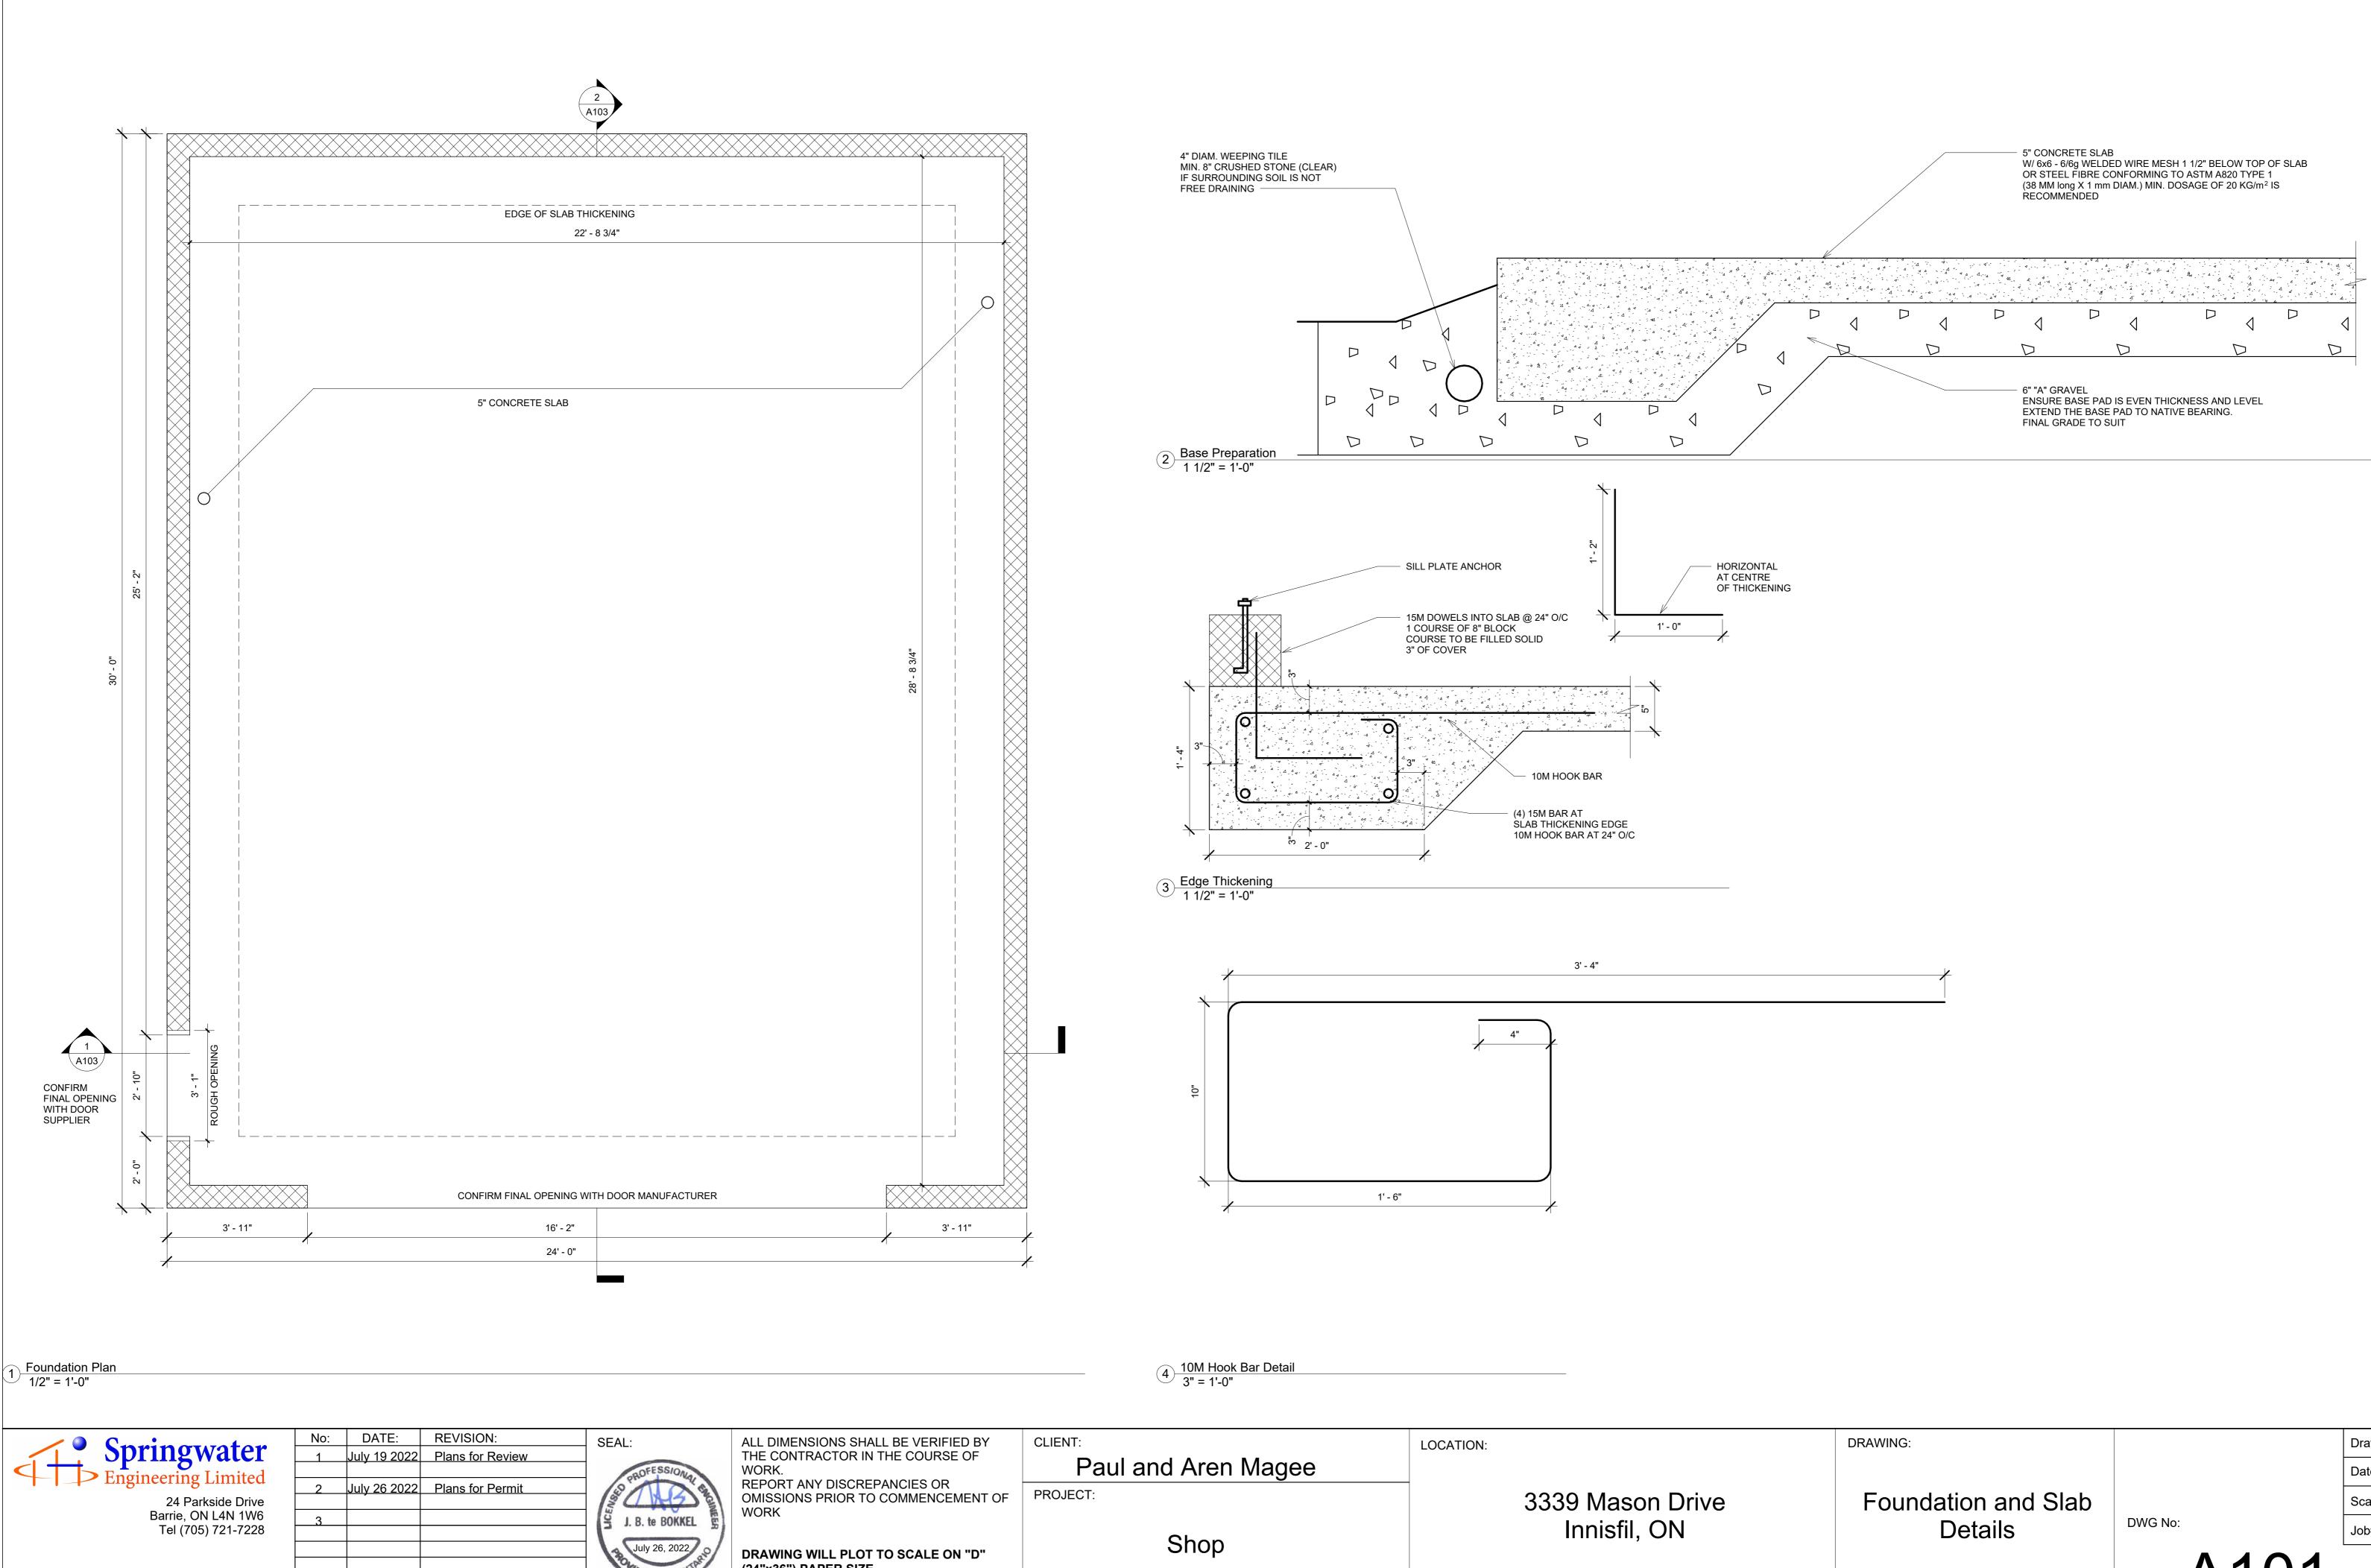


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ALL DIMENSIONS SHALL BE VERIFIED BY THE CONTRACTOR IN THE COURSE OF		LOCATION:
WORK.	Paul and Aren Magee	
REPORT ANY DISCREPANCIES OR OMISSIONS PRIOR TO COMMENCEMENT OF WORK	PROJECT:	3339 Mason Drive
DRAWING WILL PLOT TO SCALE ON "D" (24"x36") PAPER SIZE	Shop	Innisfil, ON

DRAWING:		Drawn by:	WJE
		Date:	June 1, 2022
Foundation and Slab		Scale:	As indicated
Details	DWG No:	Job#:	1751
	A101		
	AIUI		

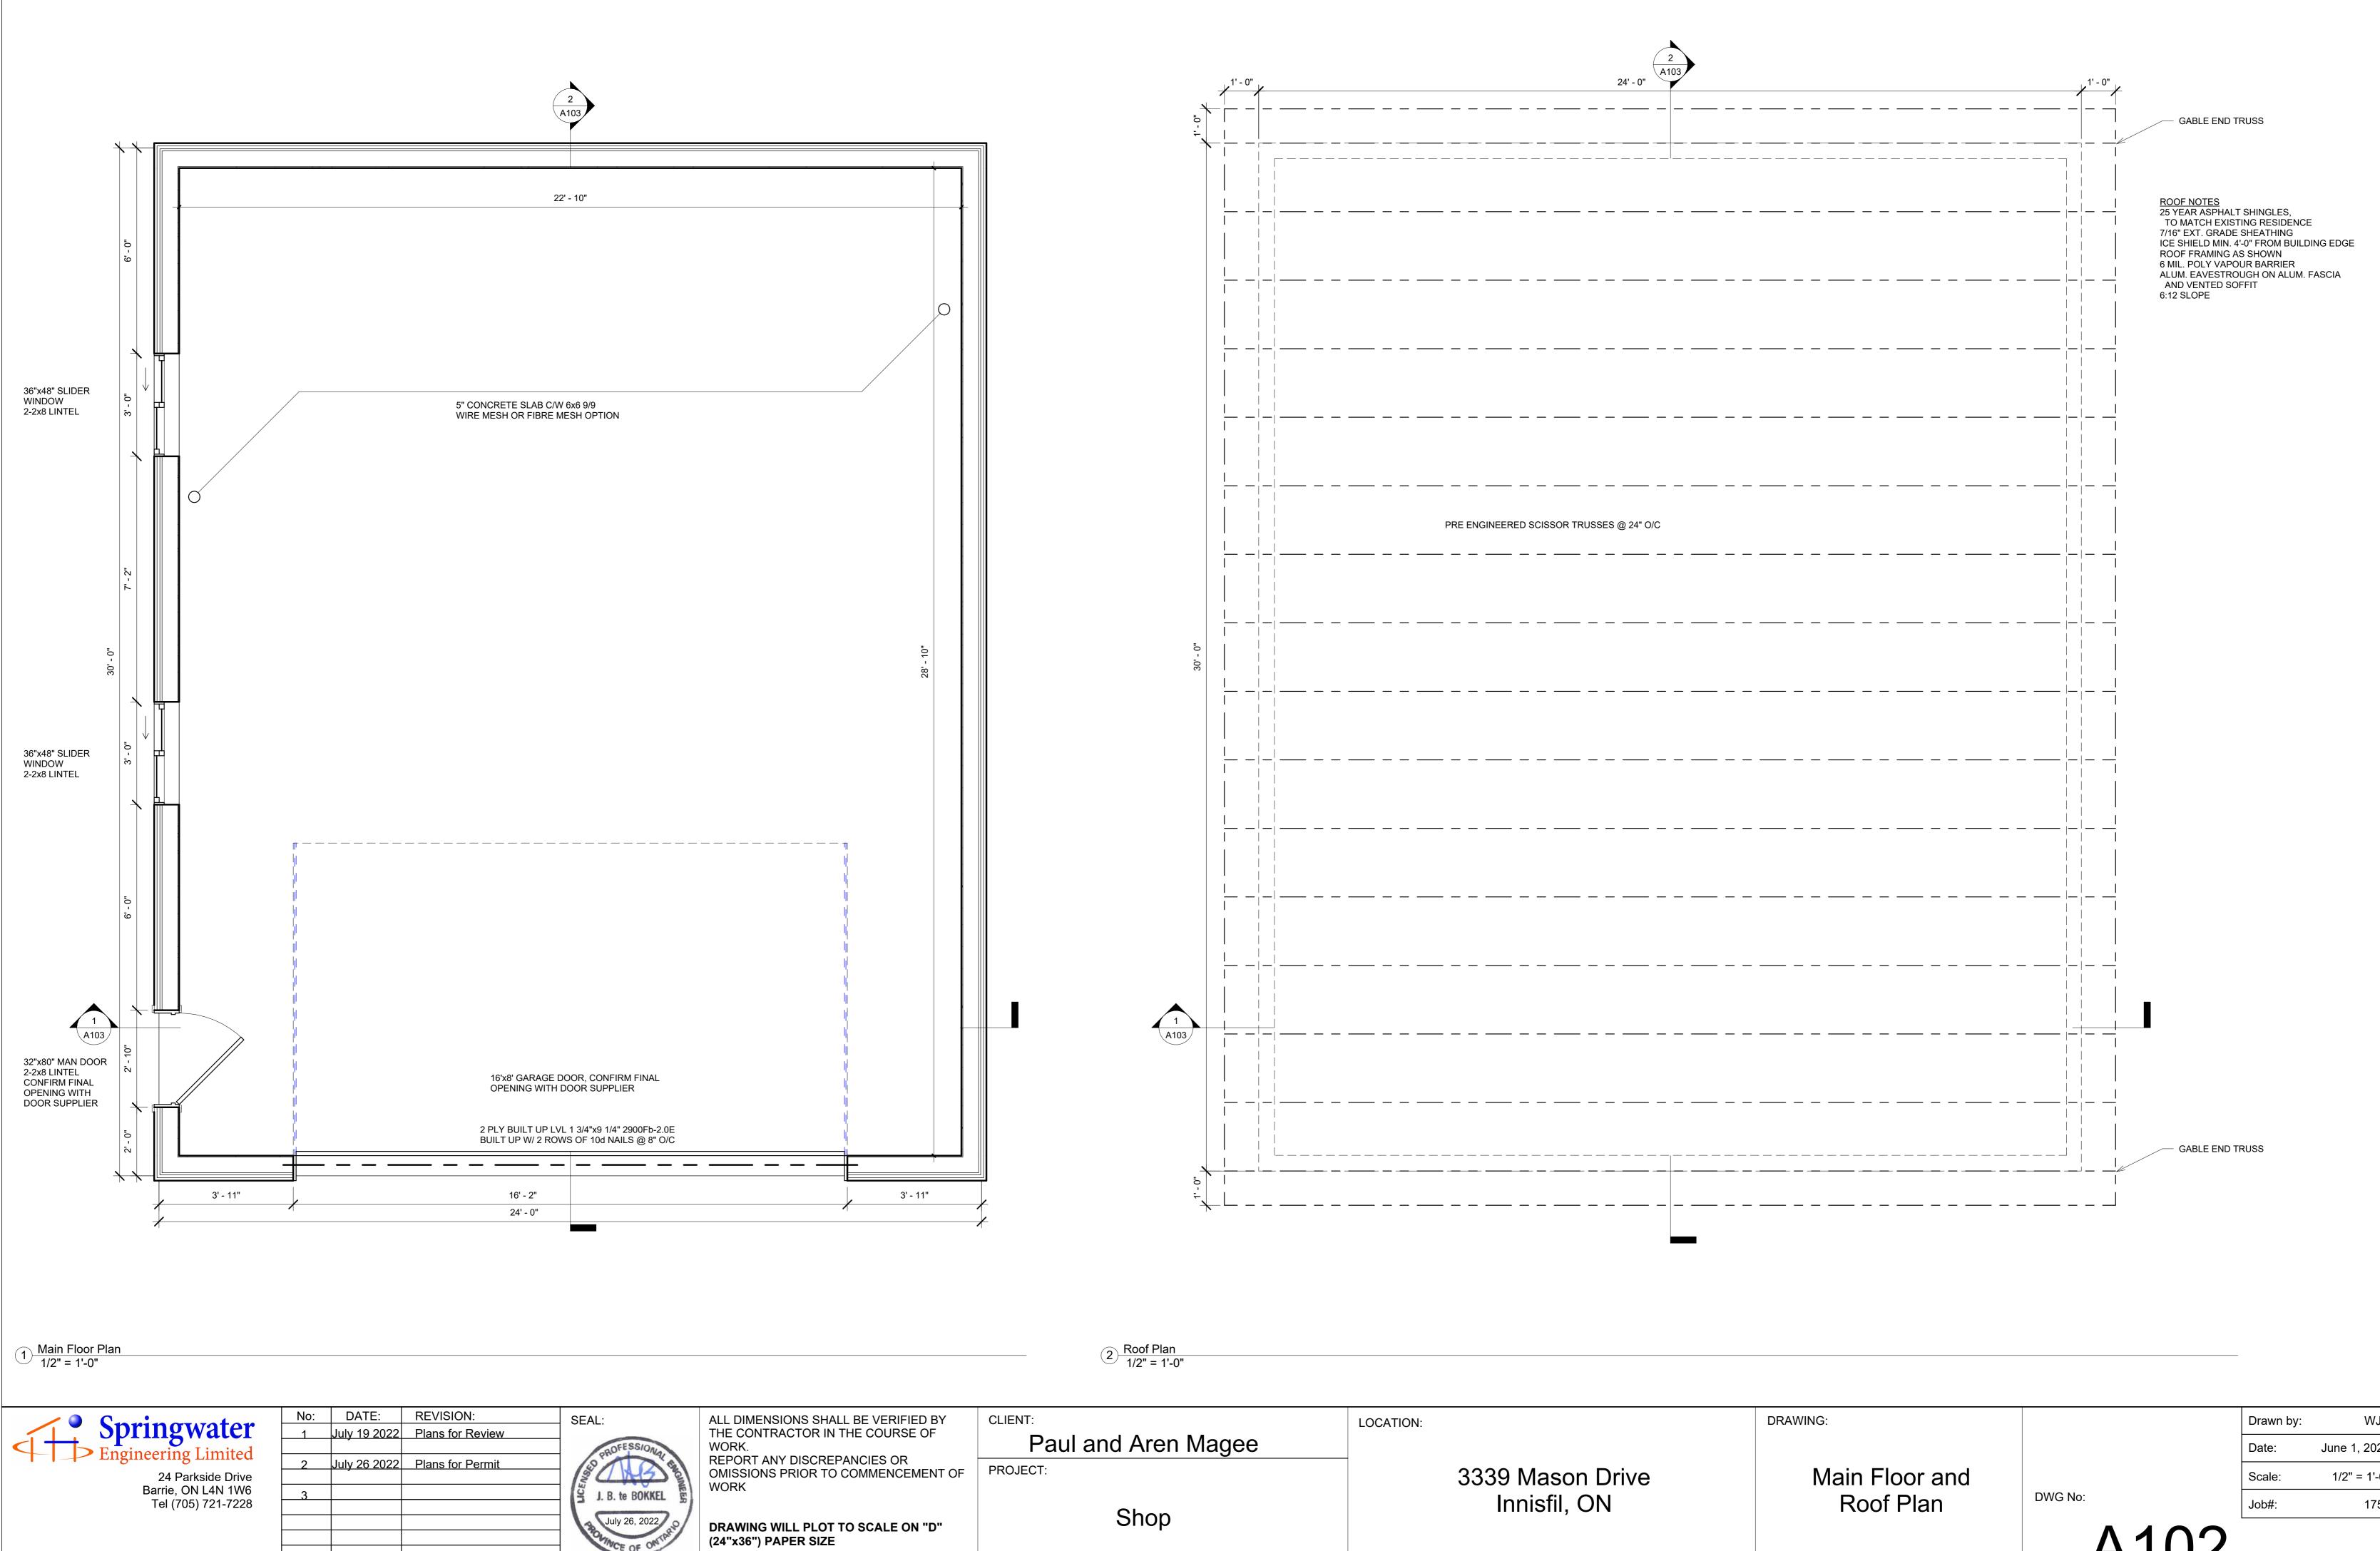

SHALL BE VERIFIED BY	CLIENT:	LOCATION:		DRAWING:		Drawn by:	WJE
OR IN THE COURSE OF	Paul and Aren Magee					Date:	June 1, 2022
CREPANCIES OR R TO COMMENCEMENT OF	PROJECT:		3339 Mason Drive	Main Floor and		Scale:	1/2" = 1'-0"
	Chan		Innisfil, ON	Roof Plan	DWG No:	Job#:	1751
PLOT TO SCALE ON "D" SIZE	Shop				A102		

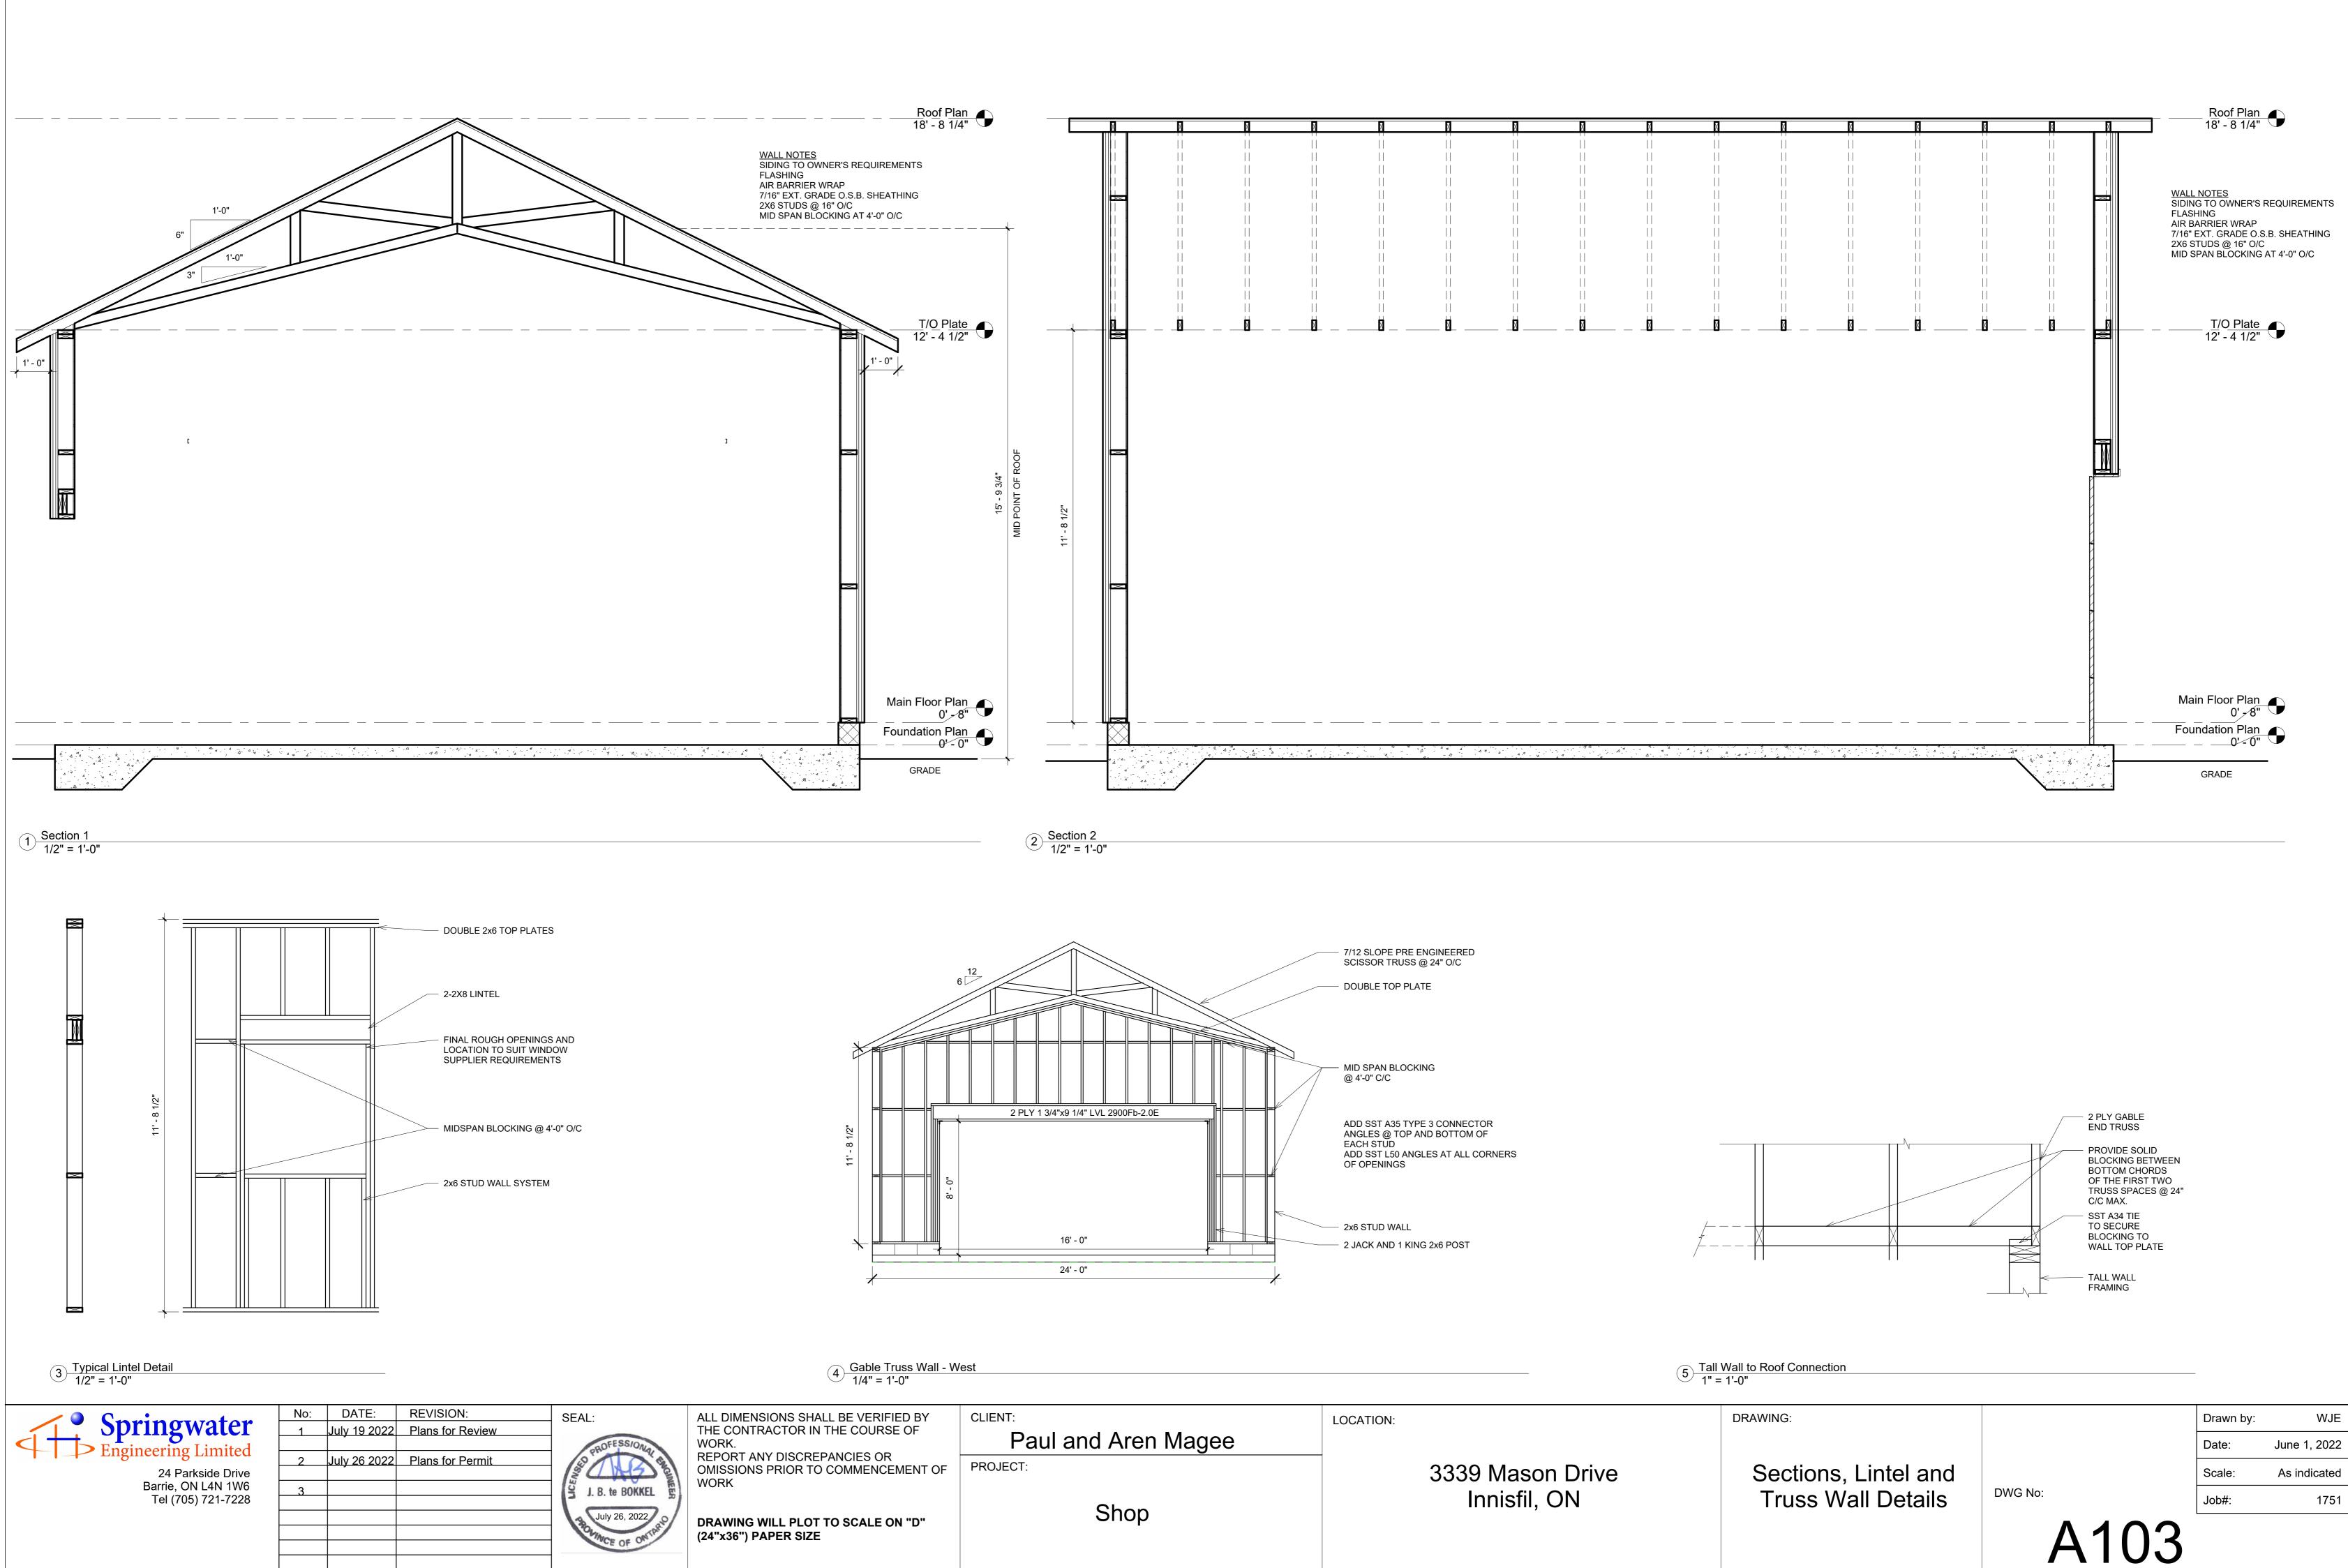

IS SHALL BE VERIFIED BY	CLIENT:	LOCATION:	
OR IN THE COURSE OF	Paul and Aren Magee		
ISCREPANCIES OR OR TO COMMENCEMENT OF	PROJECT:	3339 Mason Dri	V
PLOT TO SCALE ON "D" R SIZE	Shop	Innisfil, ON	

WJE June 1, 2022 As indicated 1751



SHALL BE VERIFIED BY	CLIENT:	LOCATION:	
OR IN THE COURSE OF	Paul and Aren Magee		
CREPANCIES OR R TO COMMENCEMENT OF	PROJECT:		3339 Mason Drive
PLOT TO SCALE ON "D" SIZE	Shop		Innisfil, ON

C	DRAWING:		Drawn by:	WJE
			Date:	June 1, 2022
	Elevations		Scale:	3/8" = 1'-0"
Elevation	Elevations	DWG No:	Job#:	1751
		A104		





SOUTHWEST CORNER



No: DATE: **REVISION:** SEAL: ALL DIMENSIONS July 19 2022 Plans for Review THE CONTRACTOR WORK. **REPORT ANY DISC** 2 July 26 2022 Plans for Permit **OMISSIONS PRIOF** WORK J. B. te BOKKEL July 26, 2022 DRAWING WILL P (24"x36") PAPER

SHALL BE VERIFIED BY R IN THE COURSE OF	CLIENT:	LOCATION:	DRAWING:		Drawn by:	WJE
	Paul and Aren Magee				Date:	June 1, 2022
CREPANCIES OR R TO COMMENCEMENT OF	PROJECT:	3339 Mason Drive	Developing and Nates		Scale:	1 1/2" = 1'-0"
	Shan	Innisfil, ON	Renderings and Notes	DWG No:	Job#:	1751
LOT TO SCALE ON "D" SIZE	Shop					
				CUTA		

## GENERAL NOTES:

1. THIS DRAWING SET IS THE PROPERTY OF SPRINGWATER ENGINEERING LIMITED (SEL) AND MAY NOT BE REPRODUCED OR USED WITHOUT THE EXPRESSED WRITTEN CONSENT OF SPRINGWATER ENGINEERING. 2. ALL DRAWINGS TO BE READ IN CONJUNCTION WITH GENERAL NOTES AND SPECIFICATIONS.

3. DO NOT SCALE DRAWINGS. CONTRACTOR TO VERIFY ALL EXISTING CONDITIONS. CONTRACTOR TO VERIFY ALL LEVELS AND DIMENSIONS PROVIDED AND REQUIRED TO PERFORM THE WORK. ANY DISCREPANCIES ARE TO BE REPORTED TO SPRINGWATER ENGINEERING IMMEDIATELY TO OBTAIN CLARIFICATION PRIOR TO COMMENCING WORK.

4. DESIGN LOADS ARE NOTED. THEY SHALL NOT BE EXCEEDED DURING CONSTRUCTION. UNLESS SPECIFICALLY NOTED OTHERWISE ON THE DRAWINGS, NO PROVISION HAS BEEN MADE IN THE DESIGN FOR CONDITIONS OCCURRING DURING CONSTRUCTION. THE CONTRACTOR IS TO PROVIDE ALL NECESSARY BRACING AND SHORING REQUIRED FOR STRESSES AND INSTABILITY OCCURRING FROM ANY CAUSE DURING CONSTRUCTION.

5. NO SUBSTITUTIONS. CONTRACTOR AGREES TO USE ALL SPECIFIED MATERIALS WITHOUT SUBSTITUTION. NON SPECIFIED MATERIALS MUST BE APPROVED SPRINGWATER ENGINEERING PRIOR TO USE. NON SPECIFIED OR APPROVED MATERIALS WILL BE REMOVED AND REPLACED WITH SPECIFIED MATERIALS AT CONTRACTOR'S COST. 6. THE CONTRACTOR SHALL BE SOLELY RESPONSIBLE FOR CONSTRUCTION MEANS, METHODS, TECHNIQUES, SEQUENCES, AND PROCEDURES AND FOR CO-ORDINATING THE VARIOUS PARTS OF THE WORK. ADDITIONAL COSTS INCURRED AS A

RESULT OF ANY OF THE ABOVE ARE THE RESPONSIBILITY OF THE CONTRACTOR. 7. TYPICAL STRUCTURAL DETAILS ARE SHOWN ON DRAWINGS. IF DETAILS DIFFER ON OTHER DRAWINGS, THE MOST STRINGENT SHALL GOVERN. ALL WORK SHALL BE CARRIED OUT IN ACCORDANCE WITH THE REQUIREMENTS OF THE ONTARIO

BUILDING CODE 2012 (OBC 2012) AND THE OCCUPATIONAL HEALTH AND SAFETY ACT. 8. PROVIDE ALL ACCESSORY ITEMS OR MATERIALS, SUCH AS BRACKETS, CLEATS, UNDERLAYS, OVERLAYS, CONNECTORS, FASTENERS, COVER PLATES, SEALANTS, LUBRICANTS, CLEANERS, BONDING AGENTS, AND SIMILAR ITEMS, WHETHER SPECIFIED OR NOT, SO THAT THE WORK IS COMPLETE AND WILL PERFORM AS REQUIRED.

9. SPRINGWATER ENGINEERING LIMITED'S SCOPE IS LIMITED TO STRUCTURAL DESIGN AND DETAILS OF THE PROPOSED NEW DETACHED GARAGE.

LOCATION: INNISFIL, ONTARIO ROOF LOADS DEAD LOAD: 0.72 kPa (15 psf) LIVE LOAD: 1.9 kPa (50 psf) Ss = 2.5 kPa / Sr = 0.4 kPa S = (0.55\*2.5)+0.4 = 1.775 kPa

S = 1.775 kPa S = 37.1 psf

CAST-IN-PLACE CONCRETE AND REINFORCEMENT

GENERAL 1. ALL CONCRETE CONSTRUCTION SHALL CONFORM TO CSA A23.1, CSA A23.2 AND CSA A23.3.

2. CONCRETE QUALITY IS TO BE TESTED BY THE OWNERS' AGENCY ACCORDING TO CSA A23.2 INCLUDING STRENGTH, AIR CONTENT AND SLUMP TESTS FOR EACH CONCRETE POUR, WITH REPORTS SUBMITTED TO THE ENGINEER. 3. THE CONTRACTOR SHALL NOT PROCEED WITH PLACING CONCRETE THAT FAILS TO MEET THE SPECIFIED SLUMP OR AIR CONTENT REQUIREMENTS OR EXCEEDS 2 HOURS AFTER BATCHING.

PRODUCTS 1. PORTLAND CEMENT, WATER AND AGGREGATES SHALL CONFORM TO CSA A23.1 AND SHALL HAVE THE FOLLOWING PROPERTIES:

2. NOMINAL MAXIMUM COARSE AGGREGATE SIZE - 1/2". 3. REINFORCING STEEL SHALL BE DEFORMED BARS CONFORMING TO CSA G30.18 - GRADE 400 MPA UNLESS NOTED OTHERWISE.

4. WELDED WIRE FABRIC TO CONFORM TO CSA G30.5. 5. REINFORCING STEEL SHALL BE DETAILED, BENT, PLACED AND SUPPORTED IN CONFORMANCE WITH CSA A23.3, ACI STANDARD 315 AND THE REINFORCING STEEL - MANUAL OF STANDARD PRACTICE PUBLISHED BY THE REINFORCING STEEL INSTITUTE OF CANADA.

6. CONCRETE MINIMUM COMPRESSIVE STRENGTH AT 28 DAYS SHALL BE AS FOLLOWS: A. EXTERIOR SLABS ON GRADE, FLATWORK 32 MPA WITH 5-8% AIR ENTRAINMENT

EXECUTION 1. UNLESS NOTED OTHERWISE CONCRETE COVER FOR REINFORCEMENT SHALL MEET THE FOLLOWING REQUIREMENTS: A. WHEN CAST AGAINST EARTH 75MM (3")

2. PROVIDE CORNER BARS AND HOOKED DOWELS (26"x26") AT CORNERS. 3 ADD FLOOR HARDENERS, WATERPROOFING AGENTS IF REQUIRED PER OWNER'S PREFERENCE. FOUNDATIONS / BACKFILLING AND COMPACTION

## GENERAI

1. ALL FOOTINGS TO BEAR ON COMPACTED GRANULAR ON UNDISTURBED SOIL WITH MINIMUM ALLOWABLE SOIL BEARING CAPACITY OF 75KPA.

EXECUTION 1. REMOVE TOPSOIL AND OTHER ORGANIC MATERIAL FROM THE BUILDING AREA.

2. PROTECT EXCAVATED SURFACE FROM WATER OR FROST DAMAGE, WHERE APPLICABLE.

3. KEEP EXCAVATIONS CONTINUOUSLY DRY BEFORE CONCRETE IS PLACED.

4. UNLESS OTHERWISE NOTED, PROVIDE IMMEDIATELY UNDER SLABS-ON-GRADE A MINIMUM OF 150MM (6") OF COMPACTED GRANULAR A MATERIAL 5. PROVIDE POSITIVE DRAINAGE FOR ALL EXTERIOR SURFACES, AND INTERIOR SURFACES PROVIDED WITH DRAINS, WITH CONSTANT SLOPES TO DRAINS OR DRAINAGE COURSES, AND AWAY FROM CONSTRUCTION.

6. PROVIDE PERIMETER DRAINING TILE WHERE SURROUNDING SOIL IS NOT FREE DRAINING.

WOOD FRAMING NOTES:

1. WOOD CONSTRUCTION SHALL CONFORM TO ONTARIO BUILDING CODE 2012, PART 9 UNLESS NOTED OTHERWISE. 2. LUMBER: - UNLESS OTHERWISE NOTED TO BE SPRUCE-PINE-FIR (SPF), GRADE NO.1/NO.2, CONFORMING TO CSA STANDARD 0141 WITH A MAXIMUM MOISTURE CONTENT OF 19 % AT THE TIME OF INSTALLATION. ALL LUMBER SHALL BEAR THE GRADING STAMP OF AN AGENCY APPROVED BY THE CANADIAN LUMBER STANDARDS ADMINISTRATION BOARD. 3. UNLESS NOTED OTHERWISE, ALL TIMBER MEMBERS TO BE DOUGLAS FIR #1 GRADE.

4. COMPLY WITH THE REQUIREMENTS OF ONTARIO BUILDING CODE FOR SUB-FLOORING IN TABLE 9.23.14.A, ROOF

SHEATHING IN TABLE 9.23.15.A, AND WALL SHEATHING IN TABLE 9.23.16.A. 5. NAILS, SPIKES, AND STAPLES: - TO CSA STANDARD B111; GALVANIZED FOR EXTERIOR WORK, OR HIGHLY HUMID AREAS AND FOR TREATED LUMBER; PLAIN ELSEWHERE. NAILING OF FRAMING UNLESS OTHERWISE NOTED, SHALL CONFORM TO TABLES 9.23.3 A, B, AND 9.23.13 A IN THE ONTARIO BUILDING CODE.

6. ROUGH HARDWARE: - BOLTS, NUTS, WASHERS, LAGS, PINS, SCREWS, ALL TO BE HOT DIP GALVANIZED IF EXPOSED TO EXTERIOR USE. 7. WOOD PRESERVATIVES (PRESSURE TREATED): - WHERE REQUIRED TO CONFORM TO CSA STANDARD 080-M. ALL WOOD

PRODUCTS BEARING ON CONCRETE OR MASONRY AT OR BELOW GRADE TO BE PRESSURE TREATED OR BE PROTECTED WITH A MINIMUM 0.05 POLYETHYLENE VAPOUR BARRIER, ROLL ROOFING, OR APPROVED EQUIVALENT. 8. ALL WOOD PRODUCT EXPOSED DIRECTLY TO SOIL SHALL BE PRESSURE TREATED.

9. FRAMING ANCHORS: - FRAMING ANCHORS, JOIST HANGERS, BEAM HANGERS, POST CAPS, POST ANCHORS, BACK-UP CLIPS AND ANGLES, UNLESS OTHERWISE SHOWN ON THE STRUCTURAL DRAWINGS, ARE ALL TO BE AS MANUFACTURED BY SIMPSON OR AN APPROVED EQUAL, AND SIZED APPROPRIATELY FOR THE CONNECTING MEMBERS. ALL ARE TO BE INSTALLED IN STRICT ACCORDANCE WITH THE MANUFACTURER'S INSTRUCTIONS AND SPECIFICATIONS UTILIZING NAILS OR SCREWS WHERE REQUIRED.

10. SPLICES, NOTCHING, AND DRILLING THROUGH MEMBERS IS NOT PERMITTED EXCEPT AS SPECIFIED BY THESE PLANS AND/OR AS APPROVED BY THE ENGINEER. 11. MANUFACTURED LUMBER OR TIMBER PRODUCTS NOT SPECIFIED HEREIN ARE TO BE APPROVED BY THE ENGINEER

PRIOR TO USE. MANUFACTURED WOOD PRODUCT TO BE INSTALLED AS PER THE MANUFACTURER'S SPECIFICATIONS AND INSTRUCTIONS. 12.NUMBER, SIZE, AND LOCATION OF BRACING, BLOCKING, AND BRIDGING BETWEEN LUMBER OR TIMBER STRUCTURAL

ELEMENTS TO CONFORM TO THE REQUIREMENTS IN THE ONTARIO BUILDING CODE PART 9.

13. MINIMUM BEARING OF WOOD JOISTS TO BE MINIMUM 1.5" (38mm).

14. MINIMUM BEARING OF WOOD BEAMS TO BE MINIMUM 3" (76mm). 15. MINIMUM BEARING OF WOOD ELEMENTS NOT SPECIFIED TO BE MINIMUM 3" (76mm).

16. ALL MULTIPLY WOOD MEMBERS SHALL BE BUILT-UP IN ACCORDANCE WITH OBC 2012, PART 9 OR PER MANUFACTURER'S SPECIFICATIONS AND GUIDELINES. 17. ALL LVL BEAMS SHALL MEET OR EXCEED 2.0E, 3100Fb.

18. PROVIDE ALL WOOD AND BRICK LINTELS PER OBC 2012, PART 9.