



COMMITTEE OF ADJUSTMENT NOTICE OF PUBLIC HEARING APPLICATION NO. A-023-2025 & A-024-2025

TAKE NOTICE that an application has been received by the Town of Innisfil from **Amy & Adam Skidmore**, **Owner**, for a minor variance from Zoning By-law 080-13, pursuant to Section 45 of the *Planning Act*, R.S.O. 1990, c. P.13, as amended.

The subject properties are described legally as PLAN 1065 LOT 23 RP 51R7727 PART 5 known municipally as 3867 Dixon Rd and is zoned "Residential (R1)".

The applicant is seeking relief from Section 3.3b of the Zoning By-Law which limits the gross floor area of an accessory building to 50m2. The applicant is proposing to construct a detached garage with ADU with a gross floor area of approximately 185m2.

The applicant is seeking relief from Section 3.5i) of the Zoning By-Law which does not permit detached accessory dwelling units in the front yard. In the case of this through lot, the front yard has been identified as Big Bay Point Rd as per Section 2.125e) of the Zoning By-law.

The Committee of Adjustment for the Town of Innisfil will consider this application in person at Town Hall and virtually through Zoom on **Thursday**, **July 17**, **2025**, **at 6:30 PM**.

To participate in the hearing and/or provide comments, you must register by following the link below or scanning the above QR code: <u>https://innisfil.ca/en/building-and-</u> <u>development/committee-of-adjustment-</u> <u>hearings.aspx</u>

Requests can also be submitted in writing to: Town of Innisfil Committee of Adjustment, 2101 Innisfil Beach Road, Innisfil, Ontario, L9S 1A1 or by email to <u>planning@innisfil.ca</u>.


If you wish to receive a copy of the decision of the Committee of Adjustment in respect of the proposed consent, you must make a written request to the Secretary-Treasurer of the Committee of Adjustment by way of email or regular mail. The Notice of Decision will also explain the process for appealing a decision to the Ontario Land Tribunal (OLT).



Additional information relating to the proposed application is available on the Town of Innisfil website. Accessible formats are available on request, to support participation in all aspects of the feedback process. To request an alternate format please contact Planning Services at <u>planning@innisfil.ca</u>.

Dated: June 27, 2025


Sarah Burton Hopkins, Secretary Treasurer <u>sburtonhopkins@innisfil.ca</u> 705-436-3710 ext. 3504

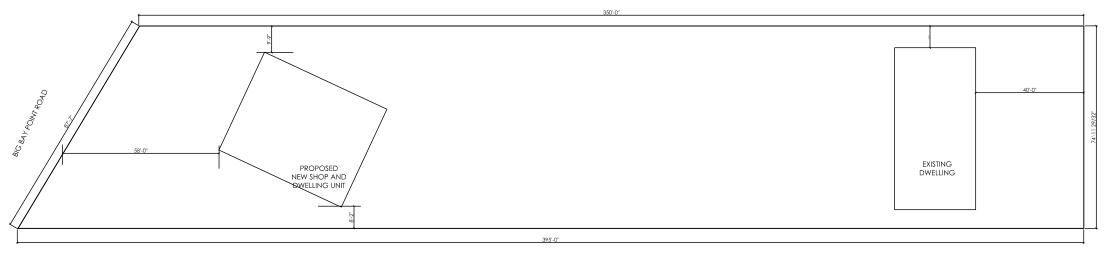


	THE COMMENCEME AND REPORT ANY D	MENSIONS PRIOR TO INT OF CONSTRUCTION, DISCREPANCIES TO THE ITRACTOR MUST COMPLY ID PROVINCIAL BUILDING	The undersigned has reviewed and takes responsibility for this design, and meets t requirements set out in the 2012 Ontario Building Code to be a designer. QUALIFICATION INFORMATION Required unless exempt under 3.2.5.1 Division C of the Building Code		<u>Site Plan</u>
8254 8th Lne	INDIVIDUAL BCIN:	14607	HEATHER MIDDLEBROOK H Middlhood 14607 NAME SIGNATURE BCIN		
Utopia, On PHONE (705) 424 8800 CELL (705) 796 8380 E MAIL: bootbor@finaling.crafting.cra	FIRM BCIN:	108381	REGISTRATION INFORMATION Required unless exempt under 3.2.4.1 Division C of the Building Code	PROJECT ADDRESS	
E-MAIL: heather@finelinedrafting.ca www.finelinedrafting.ca	DRAWN BY:	H.M.	FINE LINE DESIGN SERVICES 108381 FIRM NAME BCIN		Innisfil

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CLIENT NAME:		SCALE:
SKIDMORE		n.t.s
PROJECT:	PROPOSED NEW SHOP AND DWELLING UNIT	JOB NUMBER: 24-052
START DATE:	April 1 2024	DRAWING NUMBER: C 1
PRINT DATE:	Sept 8 2024	31

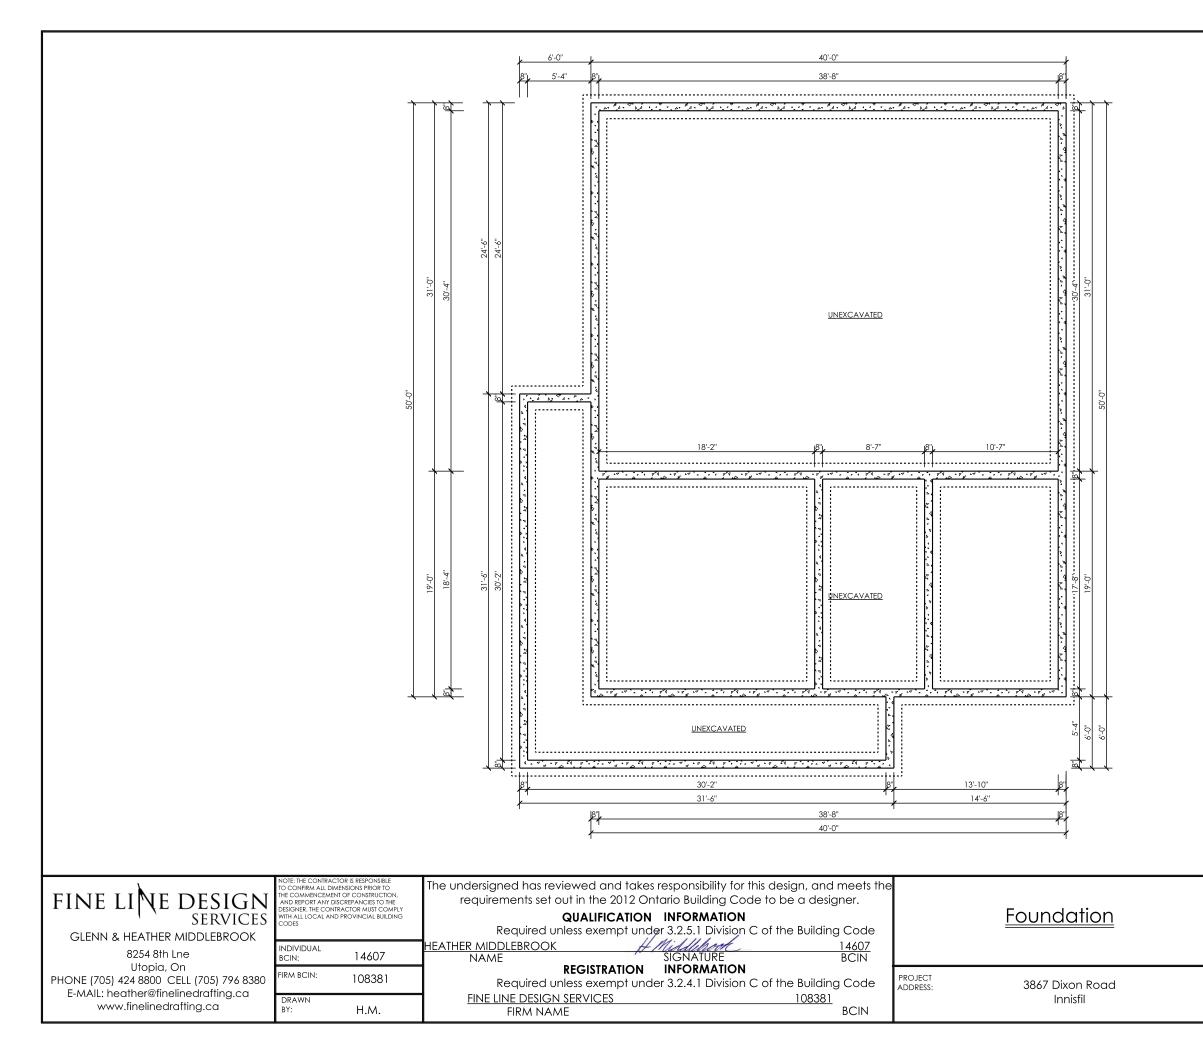


CLIENT NAME: SKIDMORE		SCALE: 1/8"=1'-0"
PROJECT:	PROPOSED NEW SHOP AND DWELLING UNIT	JOB NUMBER: 24-052
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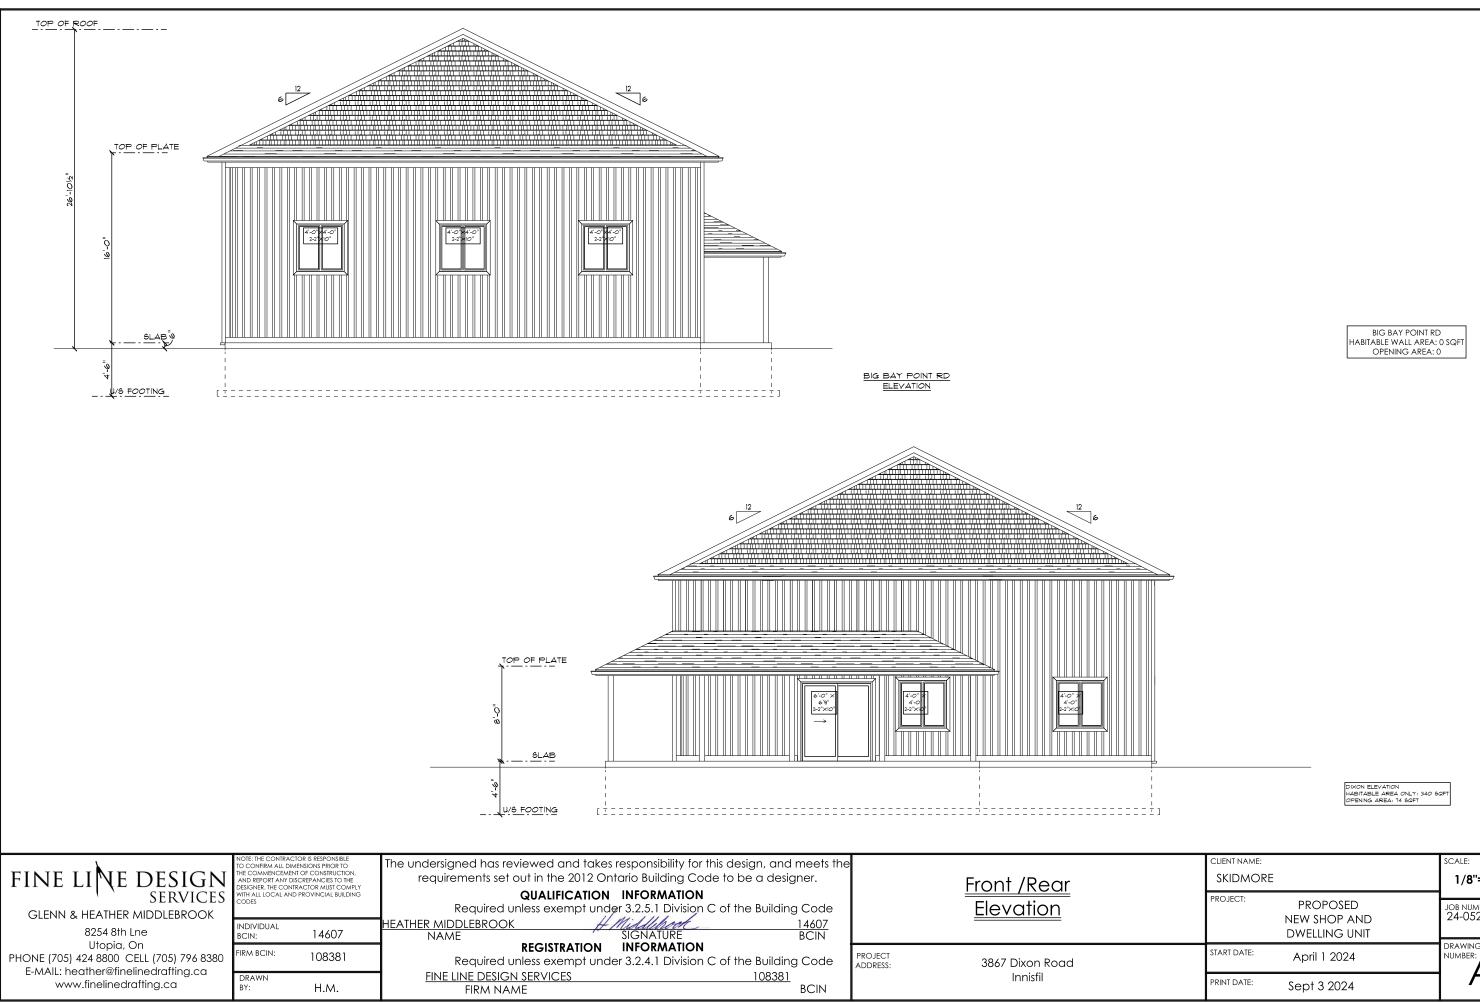
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PRINT DATE:	Sept 3 2024	AZ

LOAD BEARING WALL 2"X6" * 16" O.C. 12"X6" CONT FOOTING

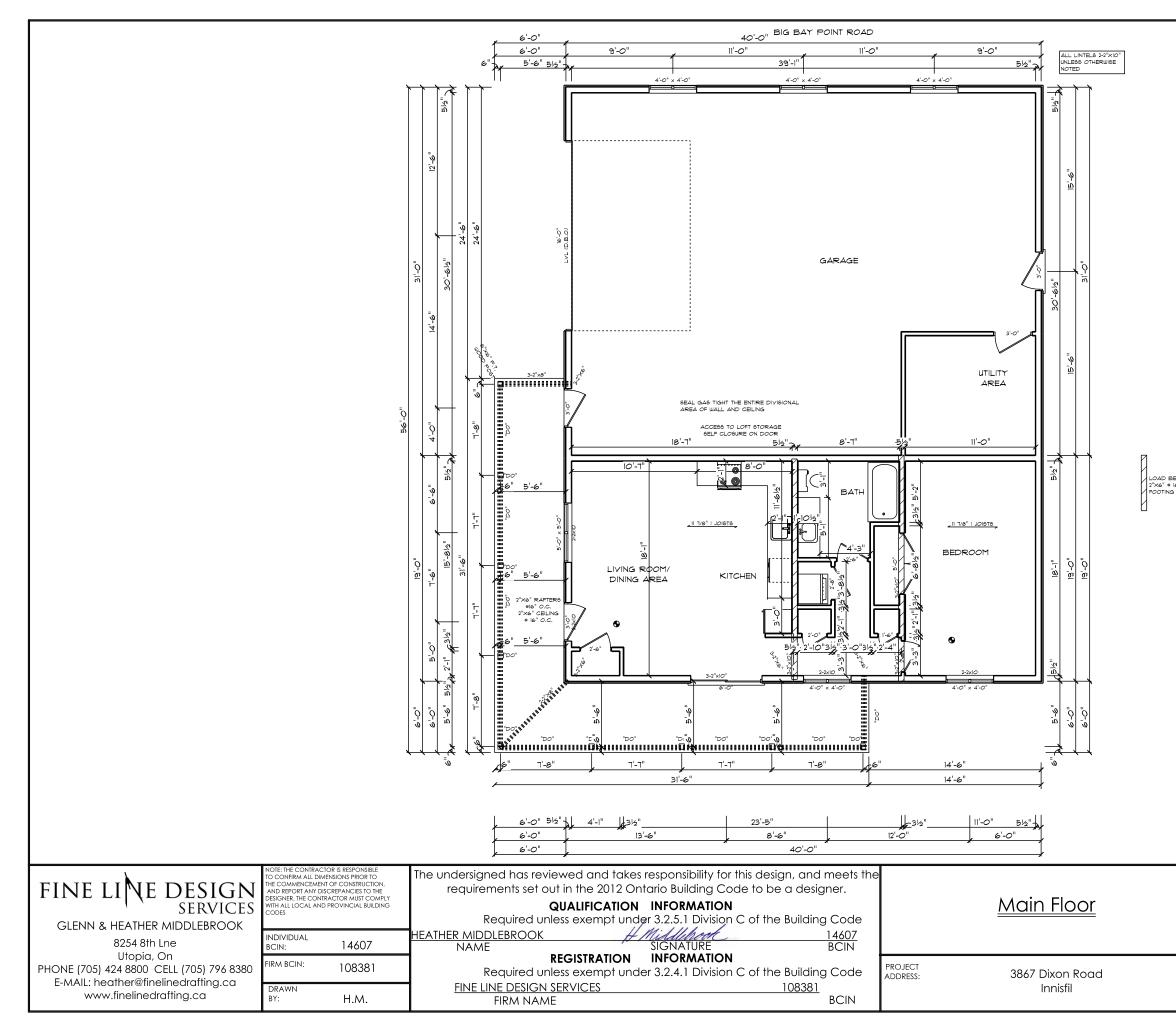


	NOTE: THE CONTRAC TO CONFIRM ALL DIA THE COMMENCEMEI AND REPORT ANY D DESIGNER. THE CON WITH ALL LOCAL AN CODES	MENSIONS PRIOR TO NT OF CONSTRUCTION, ISCREPANCIES TO THE TRACTOR MUST COMPLY	The undersigned has reviewed and takes responsibility for this design, and meets the requirements set out in the 2012 Ontario Building Code to be a designer. QUALIFICATION INFORMATION Required unless exempt under 3.2.5.1 Division C of the Building Code	le	Loft Area
8254 8th Lne		14607	HEATHER MIDDLEBROOK H Middlehood 14607 NAME SIGNATURE BCIN		
	BCIN:	14007	TO THE BOILT		
PHONE (705) 424 8800 CELL (705) 796 8380	FIRM BCIN:	108381	REGISTRATION INFORMATION Required unless exempt under 3.2.4.1 Division C of the Building Code	PROJECT ADDRESS:	3867 Dixon Road
E-MAIL: heather@finelinedrafting.ca www.finelinedrafting.ca	DRAWN BY:	H.M.	FINE LINE DESIGN SERVICES108381FIRM NAMEBCIN		Innisfil

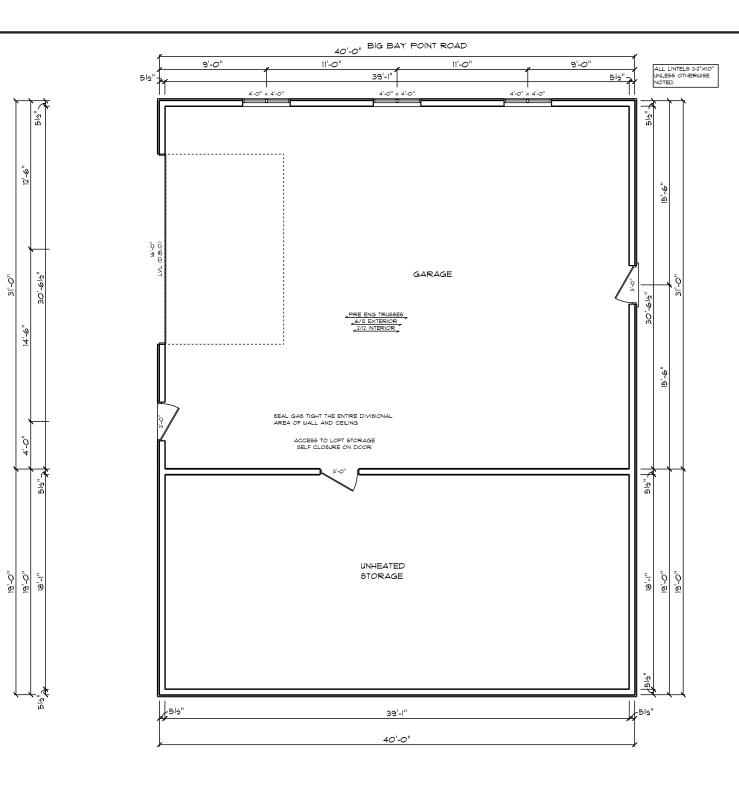
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BIG BAY POINT RD HABITABLE WALL AREA: 0 SQFT OPENING AREA: 0
HABITABLE WALL AREA: 0 SQFT

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ENERGY EFFICIENCY COMPLIANCE PATH		<u>GENERAL NOTES</u>		<u>GENERAL N</u>
SB-12 PRESCRIPTIVE PACKAGE A1 (TABLE 3.1.1.2.A)		1. ALL WORK SHALL COMPLY WITH THE LATEST ED ONTARIO BUILDING CODE.	DITION OF THE	19. MINIMUM LUMBE OTHERWISE.
MINIMUM INSULATION LEVELS & MECHANICALS:		2. ALL WORK SHALL ALSO COMPLY WITH ALL LOG BY-LAWS, AND OTHER AUTHORITIES HAVING JU	JRISDICTION	20. CONCRETE STREM - FOUNDATION
CEILING WITH ATTIC SPACE	R 60 (EFFECTIVE R 59.22)	RELATED TO THE CONSTRUCTION OF THIS PRO. 3. WINDOW AND DOOR R.S.O. TO BE VERIFIED BY		- FOOTINGS 20 - BASEMENT OR
CEILING WITHOUT ATTIC SPACE	R 31 (EFFECTIVE R 29.80)	 OR OWNER. 4. ATTIC ACCESS HATCH TO BE A MINIMUM OF 3 DIMENSION LESS THAN 21 1/2". 	4 SQ. FT. WITH NO	- GARAGE SLAE 21. STEP FOOTING - MINIMUM HOF
EXPOSED FLOOR	R 31 (EFFECTIVE R 29.80)	 5. ROOF VENTILATION TO BE MIN. 1 SQ.FT. FOR EV CEILING IF CEILING CONTAINS AN ATTIC SPACE 		- MAXIMUM VEI 22. STAIRS
WALLS ABOVE GRADE	R 22 (EFFECTIVE R 17.03)	6. ROOF VENTILATION TO BE MIN 1 SQ. FT. FOR EV CEILING IF CEILING DOES NOT CONTAIN AN A	/ERY 150 SQ,FT. OF INSULATED	- MAINTAIN 6'5" - MAXIMUM RIS
BASEMENT WALLS	R 20 ci (EFFECTIVE R 21.12)	7. SMOKE ALARMS TO BE INTERCONNECTED AND ON THE DRAWINGS.		- MINIMUM RISE - MINIMUM RUN
ELOW GRADE SLAB > 600mm (1'11 5/8'') BELOW GRADE	N/A	8. SMOKE ALARMS SHALL COMFORM TO CAN/U PERMANENT CONNECTION TO AN ELECTRICAL		- MAXIMUM RU - MINIMUM TRE
eated slab or slab < 600mm (1'11 5/8'') below grade	R 10 (EFFECTIVE R 11.13)	 SWITCH. CARBON MONOXIDE DETECTORS TO BE INTERCONSTRUCTION 	Connected and installed in	- MAXIMUM TRE - RISE AND RUN
DGE OF BELOW GRADE SLAB < 600mm (1'11 5/8'') BELOW GRADE	R 10	LOCATIONS NOTED ON THE DRAWINGS. 10. EXTERIOR DOOR TO BE RESISTANT TO FORCED	ENTRY AND INCLUDE:	23. GUARDS - PROVIDE GUA
/INDOWS AND SLIDING GLASS DOORS	MAX. U-VALUE 0.28 / 25 ER	- DEAD BOLT LOCK - SOLID BLOCKING AT LOCK HEIGHT - DOOR VIEWER, WINDOW OR SIDELIGHT		- PROVIDE GUA EACH SIDE NC - GUARD HEIGH
(YLIGHTS	MAX. U-VALUE 0.49	- HINGES TO BE SCREWED TO PENETRATE SOLI 11. EXTERIOR AND INTERIOR LOADBEARING LINTEL		- GUARD HEIGH - GUARD HEIGH - MINIMMUN
PACE HEATING EQUIPMENT	MIMIMUN AFUE 96 %	OTHERWISE INDICATED. 12. STEEL LINTELS TO BE PROVIDED FOR BRICK VEN		BETWEEN 1 - MINIMUM
EAT RECOVERY VENTILATOR (HRV)	MIMIMUM SRE 75 %	- SPAN UP TO 8'1" L 3 1/2" X 3 1/2" X 1/4" - SPAN 8'1" - 8'9" L 4" X 3 1/2" X 1/4"		Than 5'11' - Picket Spacii
OMESTIC HOT WATER TANK	MINIMUM EF 0.80	- SPAN 8'9" - 10'10" L 4 7/8" X 3 1/2" X 5/16" - SPAN 10'10" - 11'5" L 4 7/8" X 3 1/3" X 3/8"		- GUARD TO BE BETWEEN 5 1/2
RAIN WATER HEAT RECOVERY (DWHR)	MIMIMUM EFFICIENCY 42 %	- SPANS GREATER THAN 11'5" REFER TO DRAW 13. UNLESS NOTED OTHERWISE STEEL COLUMNS SH		24. HANDRAILS - HANDRAILS T
UD WALL REINFORCEMENT		 6" X 6" TOP PLATE, AND 6" X 6" BASE PLATE. 14. FRAMING AROUND FLOOR OPENINGS: HEADER JOISTS OVER 3'11" IN LENGTH TO BI 		- HANDRAILS T - HANDRAIL HE FROM THE NO
STUD WALL REINFORCEMENT - STUD WALL REINFORCEMENT - STUD WALL REINFORCEMENT SHALL BE PROVIDED IN THE MAIN BATHROOM DWELLING UNIT FOR THE FUTURE INSTALLATION OF GRAB BARS. - BLOCKING SHOWN SHALL CONSIST OF MINIMUM 2" X 8" ON THE FLAT ATTA WALL STUDS WITH 4 - 3 1/4" ARDOX. NAILS EACH END.	WALL TUB FAUCET END	 SIZE OF HEADER JOISTS EXCEEDING 10'6' IN TRIMMER JOISTS OVER 2'7" IN LENGTH TO BE SIZE OF TRIMMER JOISTS TO BE DESIGNED BY EXCEEDS 6'7" IN LENGTH 15. SUPPORT OF NON-LOAD BEARING WALLS BY D BLOCKING @ 3'11" O.C. 16. PROVIDE MINIMUM BEARING FOR WOOD FRA BEARING FOR BEAMS - 3 1/2" UNLESS NOTED BEARING OF LINTELS - 1 1/2" UNLESS NOTED OTHI ROOF RAFTERS - 1 1/2" UNLESS NOTED OTHI ROOF RAFTERS - 1 1/2" UNLESS NOTED OTHI FOOTING DESIGN ASSUMES STABLE SOILS WI PRESSURE OF 75 KPa SEE DRAWINGS FOR FOOTING SIZES FOOTING SIZED TO BE DOUBLED IF HIGH WA 18. BRICK VENEER GALVANIZED 7"X 7/8" .03" BRICK TIES MINIMU 24" VERTICAL. TIE BRICK VENEER TO WOOD F PROVIDE WEEP HOLES AT 2'7" MAX. AT BOTT OVER DOOR AND WINDOWS PROVIDE BASE FLASHING FOR WEEP HOLES WALL 	LENGTH TO BE DESIGNED BY OTHERS DOUBLED OTHERS WHEN HEADER JOIST DOUBLE JOISTS UNDER OR SOLID MING MEMBERS AS FOLLOWS: D OTHERWISE OTHERWISE ERWISE ERWISE ITH AN ALLOWABLE BEARING TER TABLE IS ENCOUNTERED JM 16"O.C. HORIZONTAL AND FRAMING OM OF AIR SPACE / CAVITY, AND	DESIGNER 1. CONTRACTOR O AS INDICATED (D 2. DESIGNER ASSUM SUBCONTRACTO ACCORDANCE V 3. SINGLE PAGE OF PAGES OF THE CO 4. DRAWINGS ARE H 5. CONTRACTOR AI CONSTRUCTION DESIGNER PRIOR 6. MODIFICATIONS OR ANY OTHER R DESIGNER. 7. UNDER NO CIRCU
NE LINE DESIGN SERVICES GLENN & HEATHER MIDDLEBROOK	requirements set out in the 2012 QUALIFICAT Required unless exempt ER MIDDLEBROOK	akes responsibility for this design, and meets the 2 Ontario Building Code to be a designer. I ON INFORMATION under 3.2.5.1 Division C of the Building Code HMiddland 14607 SIGNATURE BCIN	<u>Notes</u>	
bclN: 14607 Utopia, On FIRM BCIN: NE (705) 424 8800 CELL (705) 796 8380 FIRM BCIN: MAIL: heather@finelinedrafting.ca DRAWN www.finelinedrafting.ca DRAWN BY: H.M.	NAME REGISTRATIC Required unless exempt <u>FINE LINE DESIGN SERVICES</u> FIRM NAME		PROJECT ADDRESS: 3867 Dixon R Innisfil	oad

<u>L NOTES CONTINUED</u>

MBER GRADE TO BE #1 - # 2 SPRUCE-PINE-FIR (S-P-F) UNLESS NOTED

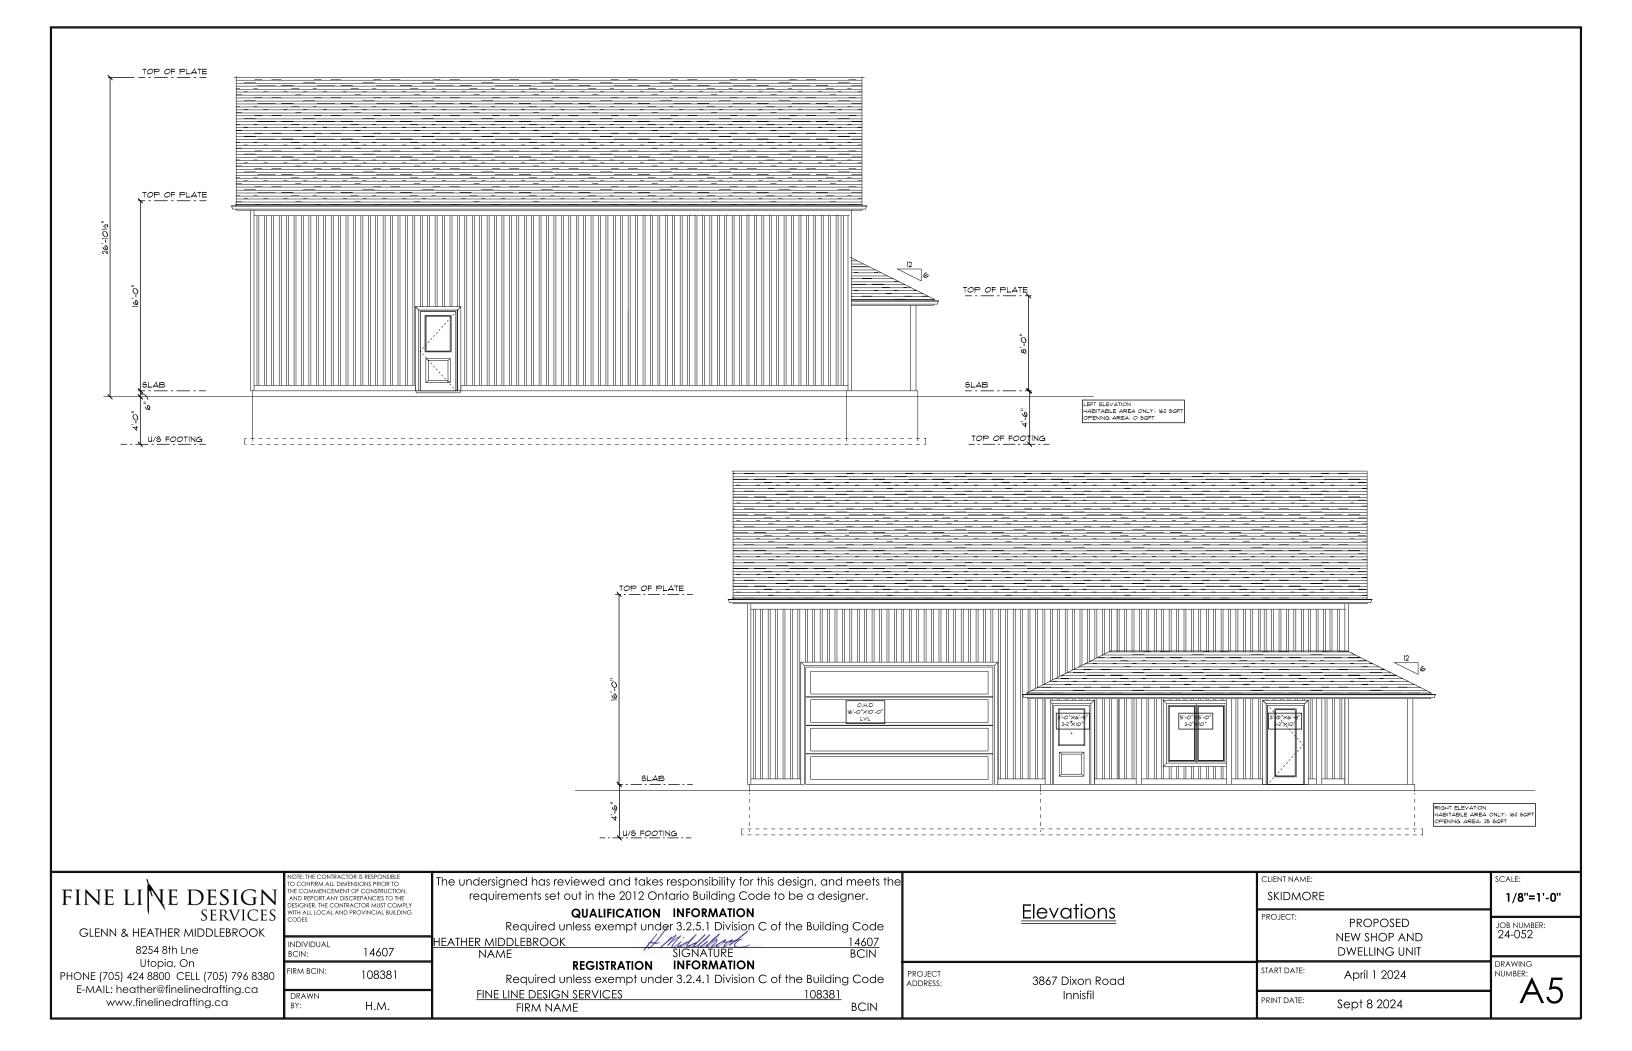TRENGTH - UNLESS NOTED OTHERWISE: ON WALL 20 MPa 20 MPa OR CRAWL SPACE FLOOR SLAB 25 MPa SLAB AND EXTERIOR STAIRS AND PORCHES 32 MPa WITH 5 % - 8 % AIR G HORIZONTAL RUN 1'11 5/8" I VERTICAL RISE 1'11 5/8"

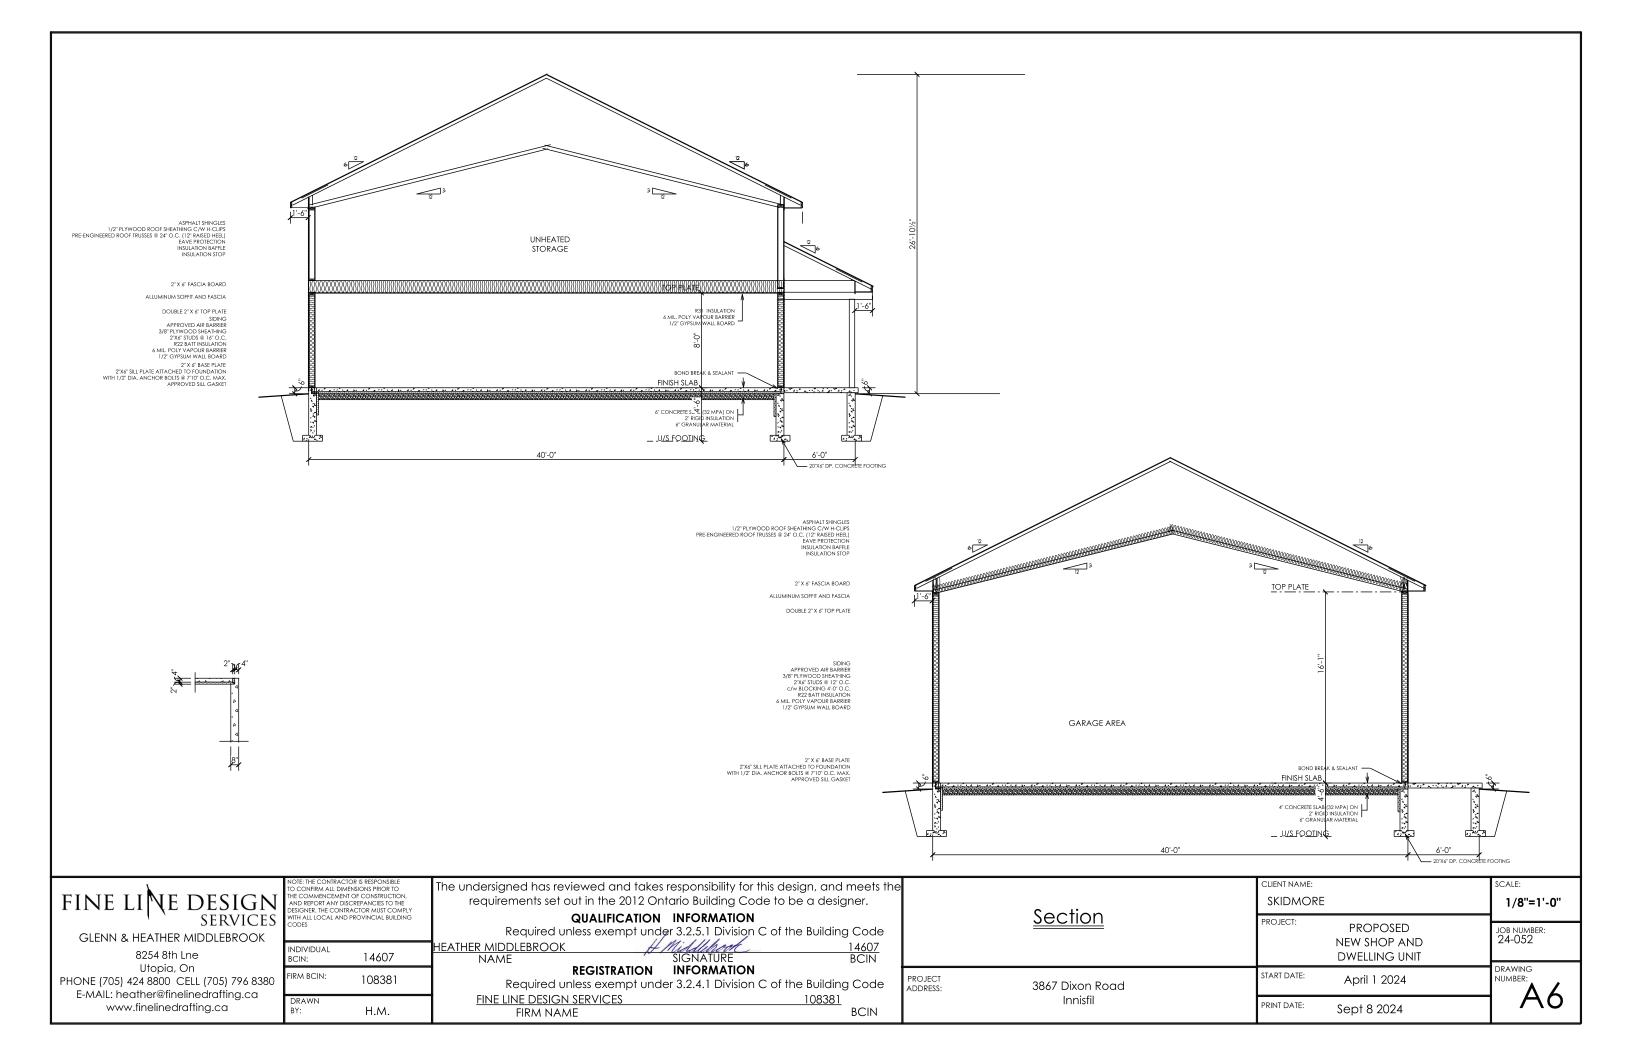6'5" HEADROOM MINIMUM 1 RISER HEIGHT 7 7/8" RISER HEIGHT 4 7/8" RUN DEPTH 11 1/4" 1 RUN DEPTH 14" TREAD DEPTH 14" 1 TREAD DEPTH 14" RUN TO BE UNIFORM THROUGHOUT THE FLIGHT

GUARDS WHERE THE ELEVATION DIFFERENCE IS 1'11 5/8" GUARDS ON INTERIOR STAIRS GREATER THAN 2 RISERS ON E NOT PROTECTED BY A WALL. EIGHT WITHIN THE DWELLING MINIMUM 2'11" EIGHT NOT WITHIN THE DWELLING MUM 2'11" HIGH WHERE THE ELEVATION DIFFERENCE IS EN 1'11 5/8" AND 5'11" ABOVE THE ADJACENT SURFACE UM 42" HIGHT WHERE THE ELEVATION DIFFERENCE IS GREATER 5'11" ABOVE THE ADJACENT SURFACE. ACING IN GUARDS NOT TO EXCEED 4" BETWEEN PICKETS. D BE DESIGNED TO PREVENT CLIMBING WITH NO MEMBER LOCATED 5 1/2" AND 2'11" THAN WOULD ENABLE CLIMBING.

LS TO BE CONTINUOUS LS TO BE LOCATED ON BOTH SIDES OF STAIRS 42' OR WIDER L HEIGHTS TO BE BETWEEN 2'10" AND 3'2" MEASURED VERTICALLY E NOSING OF THE STAIR.

<u>R NOTES</u>

R OR OWNER TO OBTAIN DESIGNS FOR ENGINEERED COMPONENTS () (DESIGN BY OTHER) (DBO) SUMES NO RESPONSIBILITY FOR THE FAILURE OF THE CONTRACTOR,

SUMES NO RESPONSIBILITY FOR THE FAILURE OF THE CONTRACTOR, CTOR, OWNER OR THEIR AGENTS TO CARRY OUT THE WORK IN CE WITH THESE DRAWINGS

OF THESE DRAWINGS ARE NOT TO BE READ INDEPENDENTLY OF ALL E CONSTRUCTION DRAWING SET.

RE NOT TO BE SCALED

R AND / OR OWNER TO VERIFY ALL DIMENSIONS ON THE DN DRAWING SET. ANY DISCREPANCIES ARE TO BE REPORTED TO THE OR TO THE COMMENCEMENT OF CONSTRUCTION.

INS TO THE DRAWINGS OR CONSTRUCTION DUE TO SITE CONDITIONS FR REASON SHALL NOT BE MADE WITHOUT FIRST CONSULTING WITH THE

RCUMSTANCE SHALL THE WORK PROCEED IF THEIR IS ANY UNCERTANTY.

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