



#### COMMITTEE OF ADJUSTMENT NOTICE OF PUBLIC HEARING APPLICATION NO. A-2025-041, A-2025-042, A-2025-043, A-2025-044, A-2025-045 & A-2025-046

**TAKE NOTICE** that an application has been received by the Town of Innisfil from Nick Skerratt, Applicant on behalf of John Paul Decaria-Stopay, Owner, for a minor variance from Zoning By-law 080-13, pursuant to Section 45 of the *Planning Act*, R.S.O. 1990, c. P.13, as amended.

The subject properties are described legally as INNISFIL CON 8 S PT LOT 24 and PLAN 1052 PT LOT 10 known municipally as 946-950 Innisfil Beach Rd and is zoned "Mixed Use (MU)".

Table 5.2b.C of the Zoning By-law, which requires a 7.5m interior side yard setback and compliance with the 45 degree angular plane where abutting an R1 Zone. A 3m eastern interior side yard setback is proposed for the parking structure, with a portion extending to 49 degrees.

Table 5.2b.E of the Zoning By-law, which requires a 7.5m rear yard setback and compliance with the 45 degree angular plane. A 3.7m rear yard setback is proposed for the parking structure and a portion at 48.8 degrees, and a 25.18m rear yard setback is proposed for the mixed-use building and 45.8 degrees is proposed for the parapet.

Table 5.2b.F of the Zoning By-law, which limits building height to 24m and subject to the 45-degree angular plane. A height of 25.4m is proposed, with the parapet at 45.8 degrees.

Table 5.2b, Note 3 of the Zoning By-law, requires the minimum width of the landscaped strip in the front yard to correspond with the setback provided of 1.9m. The applicant is proposing a landscaped strip of 0.2m.

Table 5.2b, Note 6 of the Zoning By-law, requires a minimum of 116m<sup>2</sup> of indoor amenity space and proposed is 0m<sup>2</sup>.

Section 3.35.1.1.d of the Zoning By-law, requires a minimum of 87 parking spaces for residential use, proposed is 85 parking spaces.

The Committee of Adjustment for the Town of Innisfil will consider this application in person at Town Hall and virtually through Zoom on **Thursday**. **September 18. 2025.** at **6:30 PM**.




To participate in the hearing and/or provide comments, you must register by following the link below or scanning the above QR code:

https://innisfil.ca/en/building-anddevelopment/committee-of-adjustmenthearings.aspx

Requests can also be submitted in writing to: Town of Innisfil Committee of Adjustment, 2101 Innisfil Beach Road, Innisfil, Ontario, L9S 1A1 or by email to planning@innisfil.ca.

If you wish to receive a copy of the decision of the Committee of Adjustment in respect of the proposed consent, you must make a written request to the Secretary-Treasurer of the Committee of Adjustment by way of email or regular mail. The Notice of Decision will also explain the process for appealing a decision to the Ontario Land Tribunal (OLT).

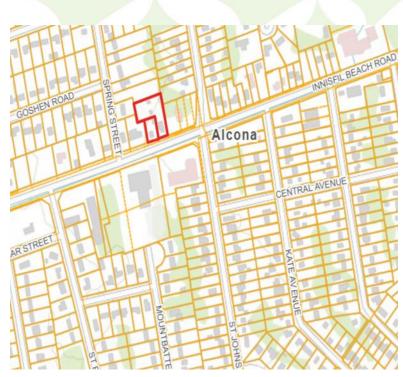

Additional information relating to the proposed application is available on the Town of Innisfil website. Accessible formats are available on request, to support participation in all aspects of the feedback process. To request an alternate format please contact Planning Services at <a href="mailto:planning@innisfil.ca">planning@innisfil.ca</a>.

Dated: August 28, 2025

Sarah Burton Hopkins Secretary Treasurer <u>sburtonhopkins@innisfil.ca</u> 705-436-3710 ext. 3504

# 8 STOREY CONDOMINIUM

946 & 950 INNISFIL BEACH ROAD, INNISFIL, ON

## ARCHITECT

#### MCKNIGHT CHARRON ARCHITECTS LTD.

48 ALLIANCE BOULEVARD, UNIT 110 BARRIE, ONTARIO, L4M 5K3

TELEPHONE: (705) 722-6739

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ARCHITECTURAL SHEET LIST

A1.1 SITE PLAN
A1.2 SITE PLAN SECTIONS
A1.3 SITE PLAN DETAILS
A3.1 GROUND FLOOR PLAN
A3.2 GARAGE LEVELS
A3.3 SECOND FLOOR PLAN
A3.4 THIRD FLOOR PLAN
A3.5 FOURTH AND SIXTH FLOOR PLANS
A3.6 FIFTH AND SEVENTH FLOOR PLANS
A3.7 EIGHTH FLOOR PLAN
A3.8 PENTHOUSE PLAN
A3.9 ROOF PLAN
A3.9 ROOF PLAN
A5.1 UNIT PLANS
A5.2 UNIT PLANS
A5.3 UNIT PLANS
A5.4 UNIT PLANS
A5.5 UNIT PLANS

UNIT PLANS UNIT PLANS





LOCATION KEYMAP

# ISSUED FOR SPA

(ALL DRAWINGS, SPECIFICATIONS, AND ADDENDA FOR ALL DISCIPLINES TO BE READ AS A COMPLETE PACKAGE)



	NAME OF PRACTICE:									
	McKnight Charron Limit	ed Architect	s							
	48 Alliance Blvd. Unit 1	10, Barrie, C	Ontario							
	Tel: (705) 722-6739									
	NAME OF PROJECT:									
	INNISFIL BEACH ROA	D								
	PROJECT LOCATION:	;								
	946 & 950 INNISFIL BE	ACH ROAD	)							
	INNISFIL, ON.									
									OBC	REFERENCE
ITEM				S 2024 BU			E			E TO DIVISION B UNLESS NOTED
		DA	TA M	ATRIX PAF	RTS 3 A	AND 9				ON A OR [C] FOR DIVISION C.
1	PROJECT DESCRIPTION	ON.		•	■ NEW		CHANG	E □ PAR	T 11	□ PART 9
	11100201 2200111 11	011.			= .t≥tt ⊐ ADDITI		OF USE			2 17441 0
					ALTER			1.0.05.	1.0.0.2.[74]	
2	MAJOR OCCUPANCY(	S). Group	C Grou				& Second	l Floor	3.1.2.	
-	1000017114011	o). Gloup	o, orou	p B on Ground	1 1001, 1 0	Orouna c	a occorio	111001	0.1.2.	
3	BUILDING AREA (m²):			EXISTING:		NEW:	1057		964 1.4.1.2.[A]	
						•	EN AIR PAI			
4	GROSS FLOOR AREA	` ,		EXISTING:		NEW:	6766	TOTAL: 6	766 1.4.1.2.[A]	
5	NUMBER OF STOREY				E: <b>8</b>	BELOW	GRADE:		1.4.1.2.[A]&	3.2.1.1.
6	NUMBER OF STREETS	S / FIRE FIG	HTER A						3.2.2.10. & 3	3.2.5.
7	BUILDING CLASSIFICA							F, DIVISION 3		
8	SPRINKLER SYSTEM	PROPOSED	):		ENTIRE	E BUILDIN	NG		C: 3.2.2.42.	
					SELEC	TED CON	MPARTME	ENTS	D: 3.2.2.56.	
						TED FLO		AS	F3: 3.2.2.92	
					BASEM	MENT ONL	LY		INDEX	
					IN LIEU	J OF ROC	OF RATIN	G	INDEX	
					□ NOT RI	EQUIRED	)			
9	STANDPIPE SYSTEM	REQUIRED:	-		■ YES		□ NO	)	3.2.5.8-11.	
10	FIRE ALARM REQUIRE	ED:			■ YES		□ NO	)	3.2.4.	
11	WATER SERVICE/SUF	PPLY IS ADE	EQUATE	: •	■ YES		□ NO	)	3.2.5.7.	
12	HIGH BUILDING:				■ YES		□ NO	)	3.2.6.	
13	PERMITTED CONSTR	UCTION:	□ CON	MBUSTIBLE <b>•</b>	NON-C	OMBUST	IBLE	□ BOTH		
	ACTUAL CONSTRUCT	ION:	□ CON	MBUSTIBLE <b>■</b>	■ NON-C	OMBUST	IBLE	□ BOTH		
14	MEZZANINE(S) AREA	(sq.m.):	EXI	ISTING:	NE	W:	-	TOTAL: <b>N/A</b>	3.2.1.1.	
	MEZZANINE 10% OR L	ESS ENCL	OSED (A	REA, m²):	<= 40°	% UNENC	CLOSED (	(AREA, m²):		
15	OCCUPANT LOAD BAS	SED ON:	□ sq.n	n./PERSON <b>■</b>	DESIGI	N OF BUI	ILDING		3.1.17.	
	1ST FLOOR:		OCCU	JPANCY: D	LOAD:	4.6 M2 / F	PERSON	PERSONS: 47		
	2ND FLOOR:			JPANCY: C	I OAD	2 UNITS		PERSONS: 8		
		I) EL OOD.					. / EL OOD	PERSONS: 16	_	
	TYPICAL (3RD TO 7TH	I) FLOOR:		JPANCY: C			7 FLOOR			
	8TH FLOOR:		OCCU	JPANCY: C	LOAD:	6 UNITS		PERSONS: 32		
16	BARRIER-FREE DESIG	3N·	■ YES	<u> </u>	□ NO (E)	XPLAIN):			3.8.	
17	HAZARDOUS SUBSTA		□ YES		■ NO				3.3.1.2. & 3.	3.1.19.
18	REQUIRED			NTAL ASSEMBI			LISTED	DESIGN No.	0.0.1.2. 0.0.	
	FIRE	'		NTAL ASSEMBI RR (HOURS)	LIES	OF		RIPTION (SG-2)	& 3.2.1.2.,	
	RESISTANCE	FI	LOORS		URS			-CORE AND	3.2.2.15.,	
	RATING (FRR)							ACE CONCRETE	1	
	()		ROOF	N/A HO	URS					
		MF77	ZANINE		URS					
			SI	FRR OF UPPORTING				DESIGN No.		
				MEMBERS		OF	K DESCR	RIPTION (SG-2)		
		FI	LOORS	<b>2</b> HO	URS	1	HOLLOW	-CORE AND		
								ACE CONCRETE	:	
			ROOF	N/A HO	URS					
		MEZZ	ZANINE		URS					
	SPATIAL SEPARATION					•			3.2.3.	
19 l		AREA	L.D.	PERMITTED	PROPO	<sub>SED</sub> T	FRR	LISTED	COMB.	СОМВ.
19	14/411	OF EBF	(m.)	MAX % OF	PROPO		FRR HOURS)	DESIGN OR	COMB. CONSTR.	COMB. CLADDING
19	WALL	(m²)	()	OPENINGS	OPENIN	,		DESCRIPTION	ALLOWED	ALLOWED
19	WALL	(111)		ī.	1	,	45min	-	Comb. / Non-cor	nb. Comb. / Non-comb.
19	NORTH	713	25	100%	2.7%	0 1 4	40111111			
19		` ,	25 16.9	100% 100%	1		45min	-	Comb. / Non-cor	
19	NORTH	713		100%	33.4° 17.5°	% 4				nb. Comb. / Non-comb.
19	NORTH SOUTH	713 713	16.9		33.49	% 4 %	45min	-	Comb. / Non-cor	nb. Comb. / Non-comb. nb. Non-comb.

PROVISION	MU2 REQUIRED	PROPOSED
MIN. LOT AREA	1000 M <sup>2</sup>	3.896 M <sup>2</sup>
MIN. LOT FRONTAGE	15M	44.46M
MIN. BUILDING FRONTAGE	FRONTAGE <30, MIN 60% FRONTAGE >30, MIN 50%	26.2M
MIN. FRONT YARD MAX. FRONT YARD	1M 4M	1.93M
MIN. INTERIOR SIDE YARD	0 OR 7.5M WITH 45 ANGULAR PLANE	8.54M WEST & 2.39M EAS BUILDING - DEFICIENCY
MIN. EXTERIOR SIDE YARD	6M	N/A
MIN. REAR YARD	7.5M WITH 45 ANGULAR PLANE	25.18M TO BUILDING 3.74M TO PARKING - DEF
MAX. LOT COVERAGE	N/A	27%
MIN. BUILDING HEIGHT	7.5 W/ ANGULAR PLANE	25.4M DEFICIENCY
MAX. BUILDING HEIGHT	30M FOR COMMERCIAL 24M FOR MIXED USE	
MIN. LANDSCAPED OPEN SPACE	N/A	31%
MIN. WIDTH OF LANDSCAPED STRIP AT FRONT AND EXTERIOR SIDE LOT LINES	1-4M	0.2M DEFICIENCY
MIN. WIDTH OF LANDSCAPED STRIP AT REAR LOT LINE	3M	3M
MIN. WIDTH OF LANDSCAPING ADJACENT TO THE INTERIOR LOT LINES	ОМ	WEST - MIN. 1.6M EAST - MIN. 2.1M
MIN. AMENITY SPACE	4M <sup>2</sup> PER RESIDENTIAL UNI	T 310 M <sup>2</sup> (OUTDOOR) + 424I
OUTDOOR	116M <sup>2</sup>	(BALCONIES)
INDOOR	116M <sup>2</sup>	0M <sup>2</sup> - DEFICIENCY
MAX. DENSITY	N/A	158 UPH
MAX GARAGE WIDTH	N/A	N/A
MIN. FLOOR AREA FOR A RESIDENTIAL DWELLING UNIT	47M <sup>2</sup>	56M <sup>2</sup>
MIN. PARKING COMMERCIAL (C)	1 PER 40 M <sup>2</sup> COMMERCIAL 5 SPACES	1 PER 40 M <sup>2</sup> 5 SPACES
RESIDENTIAL	1.5 PER RESIDENTIAL UNIT 87 SPACES	1.46 PER RESIDENTIAL 85 SPACES - DEFICIENCY
VISITOR (V)	25% OF THE RESIDENTIAL PARKING 21 SPACES	15 SPACES (17.6%)
ACCESSIBLE	0-100 SPACES = 4% OF THI RESIDENTIAL PARKING 4 SPACES	2 TYPE A + 2 TYPE B = 4 ACCESSIBLE SPACES

עאו	I U UK 7.3W WHIT 43						
	ANGULAR PLANE	BUILDING - DEFICIENCY	2ND FLOOR	2 UNITS			
ARD	6M	N/A	3RD - 7TH FLOOR	10 UNITS	/ FLOOR		
	7.5M WITH 45 ANGULAR PLANE	25.18M TO BUILDING 3.74M TO PARKING - DEFICIENCY	8TH FLOOR	6 UNITS			
	N/A	27%	UNIT TYPES			DWELLING UNIT ARE	ΞA
	7.5 W/ ANGULAR PLANE	25.4M DEFICIENCY	1 BEDROOM	5 UNIT	S - 9%	AREA: 56m² / 598ft²	
Г	30M FOR COMMERCIAL 24M FOR MIXED USE		1 BEDROOM + DEN	10 UNI	TS - 17%	AREA: 56m² - 59m² / 60	8ft² - 640ft²
ΞN	N/A	31%	1 BEDROOM + DEN B.F.	. 5 UNIT	S - 9%	AREA: 63m² / 678ft²	
CAPED	1-4M	0.2M DEFICIENCY	2 BEDROOM	14 UNI	TS - 24%	AREA: 101m² - 104m² /	1,091ft² - 1,11
NES			2 BEDROOM + DEN	10 UNI	TS - 17%	AREA: 83m² - 88m² / 89	92ft² - 945ft²
CAPED NE	3M	3M	2 BEDROOM + DEN B.F.	. 10 UNI	ITS - 17% AREA: 95m² / 1,023ft²		
ENT TO	ОМ	WEST - MIN. 1.6M EAST - MIN. 2.1M	3 BEDROOM	3 UNIT	TS - 5% AREA: 142m² - 150m² /		/ 1,532ft² - 1,6
LO	4M <sup>2</sup> PER RESIDENTIAL UNIT		3 BEDROOM + DEN B.F.	. 1 UNIT	S - 2%	AREA: 158m² / 1,698ft²	
	116M <sup>2</sup>	310 M <sup>2</sup> (OUTDOOR) + 424M <sup>2</sup> (BALCONIES)					
	116M <sup>2</sup>	0M <sup>2</sup> - DEFICIENCY	BALCONIES				
	N/A	158 UPH	BALCONY AREA	LEVELS	UNIT TY	PE	COUN
	N/A	N/A	5.46m²	3-7	1 BEDRO	DOM (SUITE A)	5
A G	47M <sup>2</sup>	56M <sup>2</sup>	5.74m²	3-7	1 BED +	DEN (SUITE B)	10
	1 PER 40 M <sup>2</sup> COMMERCIAL	1 PER 40 M <sup>2</sup>			1 BED +	DEN B.F. (SUITE C)	5
	5 SPACES	5 SPACES			2 BED +	DEN (SUITE D)	5
	1.5 PER RESIDENTIAL UNIT 87 SPACES	1.46 PER RESIDENTIAL 85 SPACES - DEFICIENCY			2 BED +	DEN (SUITE E)	5
	25% OF THE RESIDENTIAL PARKING	15 SPACES (17.6%)			2 BED +	DEN B.F. (SUITE F)	10
	21 SPACES		9.57m²	2-3	2 BEDRO	OOM (SUITE G)	2
	0-100 SPACES = 4% OF THE RESIDENTIAL PARKING 4 SPACES	2 TYPE A + 2 TYPE B = 4 ACCESSIBLE SPACES	12.3m²	2-3	2 BEDRO	OOM (SUITE H)	2
	401 AOLO		6.93m <sup>2</sup>	4-8	2 BEDRO	DOM (SUITE I)	5
			7.78m²	4-8	2 BEDRO	DOM (SUITE J)	5
			17.54m²	8	3 BEDRO	DOM (SUITE K)	1
					3 BEDRO	DOM (SUITE L)	1
			25.29m²	8	3 BEDRO	DOM (SUITE M)	1
			18.71m²	8	3 BEDRO	DOM + DEN B.F. (SUITE N)	1
			BUIL	LDING AREA		1,057m² + 1,044m² OPEN	AIR PARKING
IIT ARF	AS						

COMMERCIAL UNITS

COMMERCIAL 1

COMMERCIAL 2

COMMERCIAL 3

RESIDENTIAL DWELLING UNITS

LEVEL

1ST FLOOR

1ST FLOOR

AREA (FLOOR AREA)

AREA: 60 M<sup>2</sup> / 646 FT<sup>2</sup>

AREA: 62 M<sup>2</sup> / 667 FT<sup>2</sup>

AREA: 73 M<sup>2</sup> / 786 FT<sup>2</sup>


58 UNITS

TOTAL AREA: 195 M<sup>2</sup> / 2099 FT<sup>2</sup>

BUILDING AREA   1,057m² + 1,044m² OPEN AI	Area (Sq. Ft.)
Name         Area (Sq. M.)         Area (Sq. Ft.)           2ND FLOOR         2 BEDROOM (SUITE G)         89 m²         955 ft²	
Name         Area (Sq. M.)         Area (Sq. Ft.)           2ND FLOOR         2 BEDROOM (SUITE G)         89 m²         955 ft²   UNIT AREAS	
2 BEDROOM (SUITE G) 89 m² 955 ft² UNIT AREAS	
2 BEDROOM (SUITE G) 89 m² 955 ft² UNIT AREAS	
2 BEDROOM (SUITE G) 89 IIF 935 IIF	
2 BEDROOM (SUITE H) 94 m² 1011 ft² UNIT AREAS Name Area (Sq. M.)	
3RD FLOOR   Name   Area (Sq. M.)   Area (Sq. Ft.)   2 BEDROOM + DEN B.F. (SUITE F)   87 m <sup>2</sup>	936 ft <sup>2</sup>
	829 ft²
1 BEDROOM + DEN (SUITE B1) 52 m <sup>2</sup> 560 ft <sup>2</sup> 2 BEDROOM (SUITE J) 87 m <sup>2</sup> 9	935 ft²
1 BEDROOM + DEN (SUITE BZ) 52 m² 561 ft² 5TH FLOOR	
1 BEDROOM + DEN B.F. (SUITE C) 57 m <sup>2</sup> 610 ft <sup>2</sup> 1 BEDROOM (SUITE A) 550 m <sup>2</sup> 539 ft <sup>2</sup> 7TH FLOOR	
2 BEDROOM + DEN (SUITE D) 77 m <sup>2</sup> 829 ft <sup>2</sup> 1 BEDROOM + DEN (SUITE B1) 52 m <sup>2</sup> 560 ft <sup>2</sup> 1 BEDROOM (SUITE A) 50 m <sup>2</sup>	539 ft²
2 BEDROOM + DEN (SUITE E) 80 m <sup>2</sup> 861 ft <sup>2</sup> 1 BEDROOM + DEN (SUITE B2) 52 m <sup>2</sup> 561 ft <sup>2</sup> 1 BEDROOM + DEN (SUITE B1) 52 m <sup>2</sup>	560 ft <sup>2</sup>
2 BEDROOM + DEN B.F. (SUITE F) 87 m <sup>2</sup> 936 ft <sup>2</sup> 1 BEDROOM + DEN B.F. (SUITE C) 57 m <sup>2</sup> 610 ft <sup>2</sup> 1 BEDROOM + DEN (SUITE B2) 52 m <sup>2</sup>	561 ft²
2 BEDROOM + DEN B.F. (SUITE F) 87 m <sup>2</sup> 936 ft <sup>2</sup> 2 BEDROOM + DEN (SUITE D) 77 m <sup>2</sup> 829 ft <sup>2</sup> 1 BEDROOM + DEN B.F. (SUITE C) 57 m <sup>2</sup>	610 ft <sup>2</sup>
2 BEDROOM (SUITE G) 89 m <sup>2</sup> 956 ft <sup>2</sup> 2 BEDROOM + DEN (SUITE E) 80 m <sup>2</sup> 861 ft <sup>2</sup> 2 BEDROOM + DEN (SUITE D) 77 m <sup>2</sup>	829 ft²
2 BEDROOM (SUITE H) 94 m <sup>2</sup> 1011 ft <sup>2</sup> 2 BEDROOM + DEN B.F. (SUITE F) 87 m <sup>2</sup> 936 ft <sup>2</sup> 2 BEDROOM + DEN (SUITE E) 80 m <sup>2</sup>	861 ft²
2 BEDROOM + DEN B.F. (SUITE F) 87 m <sup>2</sup> 936 ft <sup>2</sup> 2 BEDROOM + DEN B.F. (SUITE F) 87 m <sup>2</sup>	936 ft²
4TH FLOOR 2 BEDROOM (SUITE I) 77 m <sup>2</sup> 829 ft <sup>2</sup> 2 BEDROOM + DEN B.F. (SUITE F) 87 m <sup>2</sup>	936 ft²
1 BEDROOM (SUITE A) 50 m <sup>2</sup> 539 ft <sup>2</sup> 2 BEDROOM (SUITE J) 87 m <sup>2</sup> 935 ft <sup>2</sup> 2 BEDROOM (SUITE I) 77 m <sup>2</sup>	829 ft²
1 BEDROOM + DEN (SUITE B1) 52 m <sup>2</sup> 560 ft <sup>2</sup> 2 BEDROOM (SUITE J) 87 m <sup>2</sup>	935 ft²
1 BEDROOM + DEN (SUITE B2) 52 m <sup>2</sup> 561 ft <sup>2</sup> 6TH FLOOR	
1 BEDROOM + DEN B.F. (SUITE C) 57 m <sup>2</sup> 610 ft <sup>2</sup> 1 BEDROOM (SUITE A) 50 m <sup>2</sup> 539 ft <sup>2</sup> 8TH FLOOR	
2 BEDROOM + DEN (SUITE D) 77 m <sup>2</sup> 829 ft <sup>2</sup> 1 BEDROOM + DEN (SUITE B1) 52 m <sup>2</sup> 560 ft <sup>2</sup> 3 BEDROOM (SUITE K) 131 m <sup>2</sup>	1407 ft²
2 BEDROOM + DEN (SUITE E) 80 m² 861 ft² 1 BEDROOM + DEN (SUITE B2) 52 m² 561 ft² 3 BEDROOM (SUITE L) 134 m²	1438 ft²
2 BEDROOM + DEN B.F. (SUITE F) 87 m <sup>2</sup> 936 ft <sup>2</sup> 1 BEDROOM + DEN B.F. (SUITE C) 57 m <sup>2</sup> 610 ft <sup>2</sup> 3 BEDROOM (SUITE M) 139 m <sup>2</sup>	1495 ft²
2 BEDROOM + DEN B.F. (SUITE F) 87 m² 936 ft² 2 BEDROOM + DEN (SUITE D) 77 m² 829 ft² 3 BEDROOM + DEN B.F. (SUITE N) 146 m²	1577 ft²
2 BEDROOM (SUITE I) 77 m <sup>2</sup> 829 ft <sup>2</sup> 2 BEDROOM + DEN (SUITE E) 80 m <sup>2</sup> 861 ft <sup>2</sup> 2 BEDROOM (SUITE I) 77 m <sup>2</sup>	829 ft²
2 BEDROOM (SUITE J) 87 m <sup>2</sup> 935 ft <sup>2</sup> 2 BEDROOM + DEN B.F. (SUITE F) 87 m <sup>2</sup> 936 ft <sup>2</sup> 2 BEDROOM (SUITE J) 87 m <sup>2</sup> 9	935 ft²

COMMERCIAL (C)	3 SPACES		3 SPACES				2 BED + DE	EN (SUITE L	))	5
RESIDENTIAL	1.5 PER RES 87 SPACES	SIDENTIAL UNIT	1.46 PER RESIDENTIAL 85 SPACES - DEFICIENCY				2 BED + DE	EN (SUITE E	≣)	5
VISITOR (V)	25% OF THE PARKING	RESIDENTIAL	15 SPACES (17.6%)				2 BED + DE	EN B.F. (SU	ITE F)	10
	21 SPACES				9.57m²	2-3	2 BEDROO	M (SUITE C	G)	2
ACCESSIBLE	0-100 SPAC RESIDENTIA 4 SPACES	ES = 4% OF THE L PARKING	2 TYPE A + 2 TYPE B = 4 ACCESSIBLE SPACES		12.3m²	2-3	2 BEDROO	M (SUITE H	1)	2
	4 SPACES				6.93m <sup>2</sup>	4-8	2 BEDROC	M (SUITE I)	)	5
					7.78m²	4-8	2 BEDROO	M (SUITE J	)	5
					17.54m²	8	3 BEDROO	M (SUITE K	()	1
							3 BEDROO	M (SUITE L	)	1
					25.29m²	8	3 BEDROO	OM (SUITE N	1)	1
					18.71m²	8	3 BEDROC	M + DEN B	F. (SUITE N)	1
					BUIL	DING AREA		1,057m² + 1	1,044m² OPEN	AIR PARKI
UNIT AR	EAS				GFA			6,602m²		
Name	Area (Sq. M.)	Area (Sq. Ft.)						-,		
ID FLOOR										
BEDROOM (SUITE G)	89 m²	955 ft²					l	JNIT ARI	EAS	
BEDROOM (SUITE H)	94 m²	1011 ft²	UNIT AR	FAS			Name		Area (Sq. M.	) Area (Sq.
RD FLOOR			Name		M.) Area (Sq. Ft.)	2 BEDROOM	+DENRE (	SHITE E)	87 m²	936 ft²
BEDROOM (SUITE A)	50 m²	539 ft²	Ivanie	Alea (oq.	IVI.)   Alea (Sq. 1 t.)	2 BEDROOM		JUILI)	77 m²	829 ft²
BEDROOM + DEN (SUITE B1)	52 m²	560 ft²				2 BEDROOM			87 m²	935 ft²
BEDROOM + DEN (SUITE B2)	52 m²	561 ft²	5TH FLOOR			2 323.100	(00.120)		Jo	1000 11
BEDROOM + DEN B.F. (SUITE C)	57 m²	610 ft²	1 BEDROOM (SUITE A)	50 m²	539 ft²	7TH FLOOR				
BEDROOM + DEN (SUITE D)	77 m²	829 ft²	1 BEDROOM + DEN (SUITE B1)	52 m²	560 ft²	1 BEDROOM	(SUITE A)		50 m²	539 ft²
BEDROOM + DEN (SUITE E)	80 m²	861 ft²	1 BEDROOM + DEN (SUITE B2)	52 m²	561 ft²	1 BEDROOM		E B1)	52 m²	560 ft <sup>2</sup>
BEDROOM + DEN B.F. (SUITE F)	87 m²	936 ft²	1 BEDROOM + DEN B.F. (SUITE C)	57 m²	610 ft²	1 BEDROOM			52 m²	561 ft²
BEDROOM + DEN B.F. (SUITE F)	87 m²	936 ft²	2 BEDROOM + DEN (SUITE D)	77 m²	829 ft²		+ DEN B.F. (		57 m²	610 ft <sup>2</sup>
BEDROOM (SUITE G)	89 m²	956 ft²	2 BEDROOM + DEN (SUITE E)	80 m²	861 ft <sup>2</sup>	2 BEDROOM			77 m²	829 ft²
BEDROOM (SUITE H)	94 m²	1011 ft²	2 BEDROOM + DEN B.F. (SUITE F)	87 m²	936 ft²	2 BEDROOM			80 m²	861 ft²
, , ,	•		2 BEDROOM + DEN B.F. (SUITE F)	87 m²	936 ft²	2 BEDROOM	+ DEN B.F. (	SUITE F)	87 m²	936 ft²
H FLOOR			2 BEDROOM (SUITE I)	77 m²	829 ft²	2 BEDROOM	+ DEN B.F. (	SUITE F)	87 m²	936 ft²
BEDROOM (SUITE A)	50 m <sup>2</sup>	539 ft²	2 BEDROOM (SUITE J)	87 m²	935 ft²	2 BEDROOM			77 m²	829 ft²
BEDROOM + DEN (SUITE B1)	52 m²	560 ft <sup>2</sup>				2 BEDROOM	(SUITE J)		87 m²	935 ft <sup>2</sup>
BEDROOM + DEN (SUITE B2)	52 m²	561 ft²	6TH FLOOR							
BEDROOM + DEN B.F. (SUITE C)	57 m²	610 ft <sup>2</sup>	1 BEDROOM (SUITE A)	50 m <sup>2</sup>	539 ft²	8TH FLOOR				
BEDROOM + DEN (SUITE D)	77 m²	829 ft²	1 BEDROOM + DEN (SUITE B1)	52 m²	560 ft²	3 BEDROOM			131 m²	1407 ft²
BEDROOM + DEN (SUITE E)	80 m²	861 ft²	1 BEDROOM + DEN (SUITE B2)	52 m²	561 ft²	3 BEDROOM			134 m²	1438 ft²
BEDROOM + DEN B.F. (SUITE F)	87 m²	936 ft²	1 BEDROOM + DEN B.F. (SUITE C)	57 m²	610 ft²	3 BEDROOM	, ,		139 m²	1495 ft²
BEDROOM + DEN B.F. (SUITE F)	87 m²	936 ft²	2 BEDROOM + DEN (SUITE D)	77 m²	829 ft²	3 BEDROOM		SUITE N)	146 m²	1577 ft²
BEDROOM (SUITE I)	77 m²	829 ft²	2 BEDROOM + DEN (SUITE E)	80 m²	861 ft²	2 BEDROOM			77 m²	829 ft²
BEDROOM (SUITE J)	87 m²	935 ft²	2 BEDROOM + DEN B.F. (SUITE F)	87 m²	936 ft²	2 BEDROOM	(SUITE J)		87 m²	935 ft²




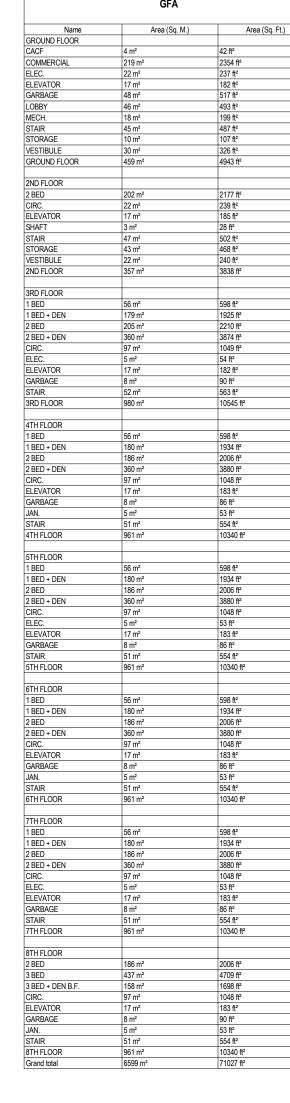

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4	SITE PLAN APPLICATION RESPONSE	2024 12 03
3	SITE PLAN APPLICATION RESPONSE	2024 05 27
2	SITE PLAN APPLICATION RESPONSE	2023 05 28
1	SITE PLAN APPLICATION RESPONSE	2022 11 24
		10

ISSUES/REVISIONS

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48 ALLIANCE BLVD., UNIT 110 BARRIE, ONTARIO L4M 5K3
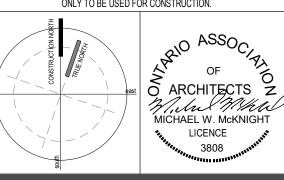
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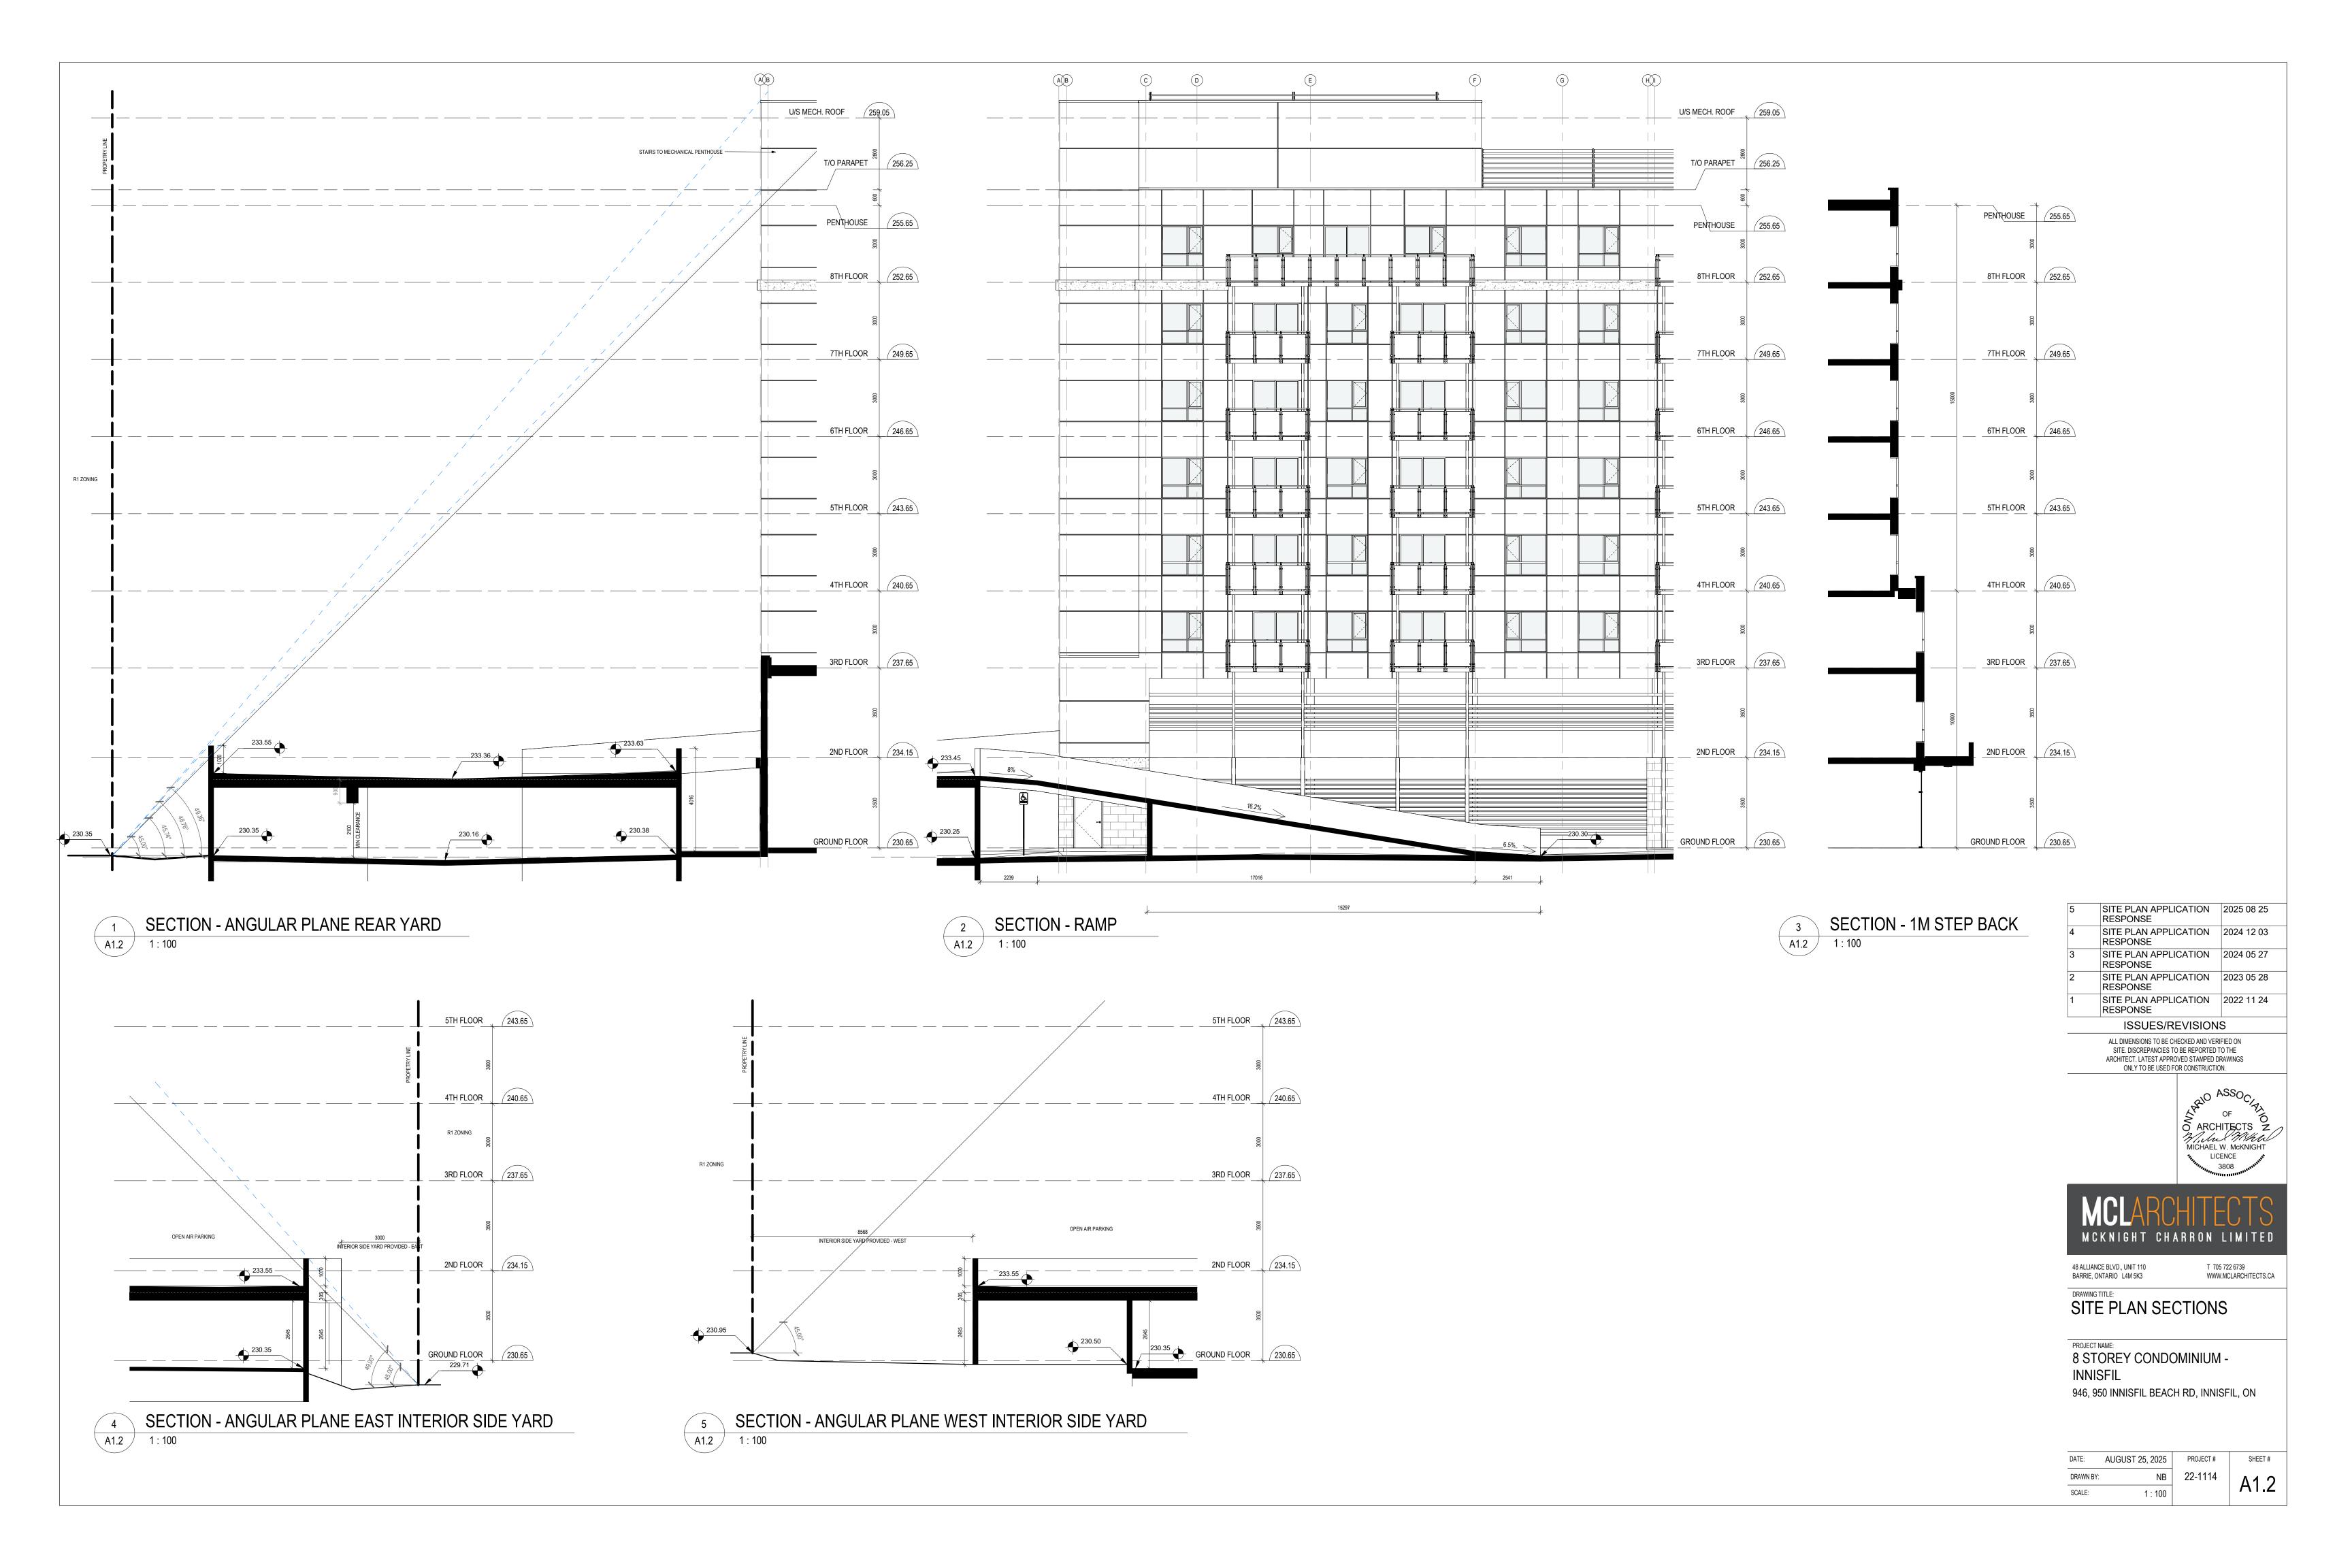
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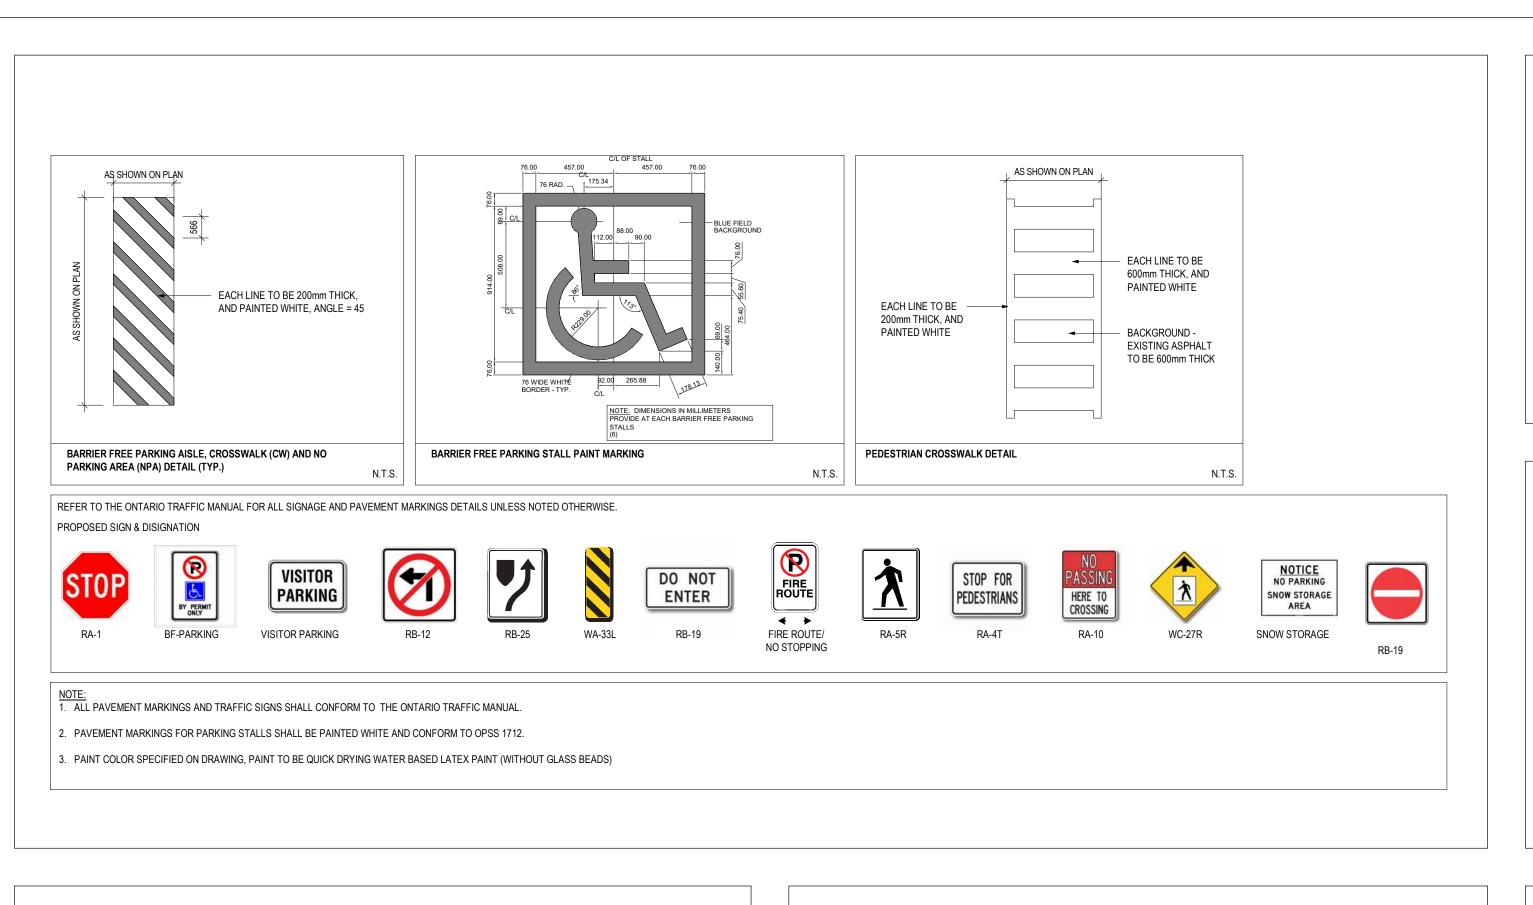
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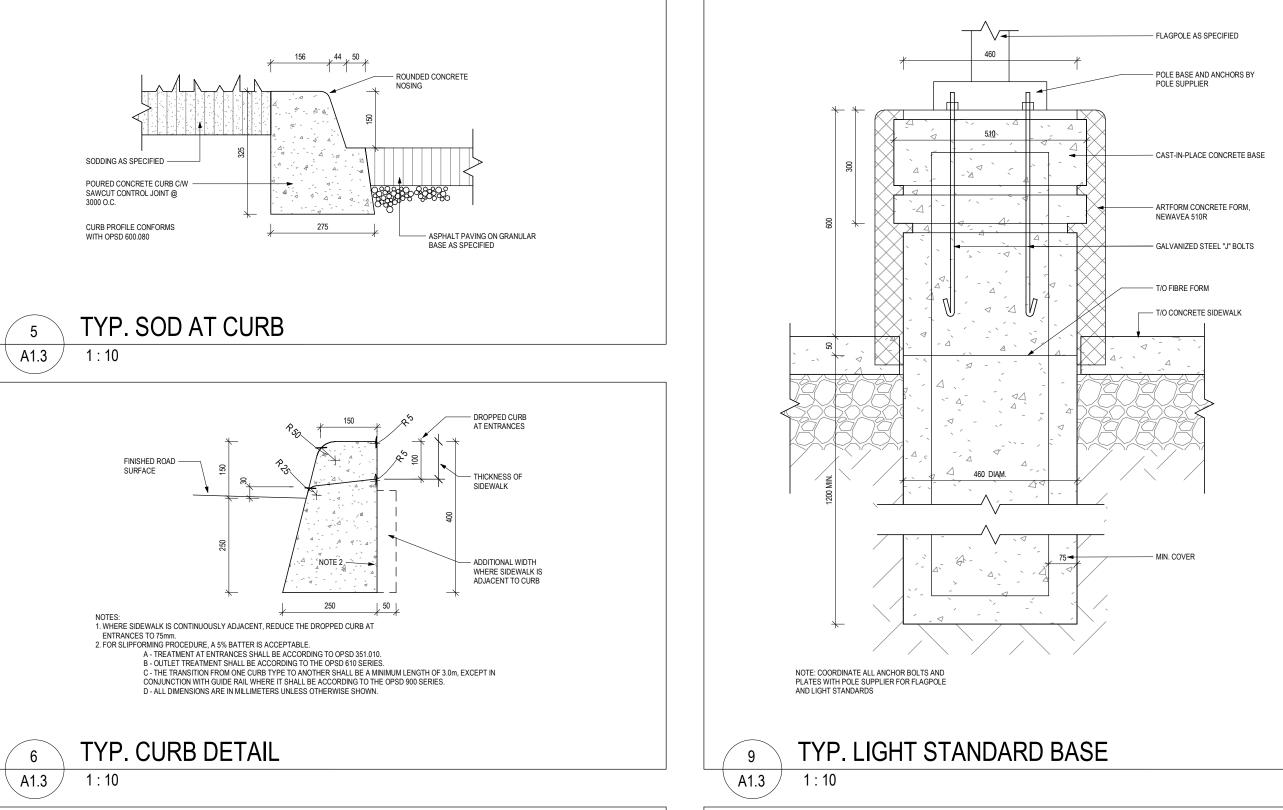
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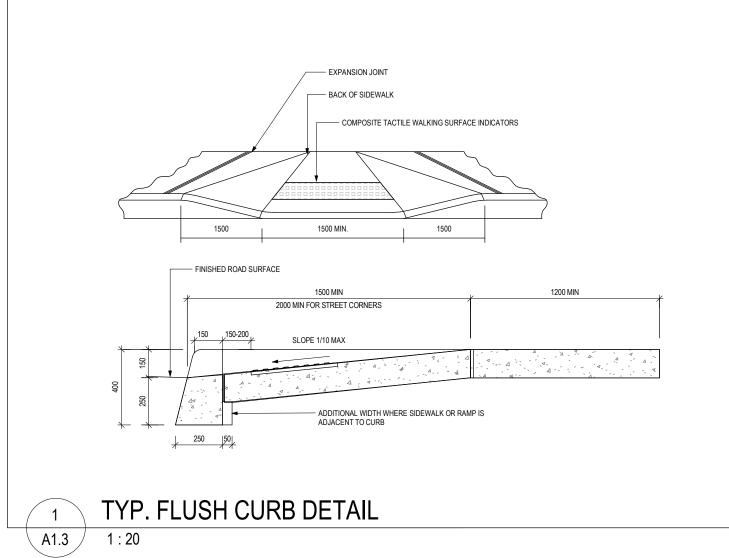
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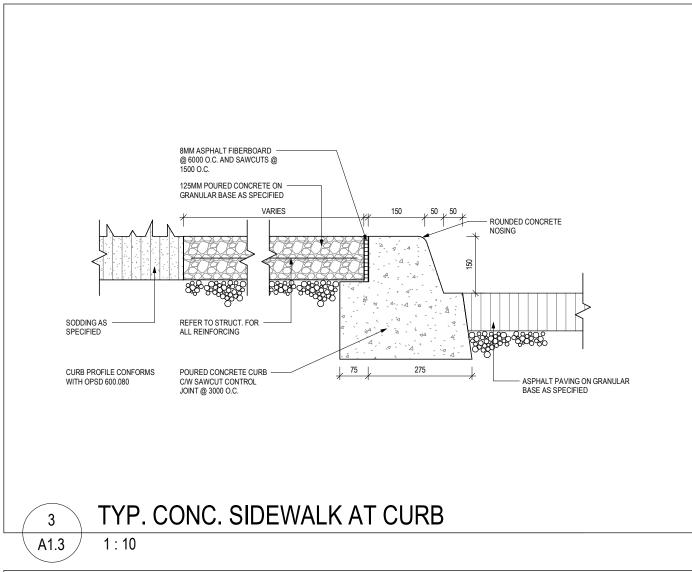
3.2.3.10.(1) UNLIMITED UNPROTECTED OPENING AN EXPOSING BUILDING FACE OF AN OPEN-AIR STOREY IN A STORAGE GARAGE IS PERMITTED TO HAVE UNLIMITED UNPROTECTED OPENINGSPROVIDED IT HAS A LIMITING DISTANCE NOT LESS THAN 3 M.
















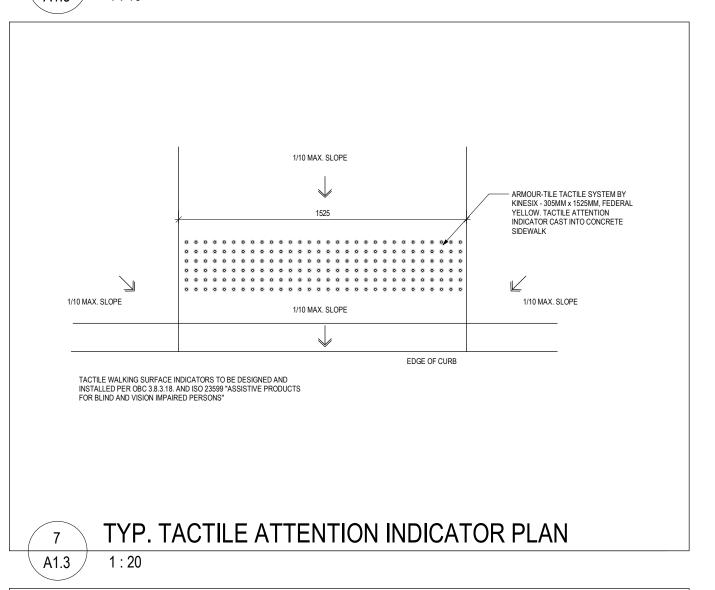


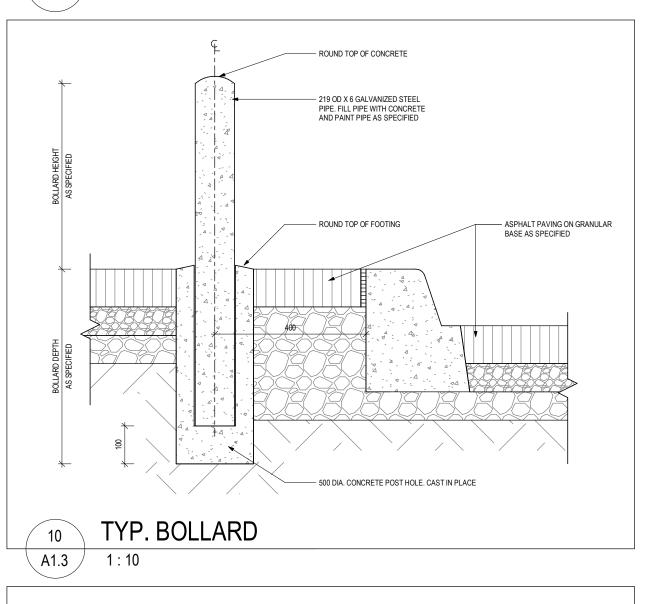


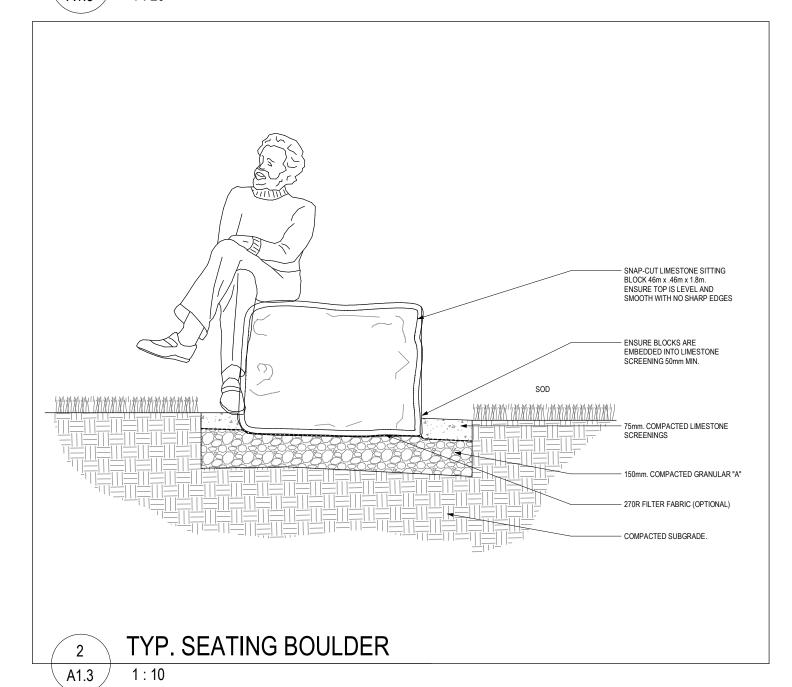

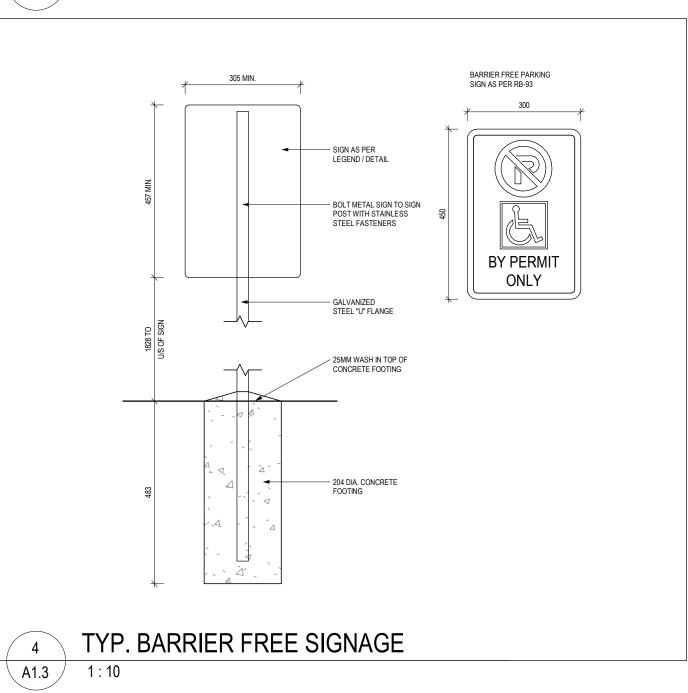

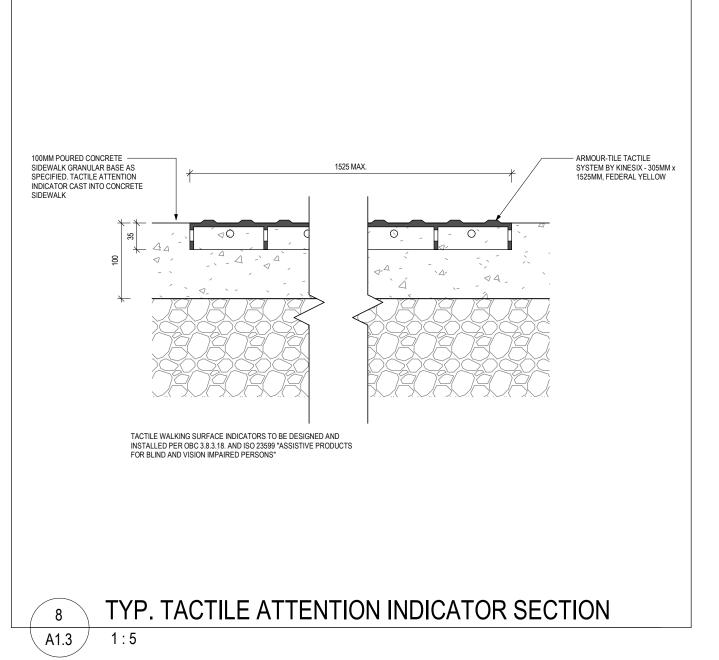

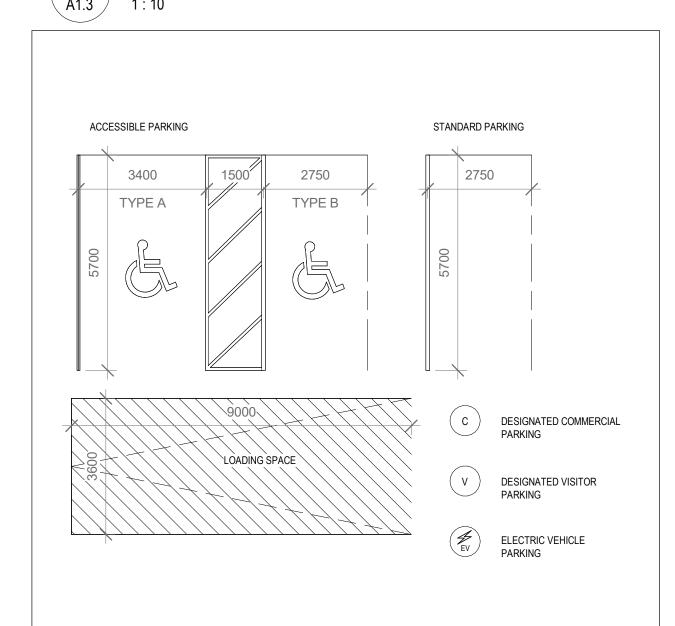

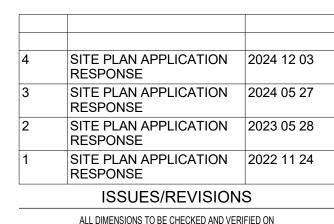

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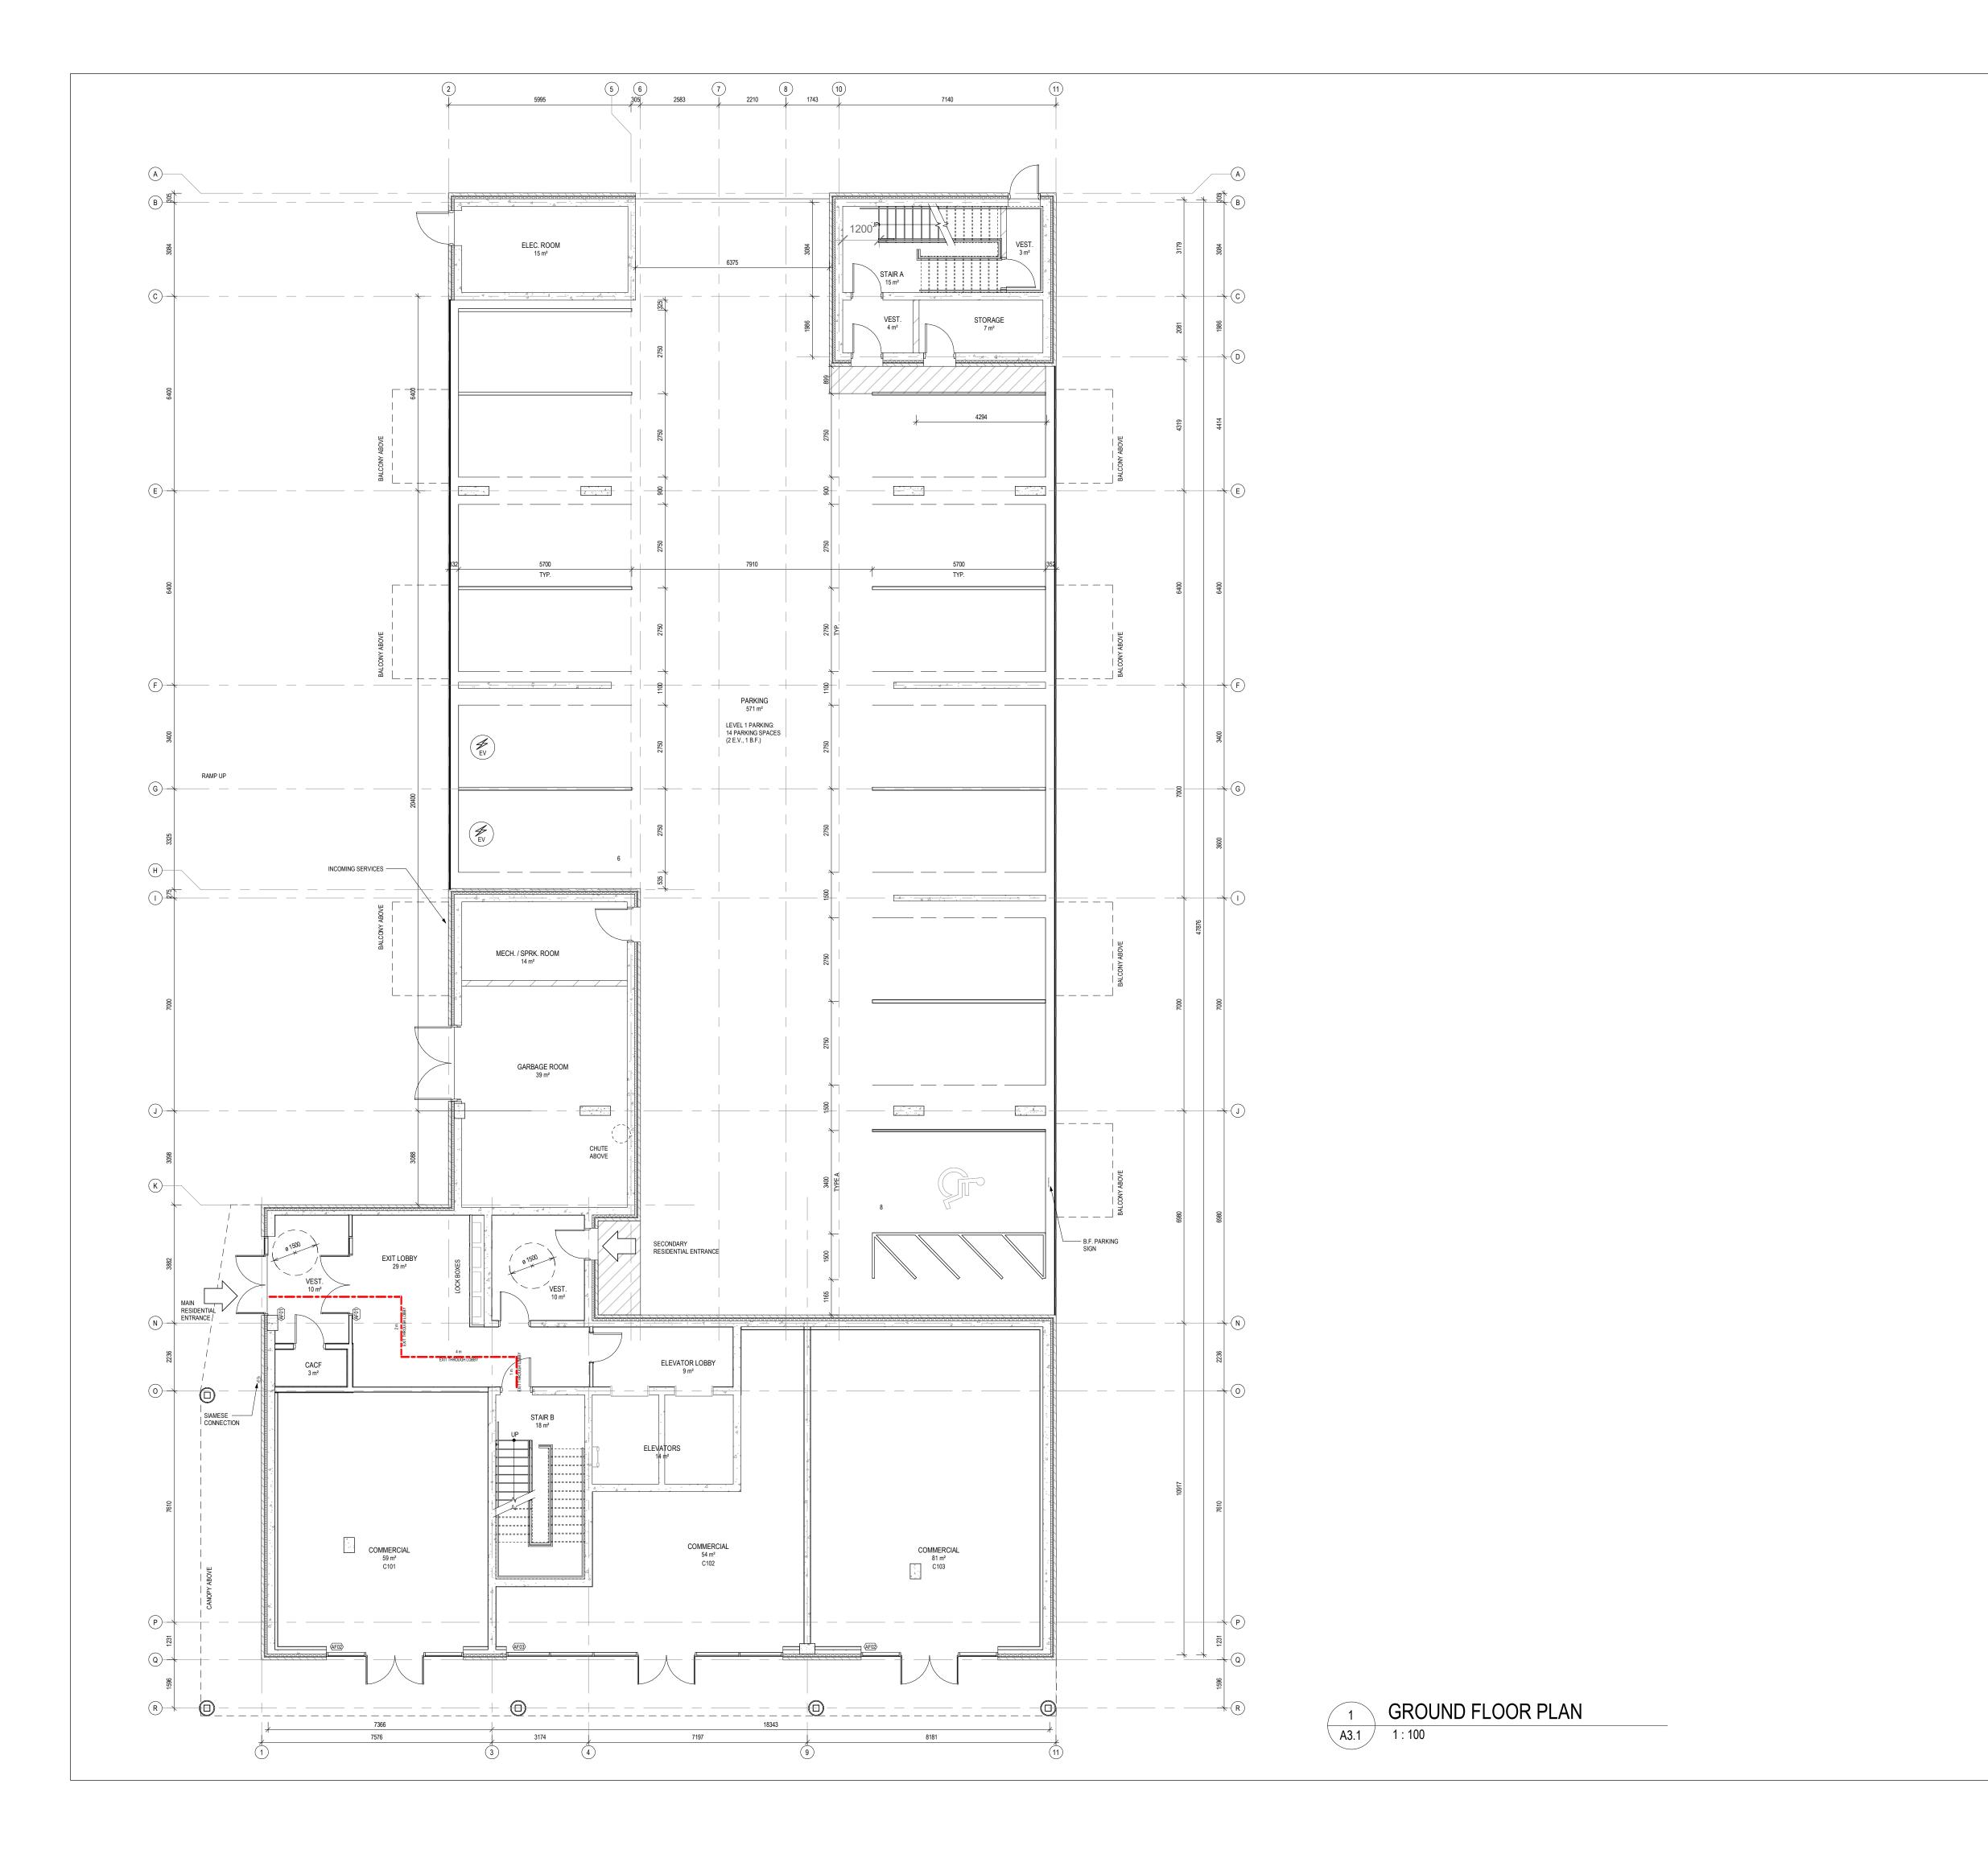
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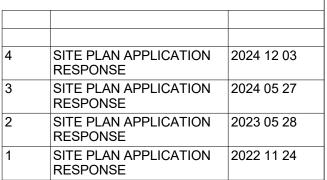
SITE PLAN DETAILS

PROJECT NAME: 8 STOREY CONDOMINIUM -INNISFIL 946, 950 INNISFIL BEACH RD, INNISFIL, ON

PROJ	December 03, 2024	DATE:
22-1	LR	DRAWN BY:
	As indicated	SCALE:


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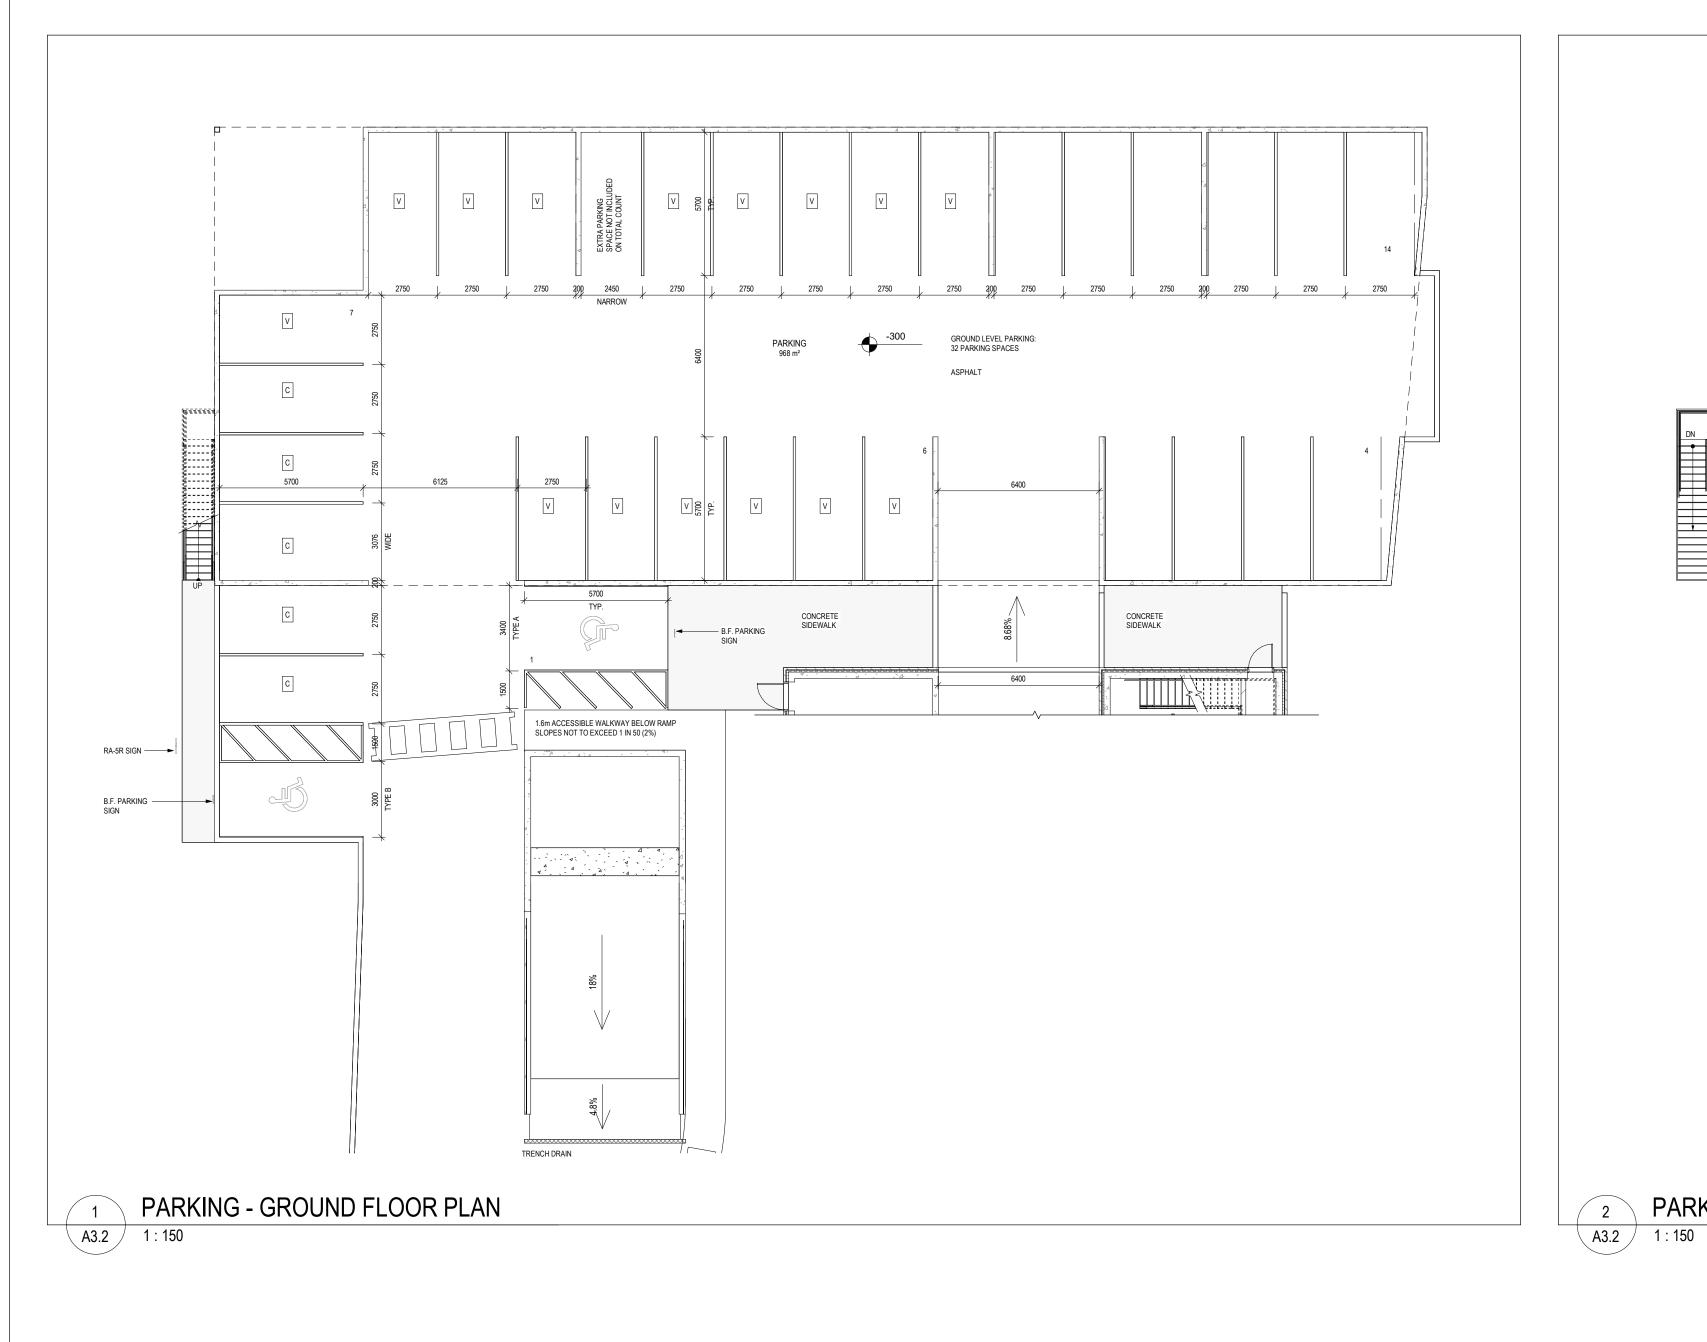
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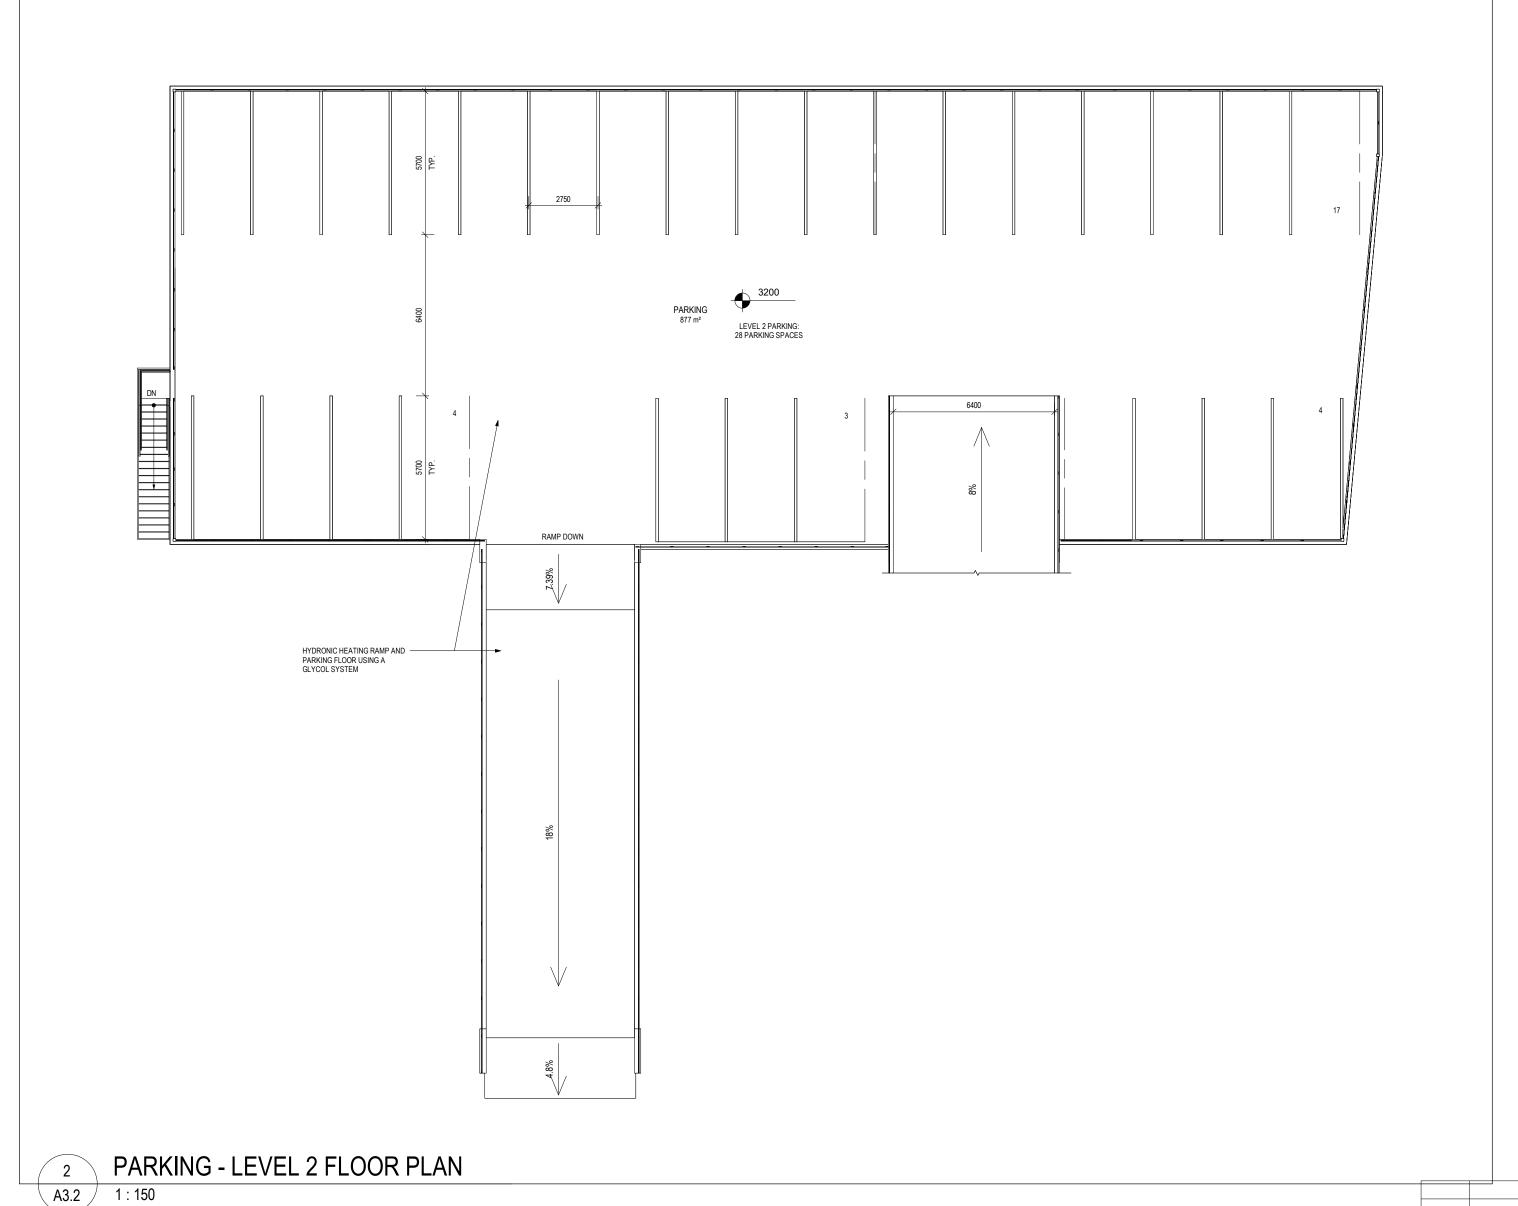
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8 STOREY CONDOMINIUM -INNISFIL 946, 950 INNISFIL BEACH RD, INNISFIL, ON

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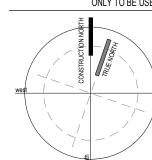
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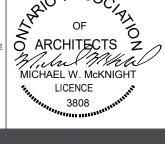




SITE PLAN APPLICATION 2024 12 03 RESPONSE ISSUES/REVISIONS

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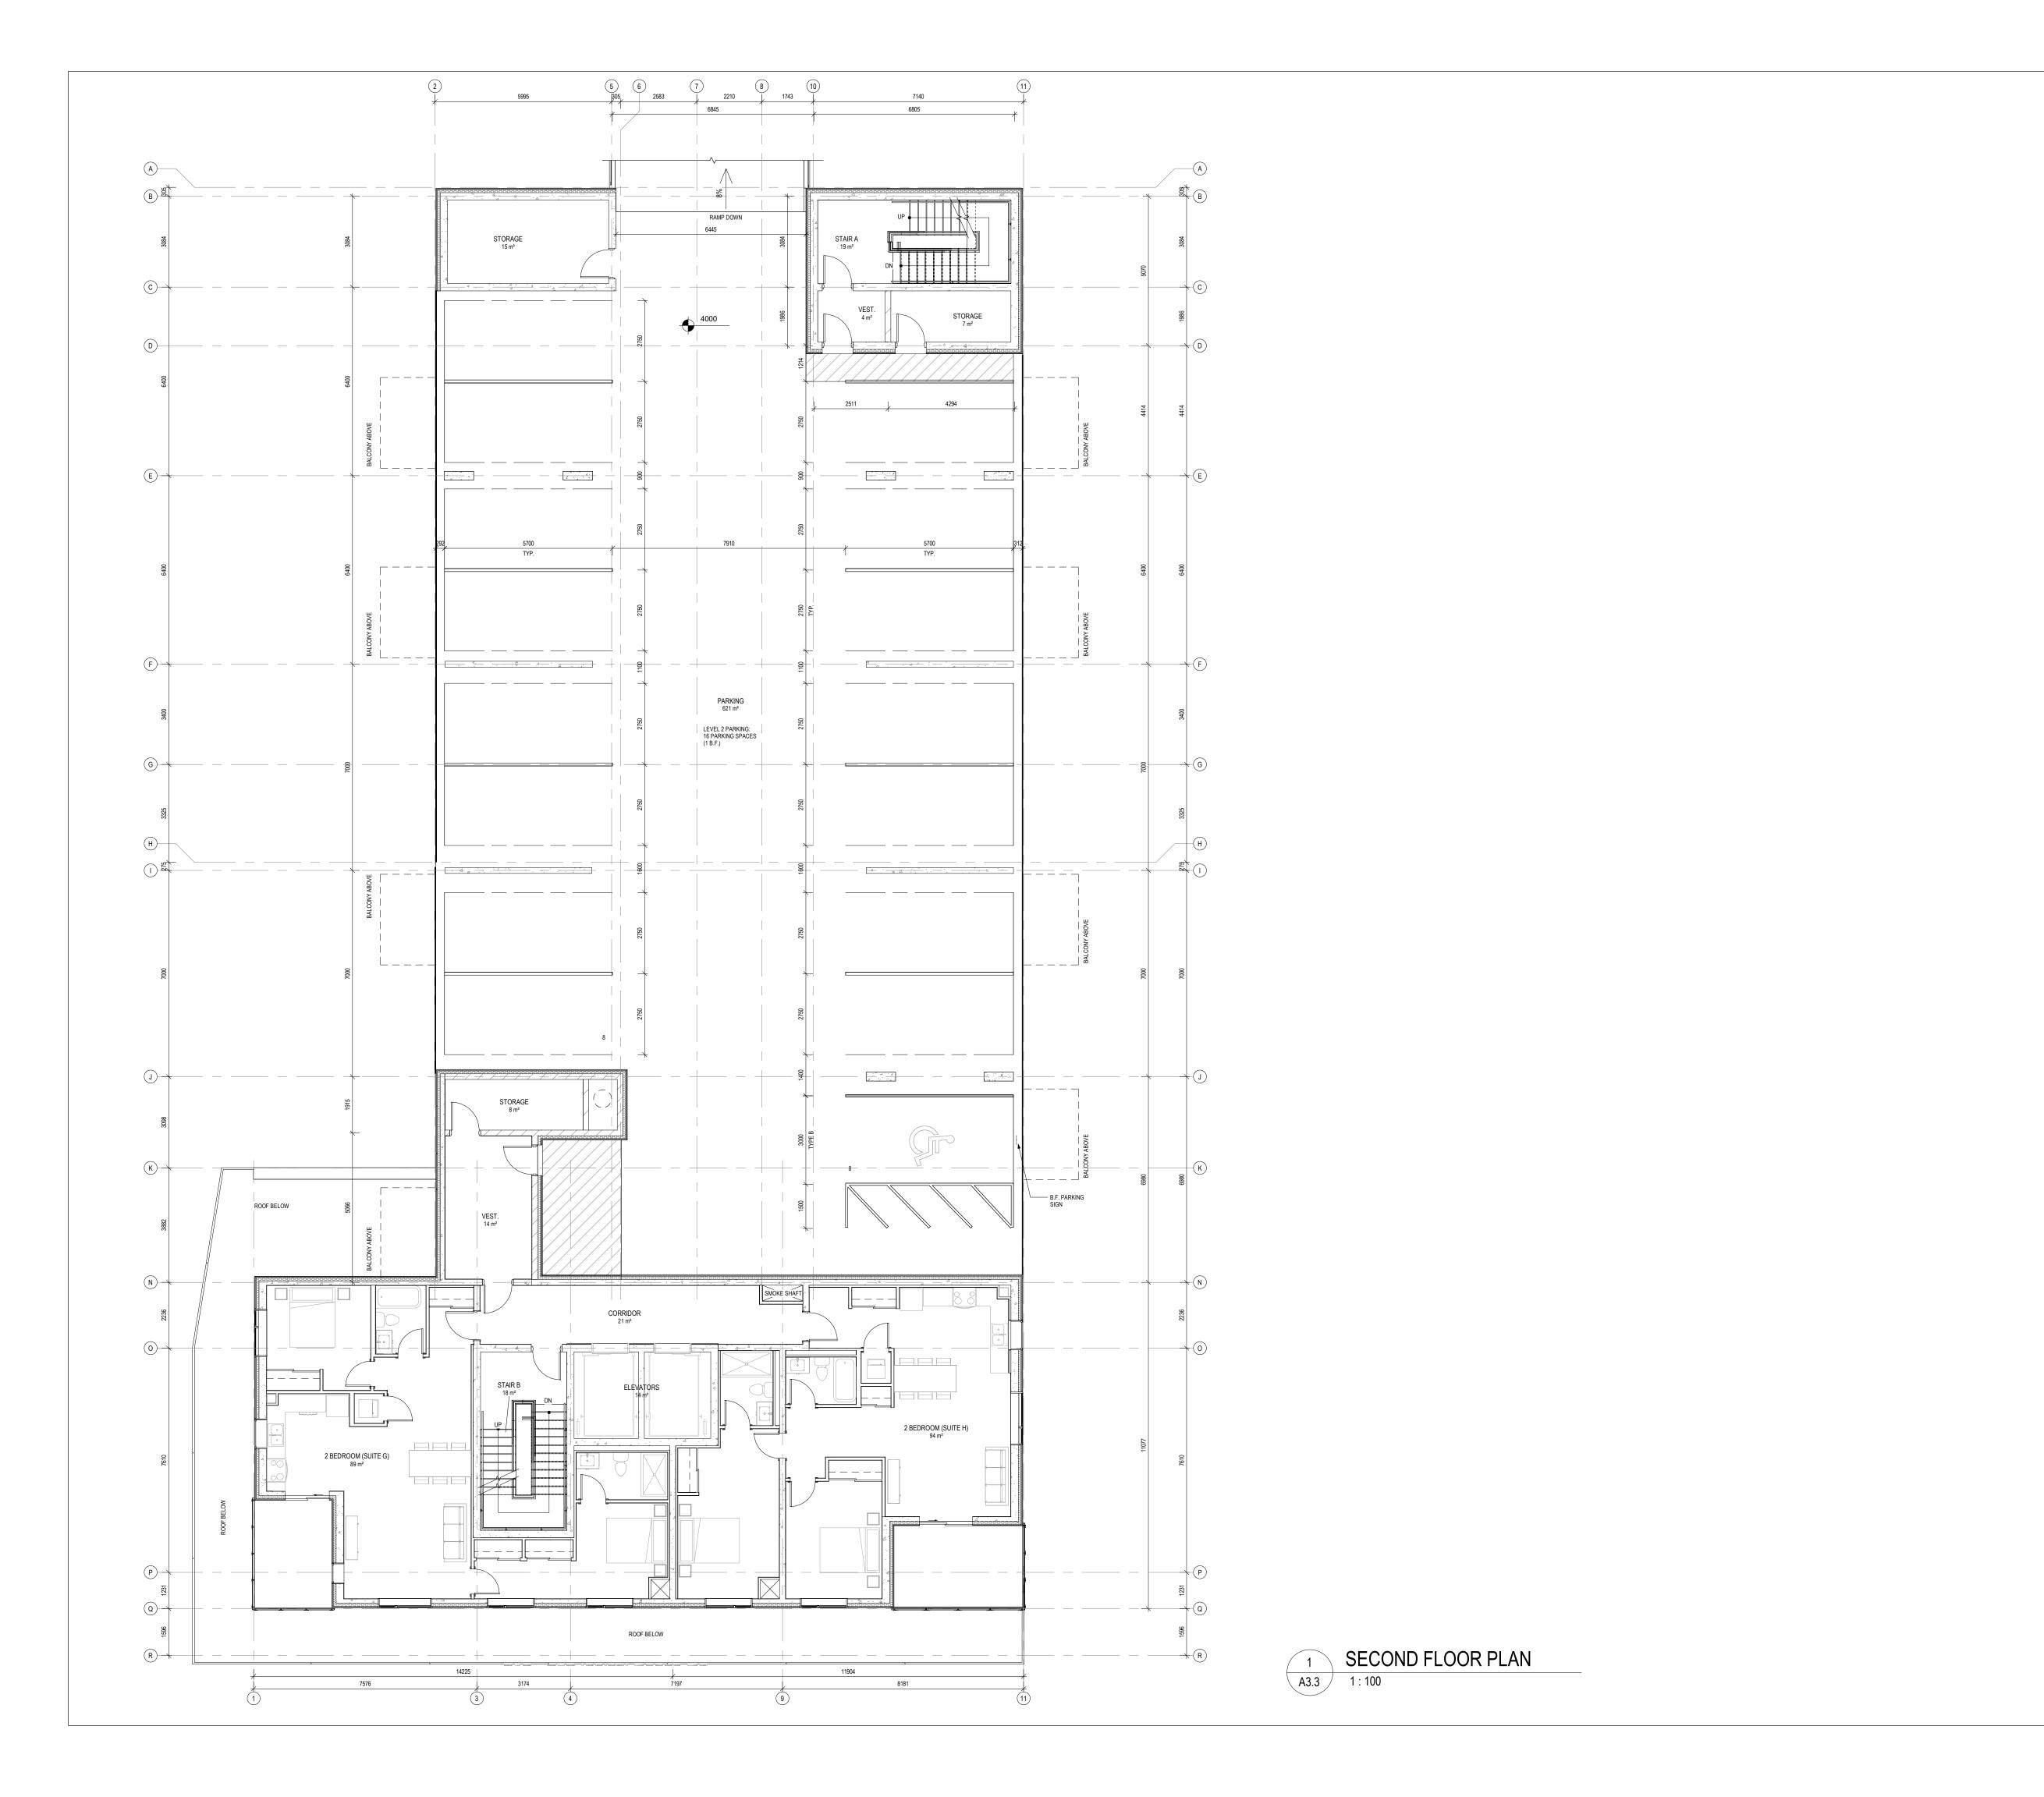
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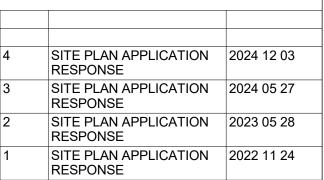
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8 STOREY CONDOMINIUM -INNISFIL 946, 950 INNISFIL BEACH RD, INNISFIL, ON
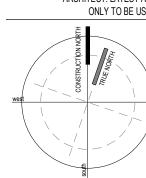
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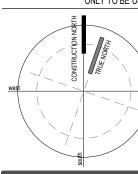
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8 STOREY CONDOMINIUM INNISFIL
946, 950 INNISFIL BEACH RD, INNISFIL, ON


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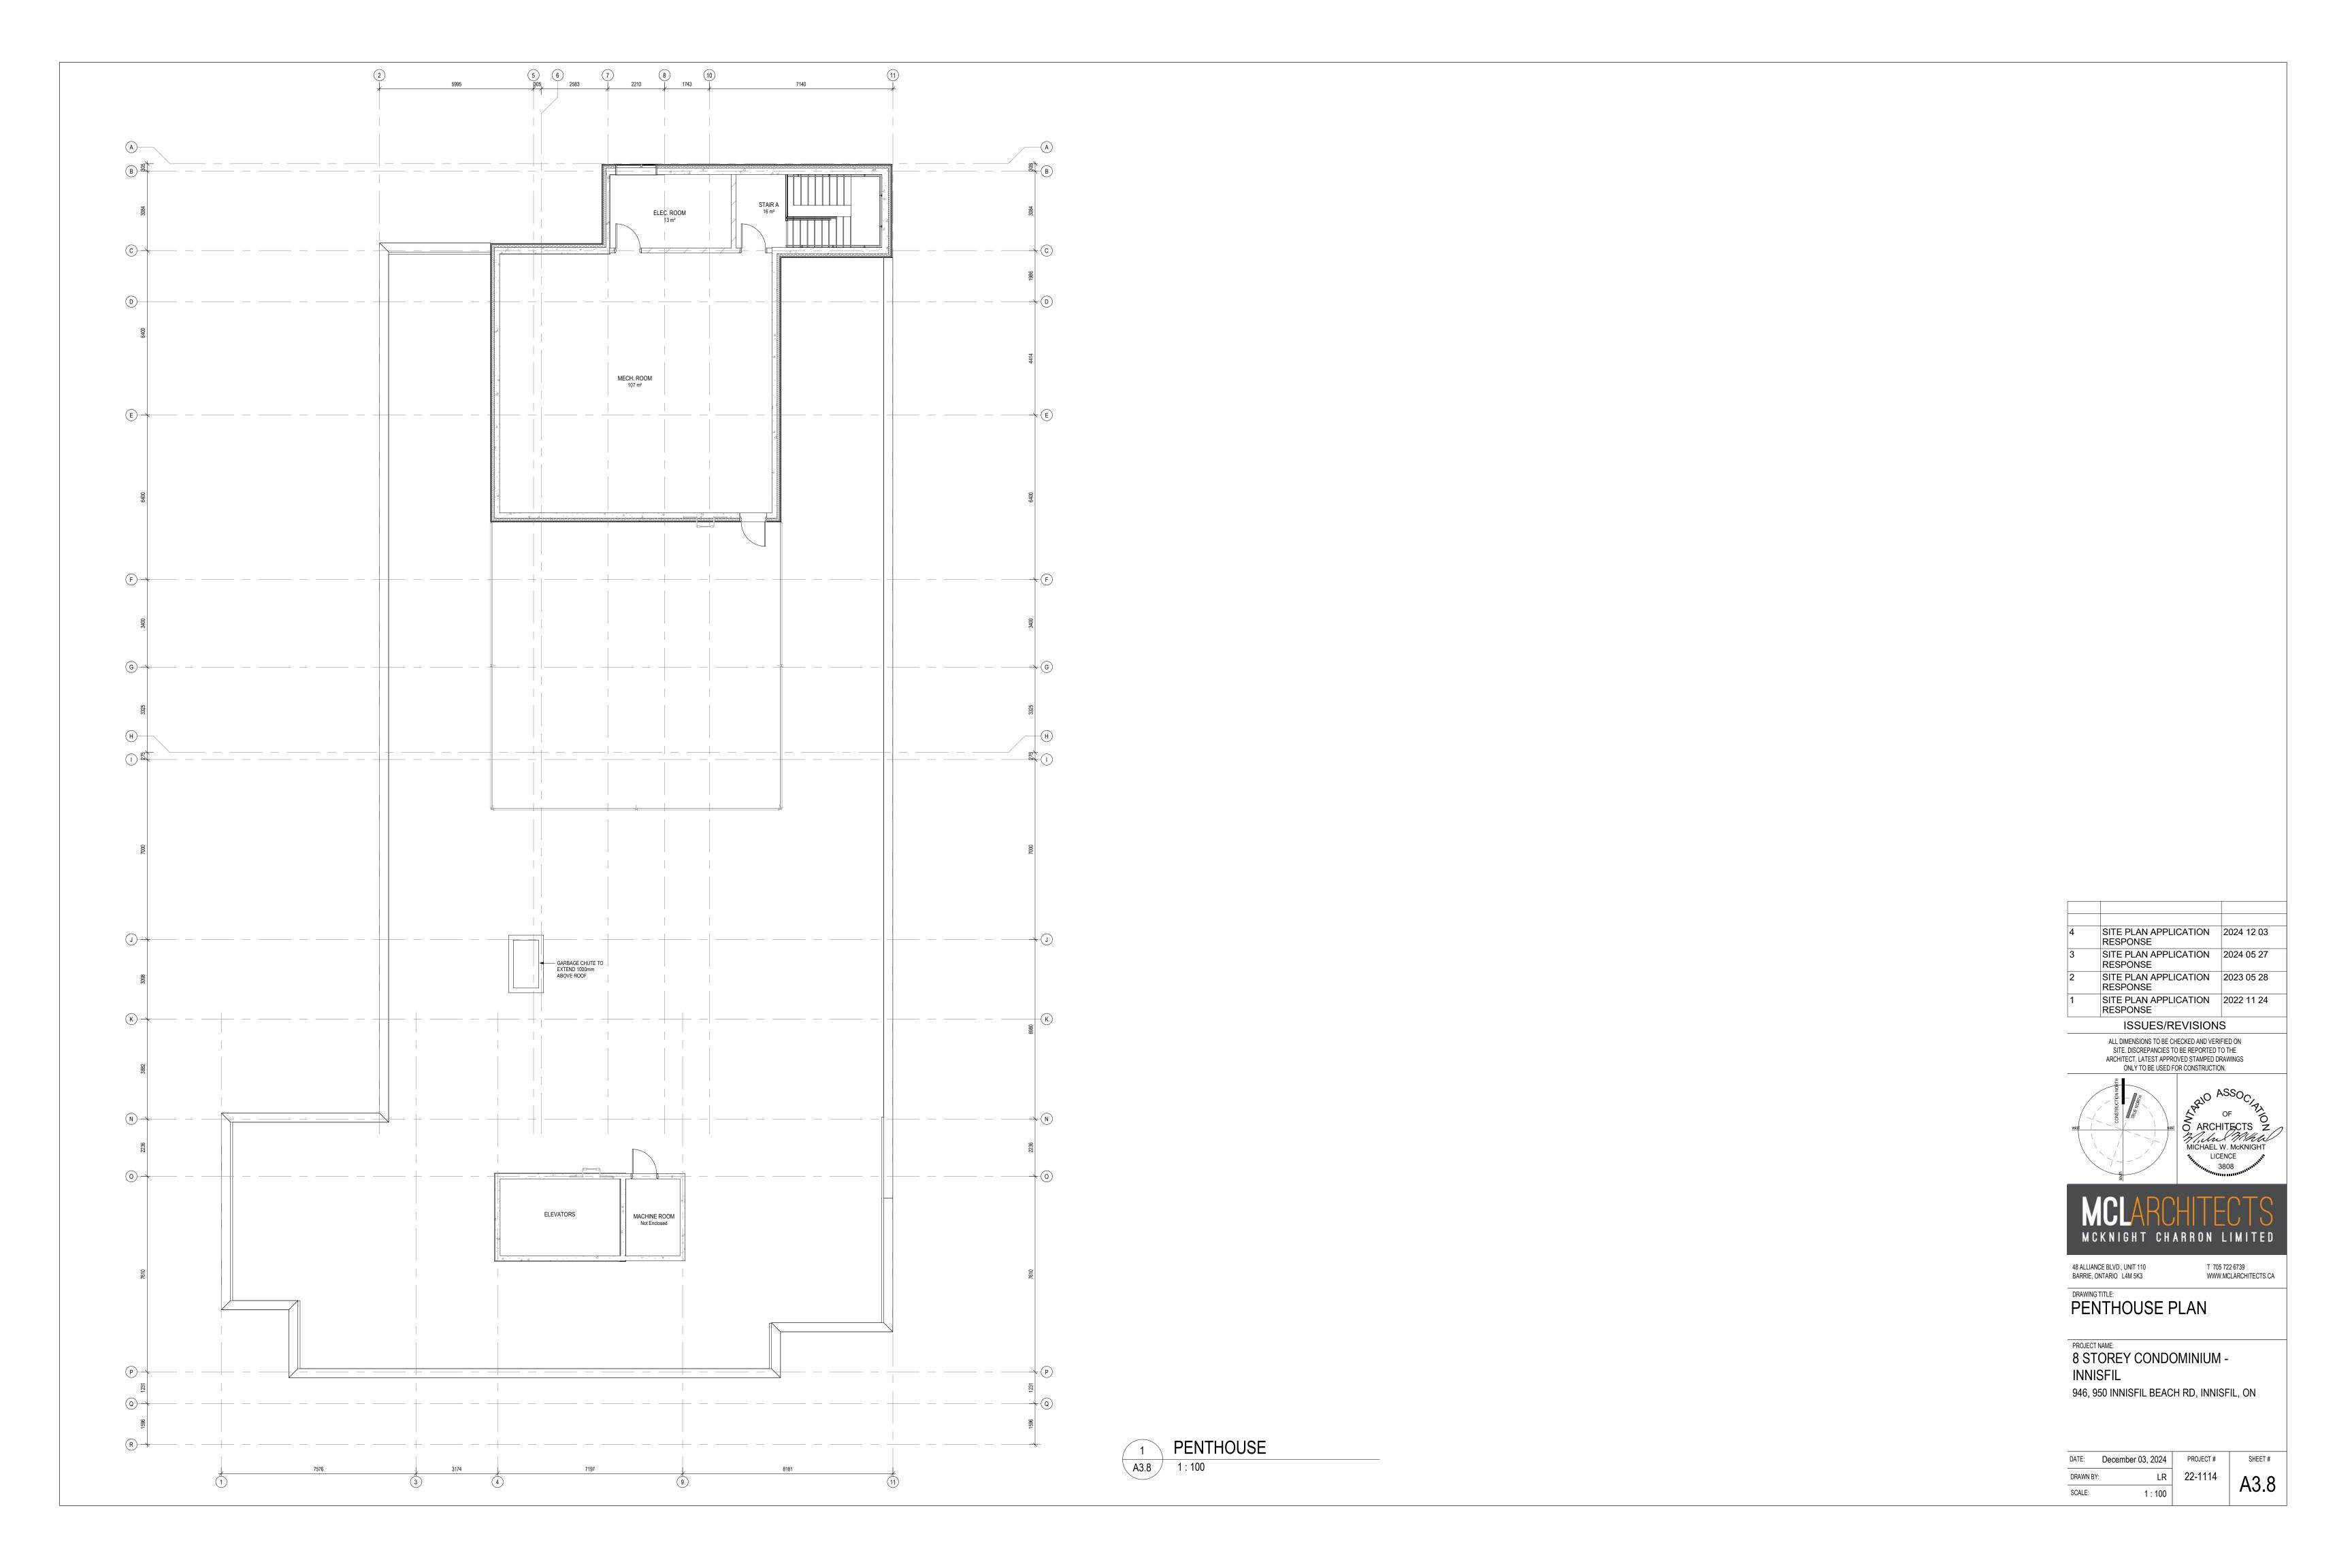
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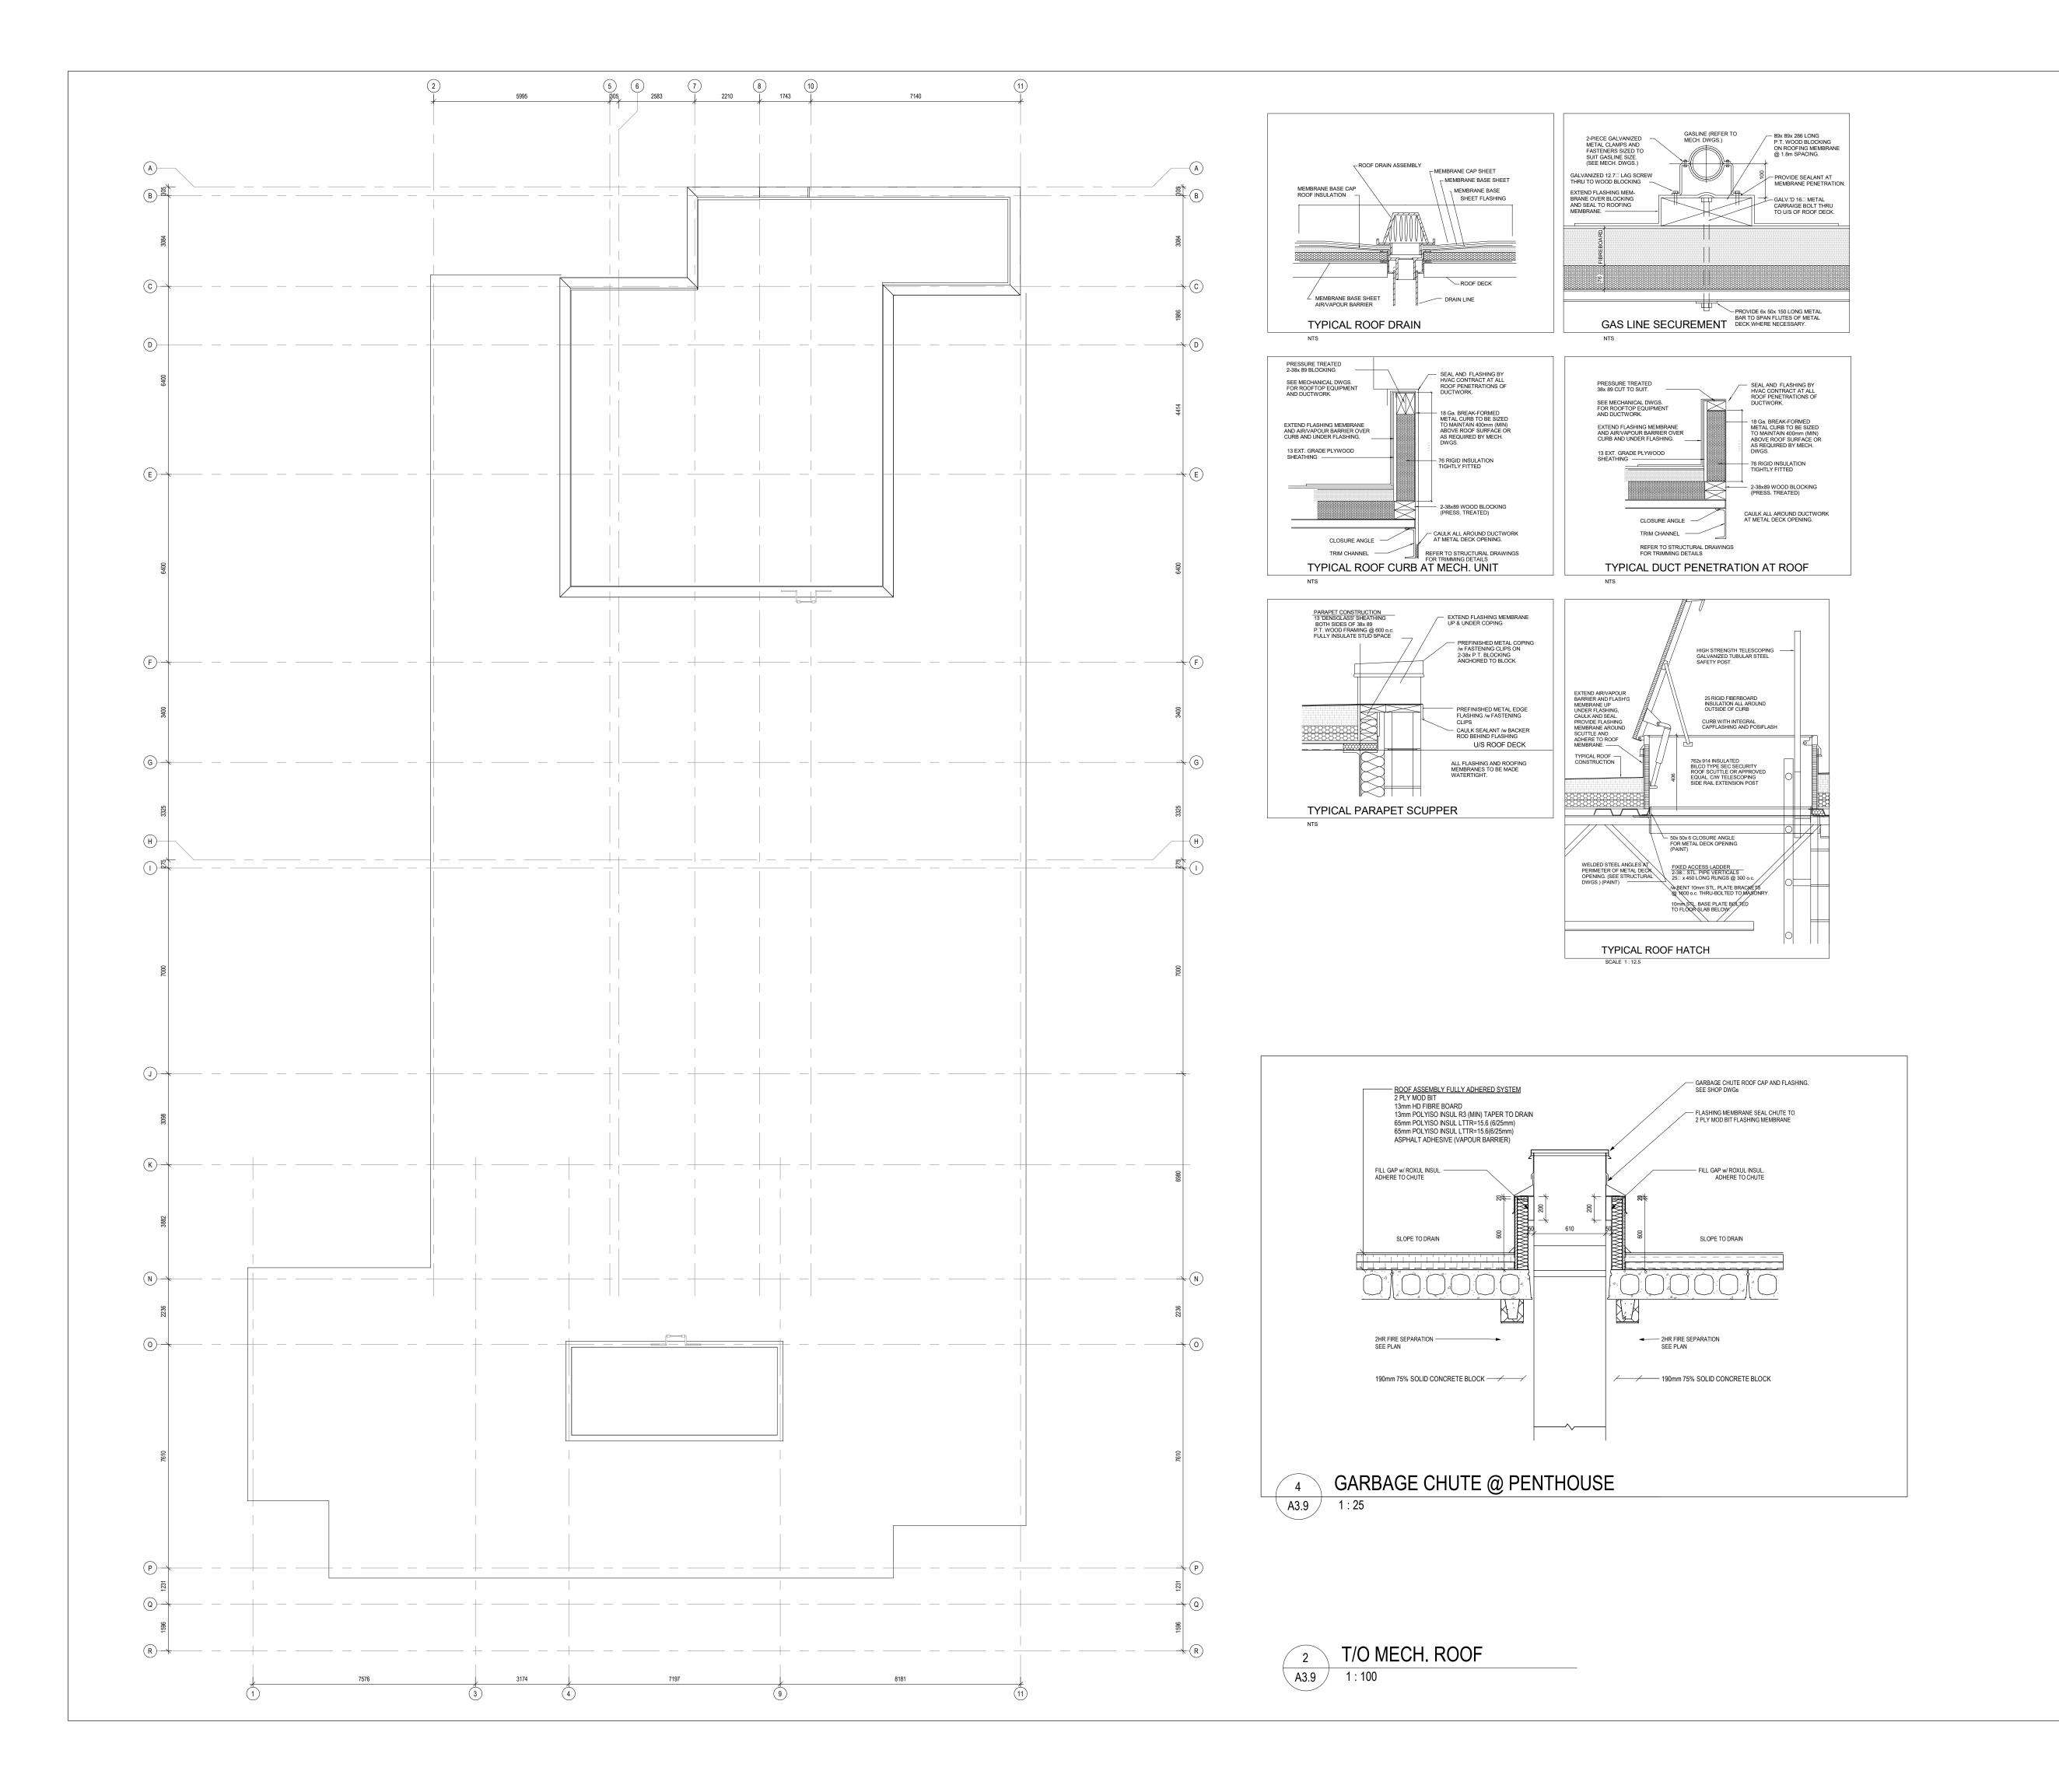












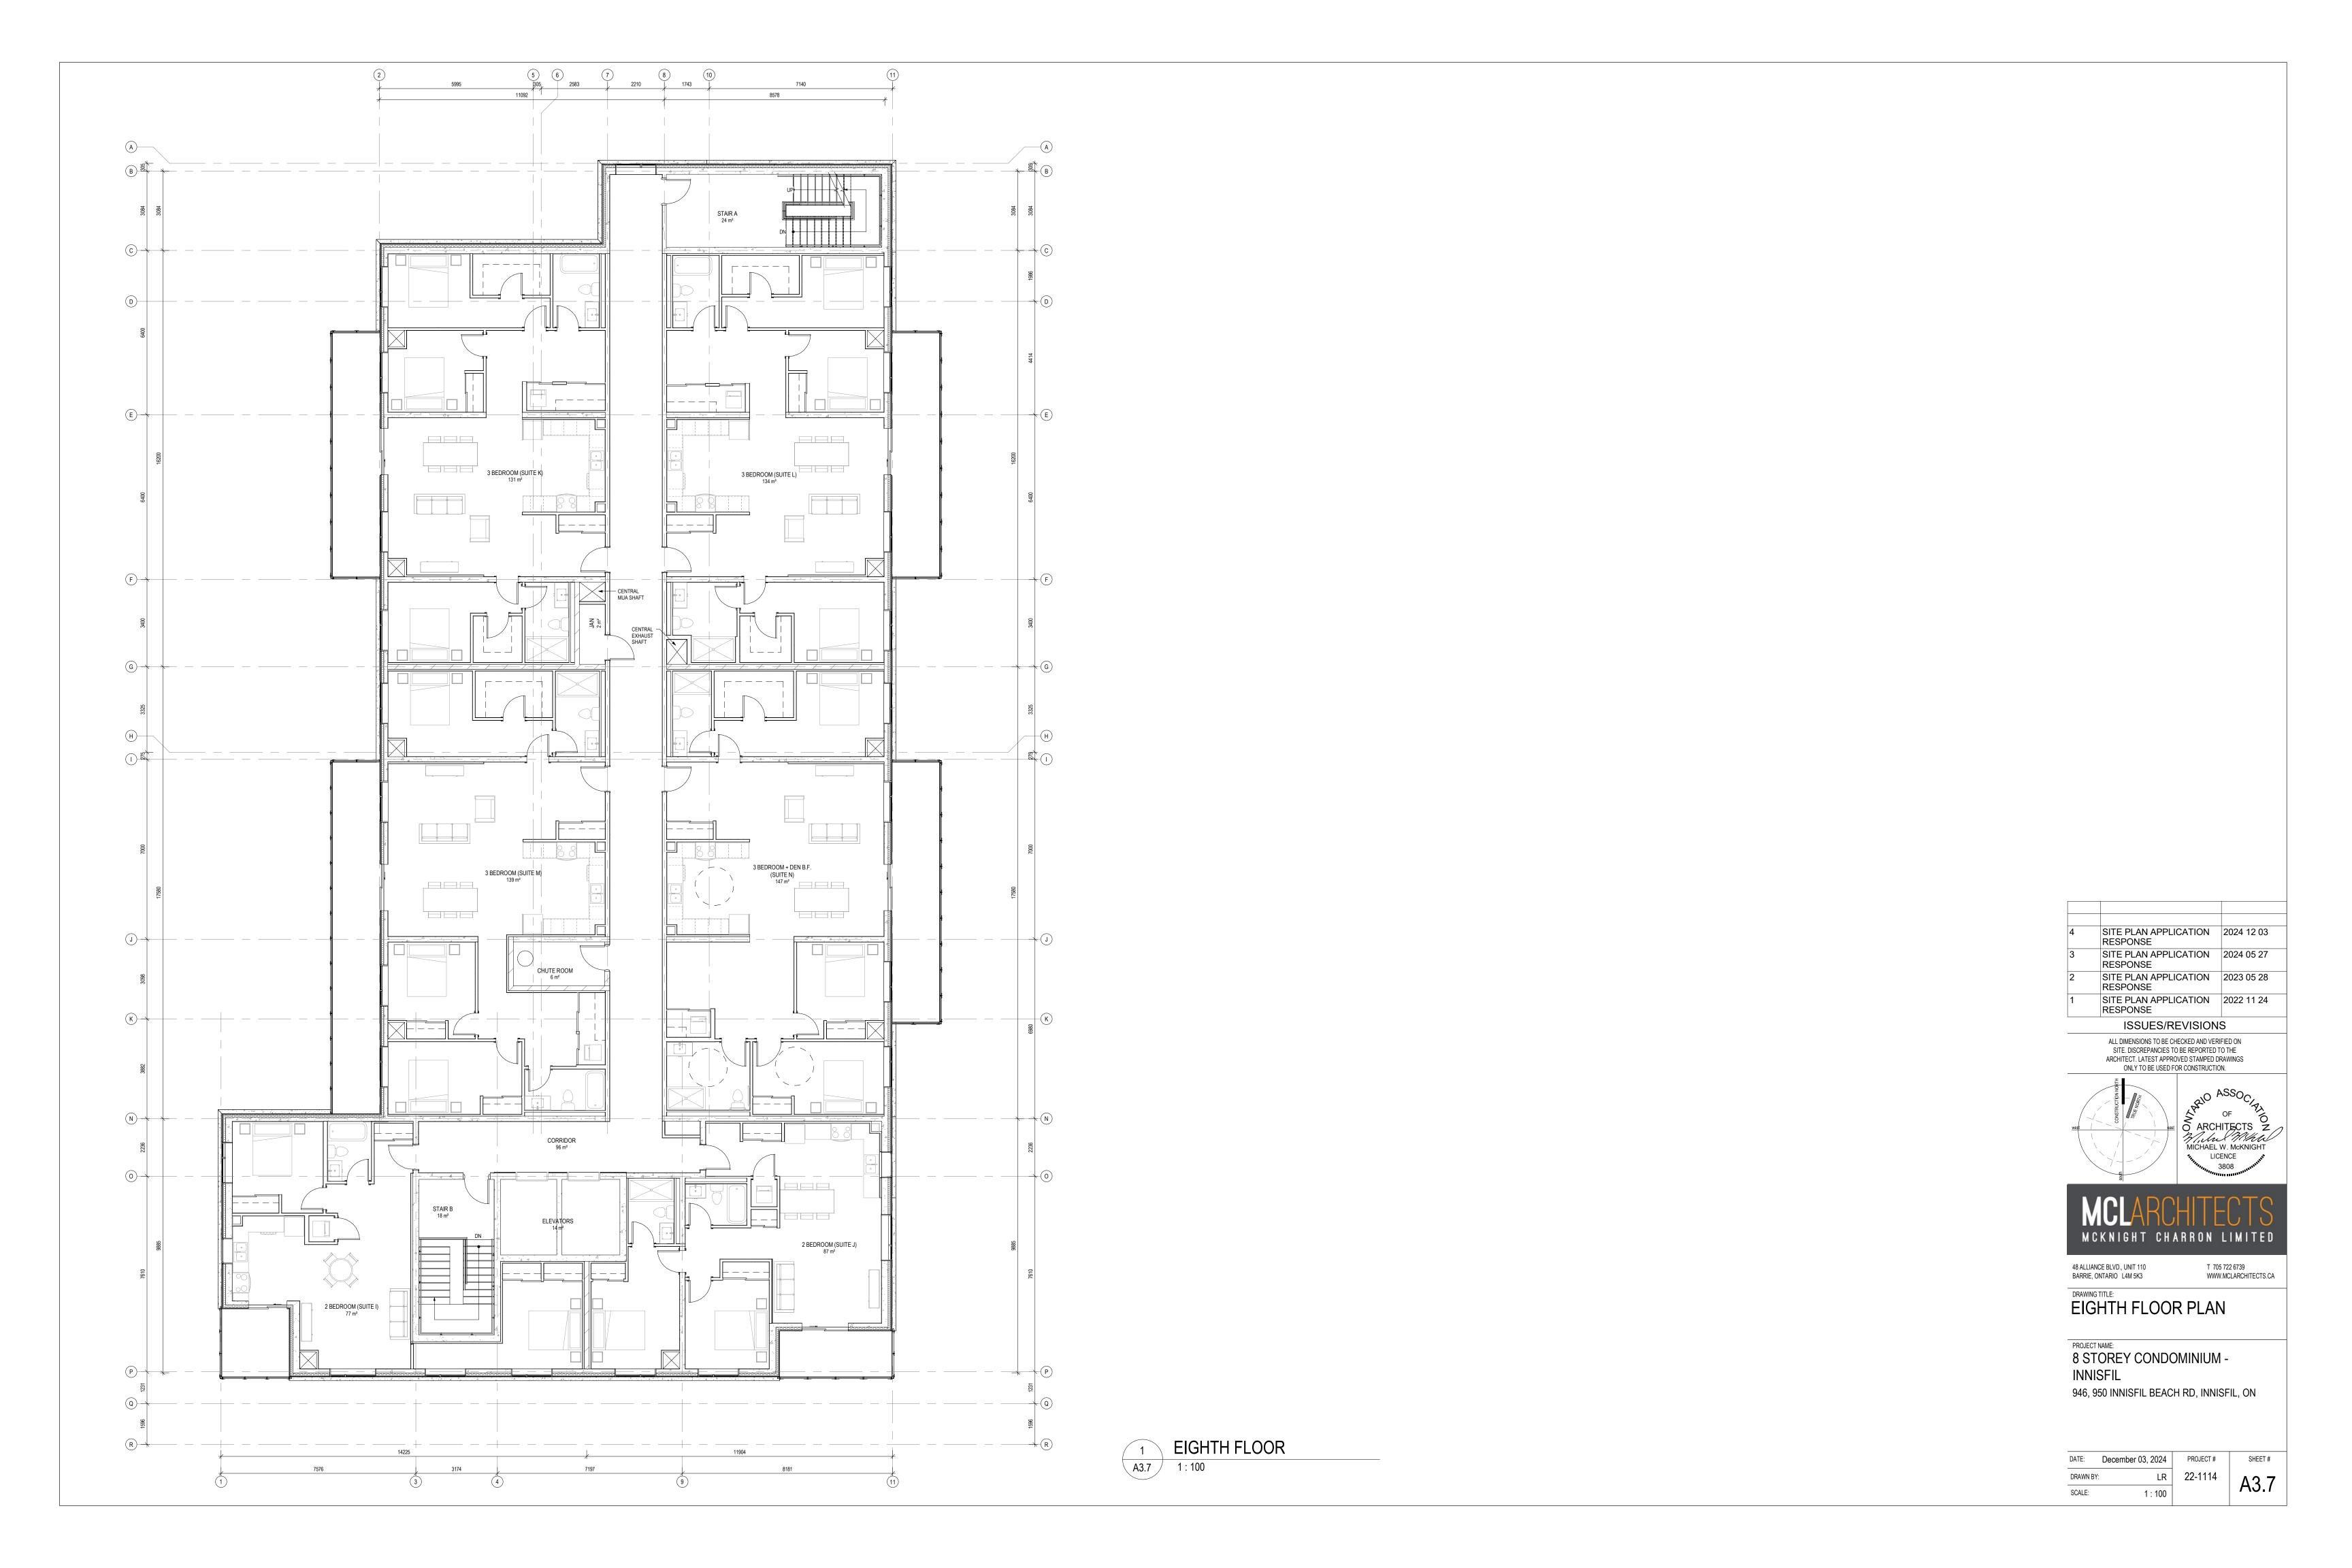

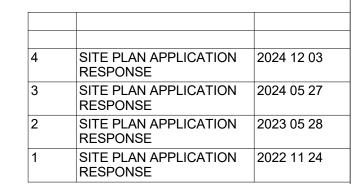

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MICHAEL W. McKNIGHT LICENCE

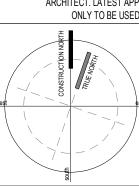

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ROOF PLAN

PROJECT NAME:


8 STOREY CONDOMINIUM -INNISFIL 946, 950 INNISFIL BEACH RD, INNISFIL, ON

DATE:	December 03, 2024	PROJECT #
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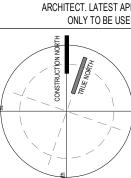
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DRAWING TITLE:
UNIT PLANS

PROJECT NAME:


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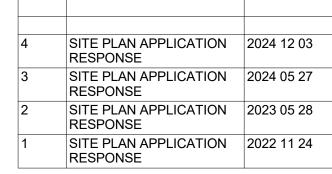
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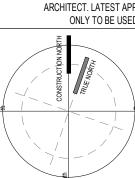
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DRAWING TITLE:
UNIT PLANS


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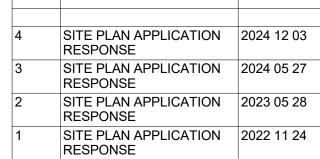
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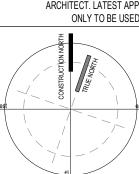


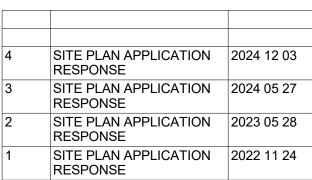



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T 705 722 6739 WWW.MCLARCHITECTS.CA

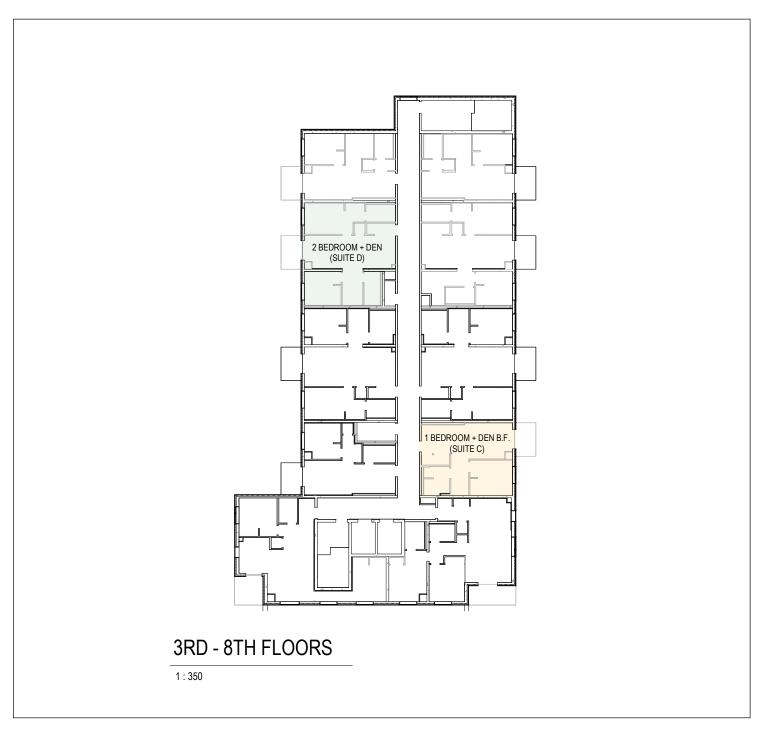DRAWING TITLE:
UNIT PLANS

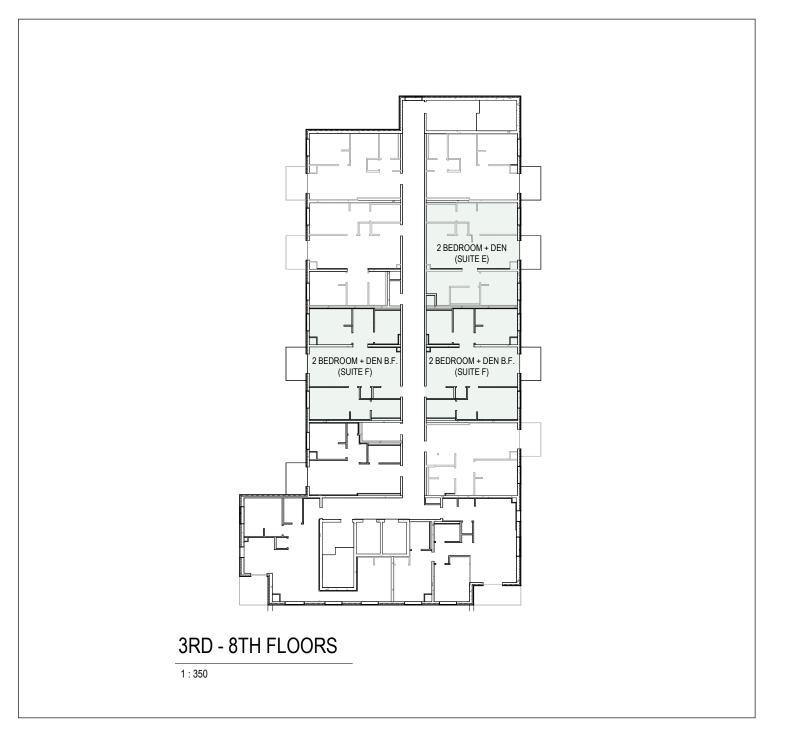PROJECT NAME:


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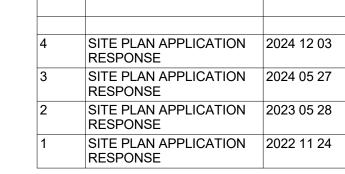
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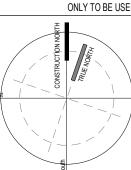
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48 ALLIANCE BLVD., UNIT 110 BARRIE, ONTARIO L4M 5K3

T 705 722 6739 WWW.MCLARCHITECTS.CA


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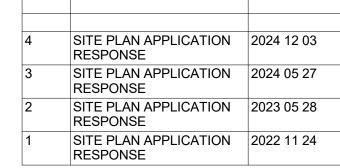
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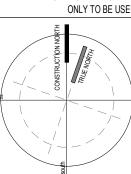
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48 ALLIANCE BLVD., UNIT 110 BARRIE, ONTARIO L4M 5K3 T 705 722 6739 WWW.MCLARCHITECTS.CA

DRAWING TITLE:
UNIT PLANS

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PROJECT NAME:

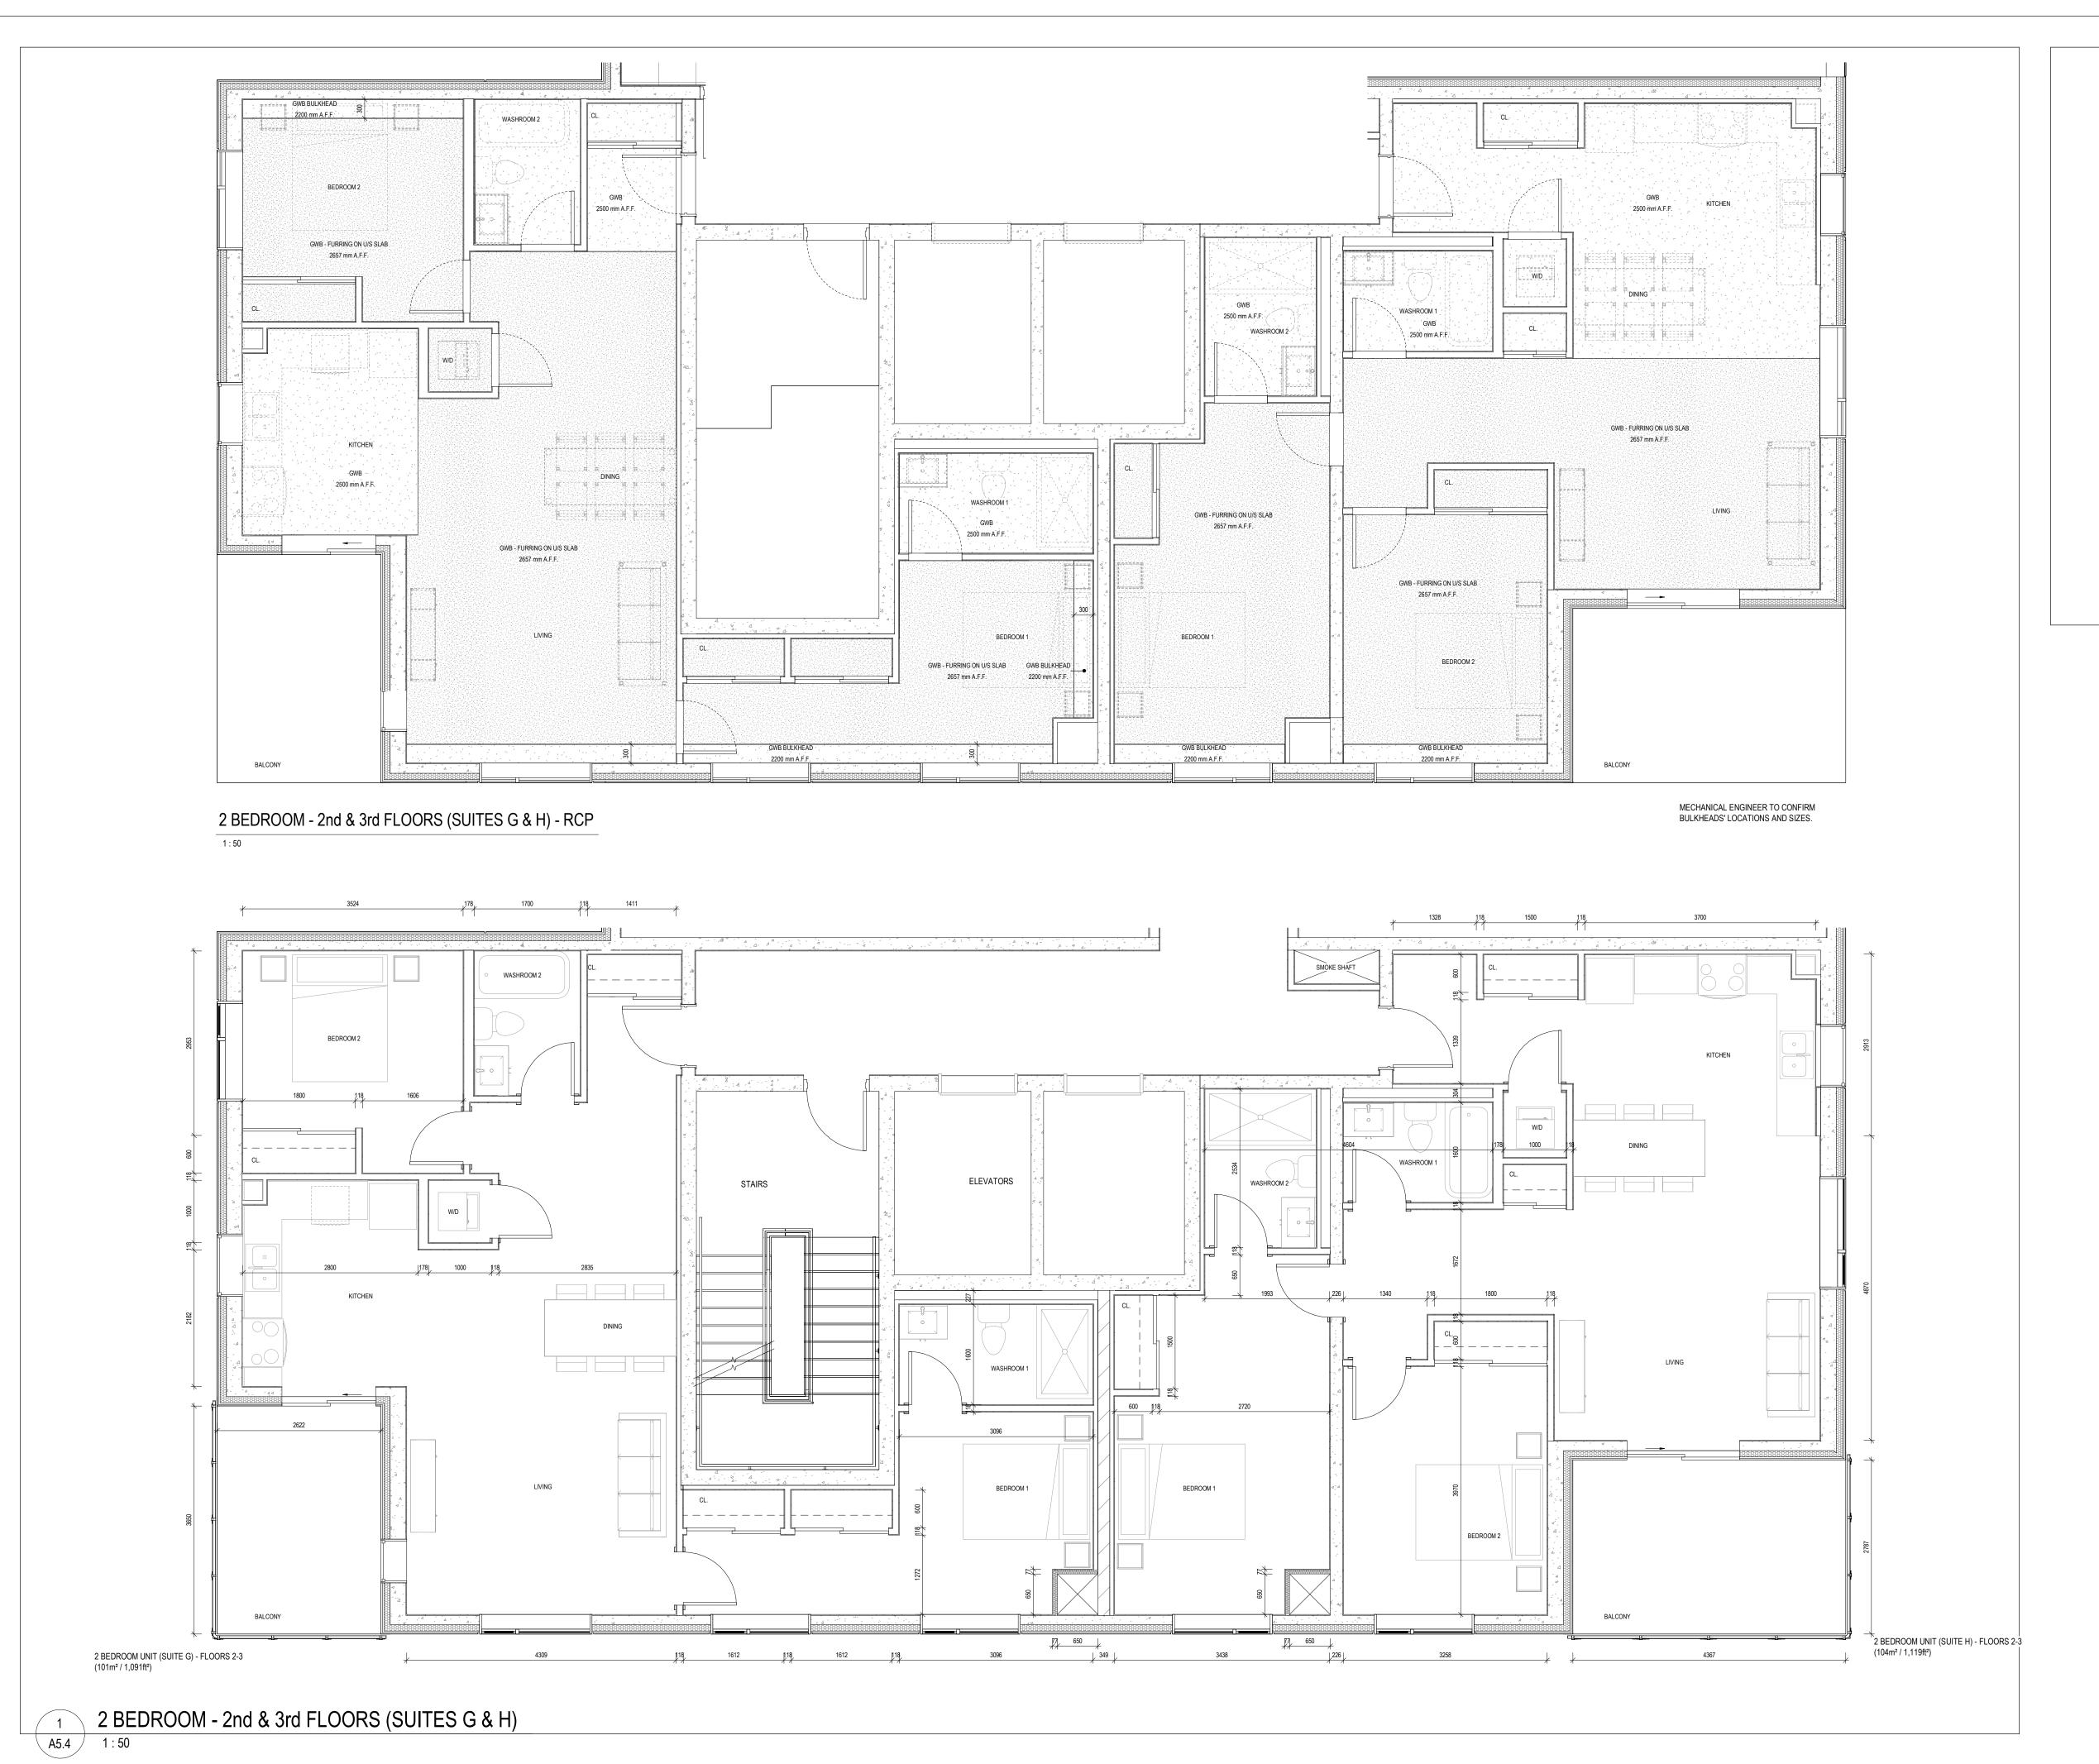8 STOREY CONDOMINIUM INNISFIL


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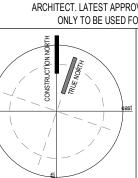
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SITE PLAN APPLICATION 2024 12 03 RESPONSE ISSUES/REVISIONS
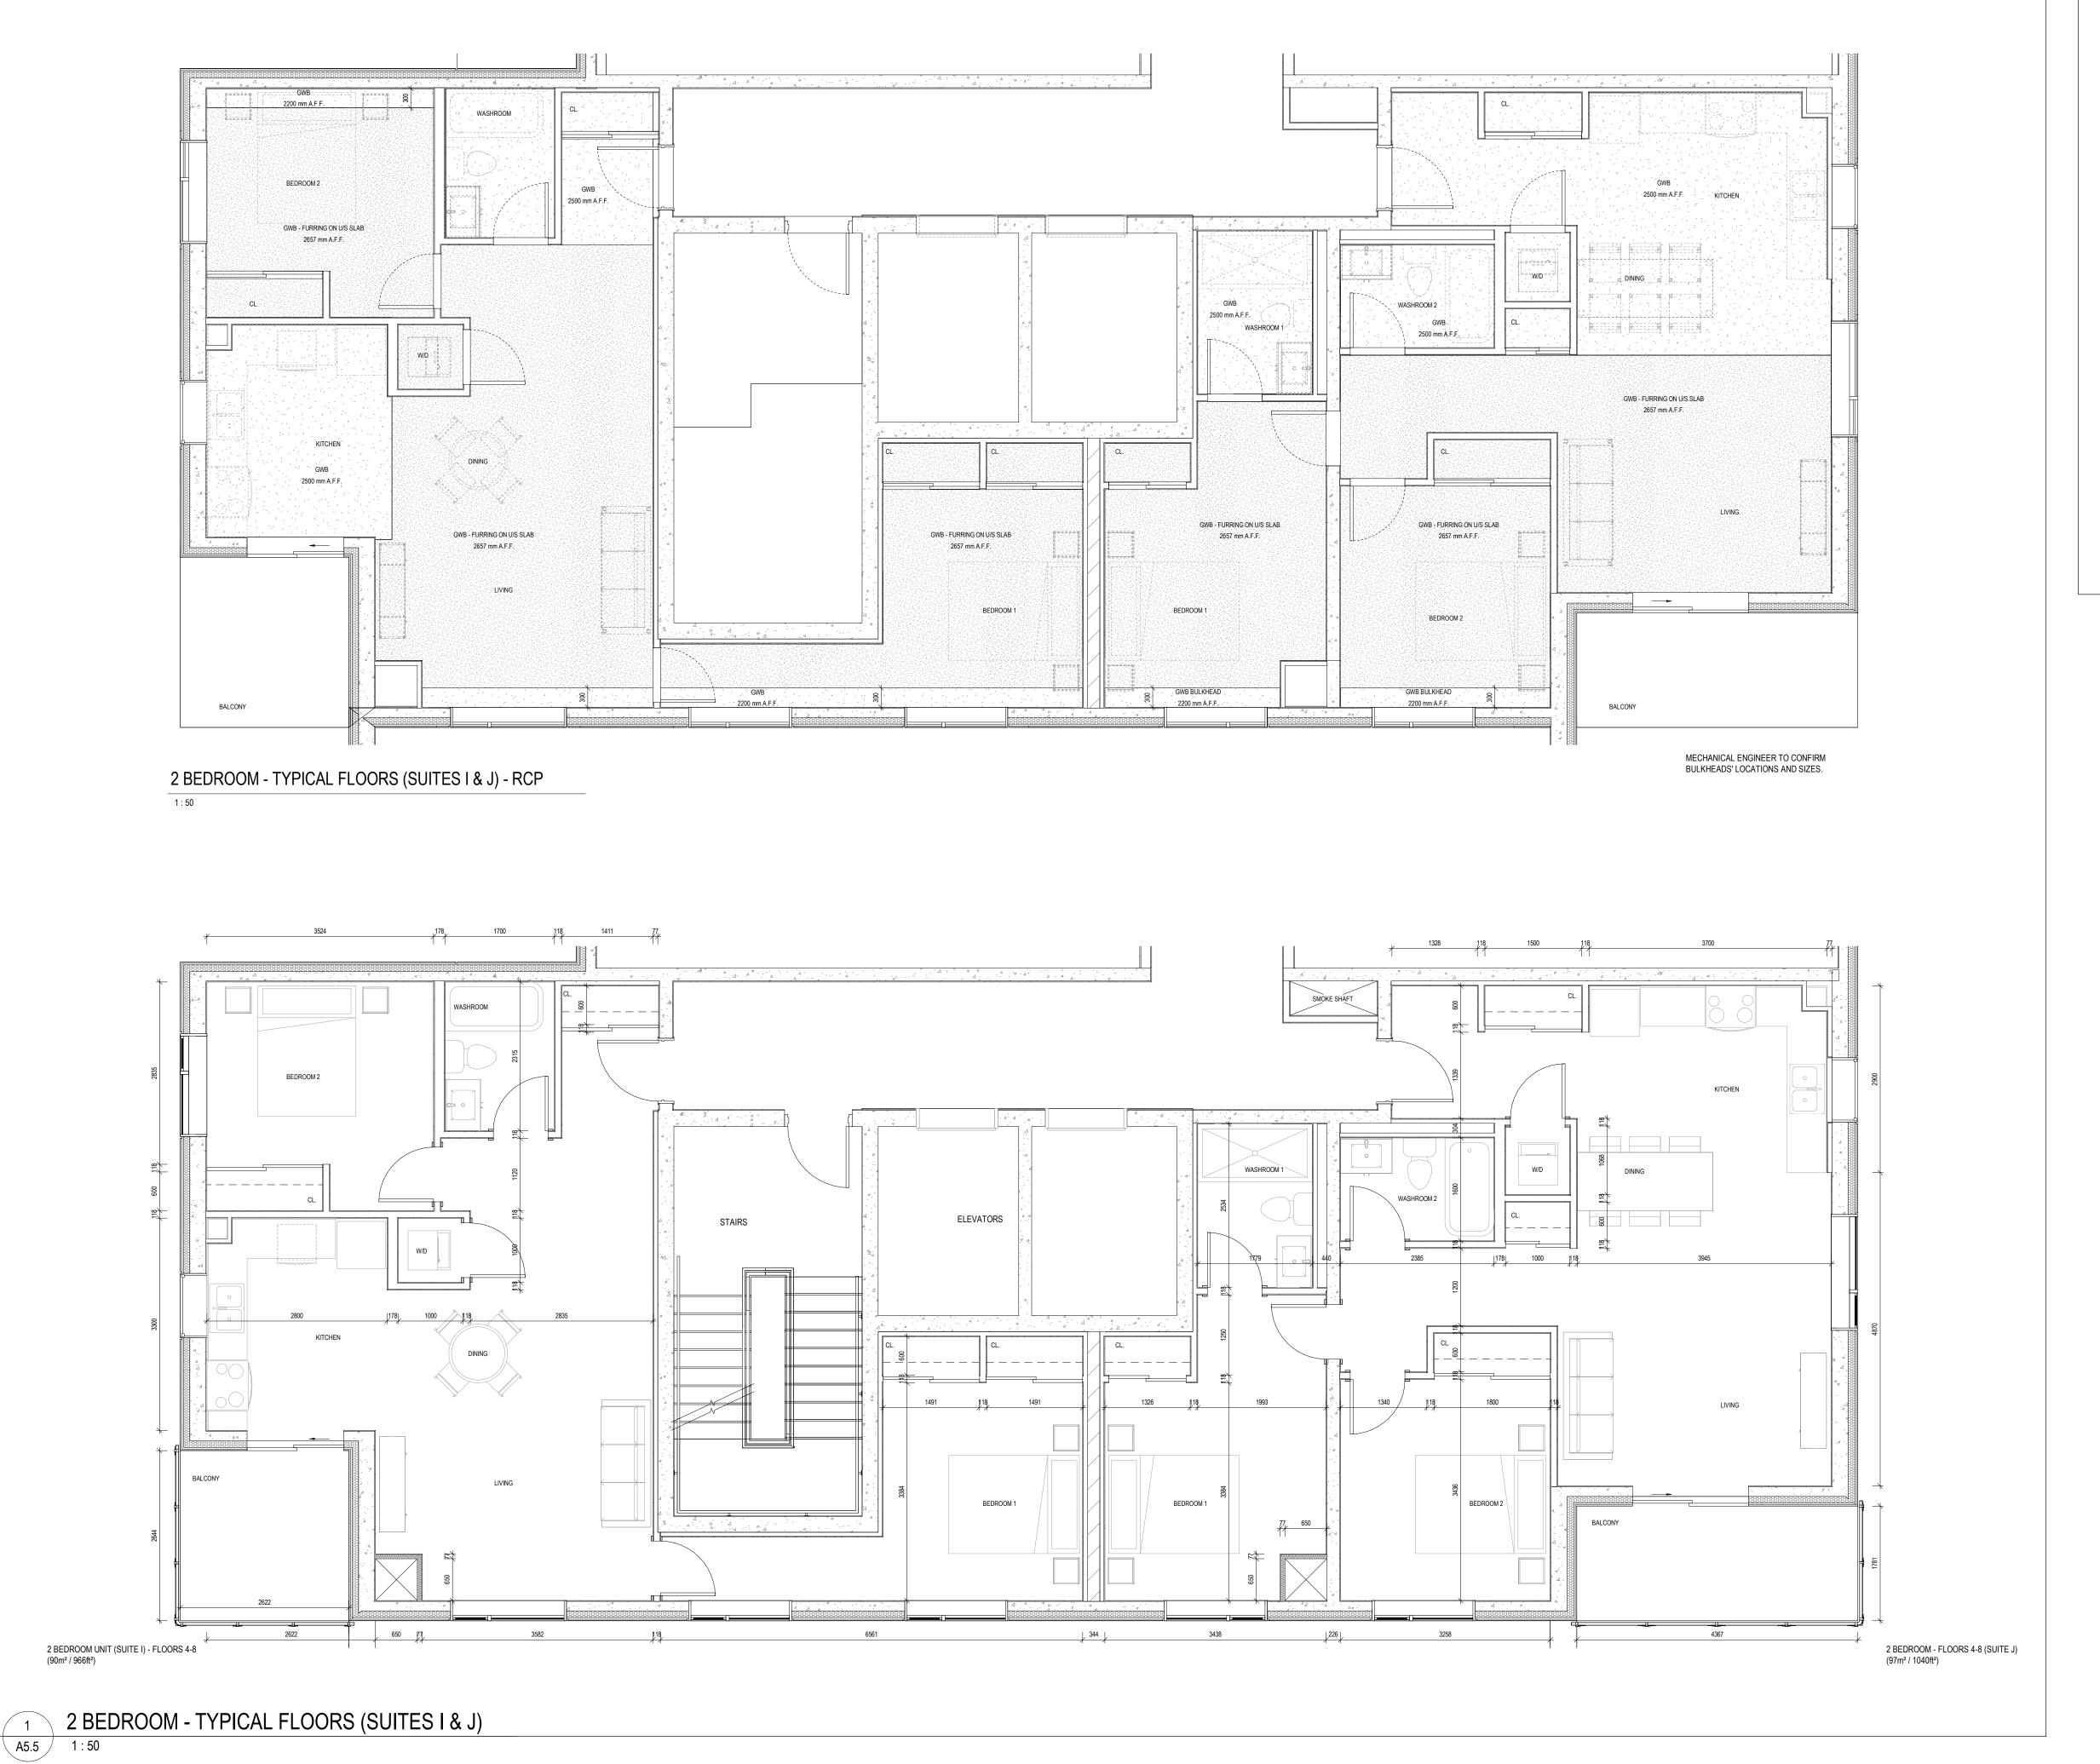
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48 ALLIANCE BLVD., UNIT 110 BARRIE, ONTARIO L4M 5K3

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DRAWING TITLE:
UNIT PLANS

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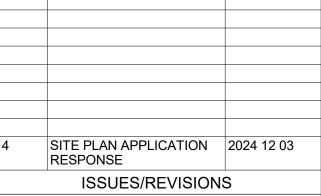
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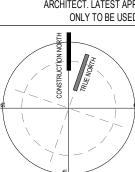
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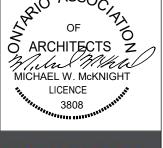




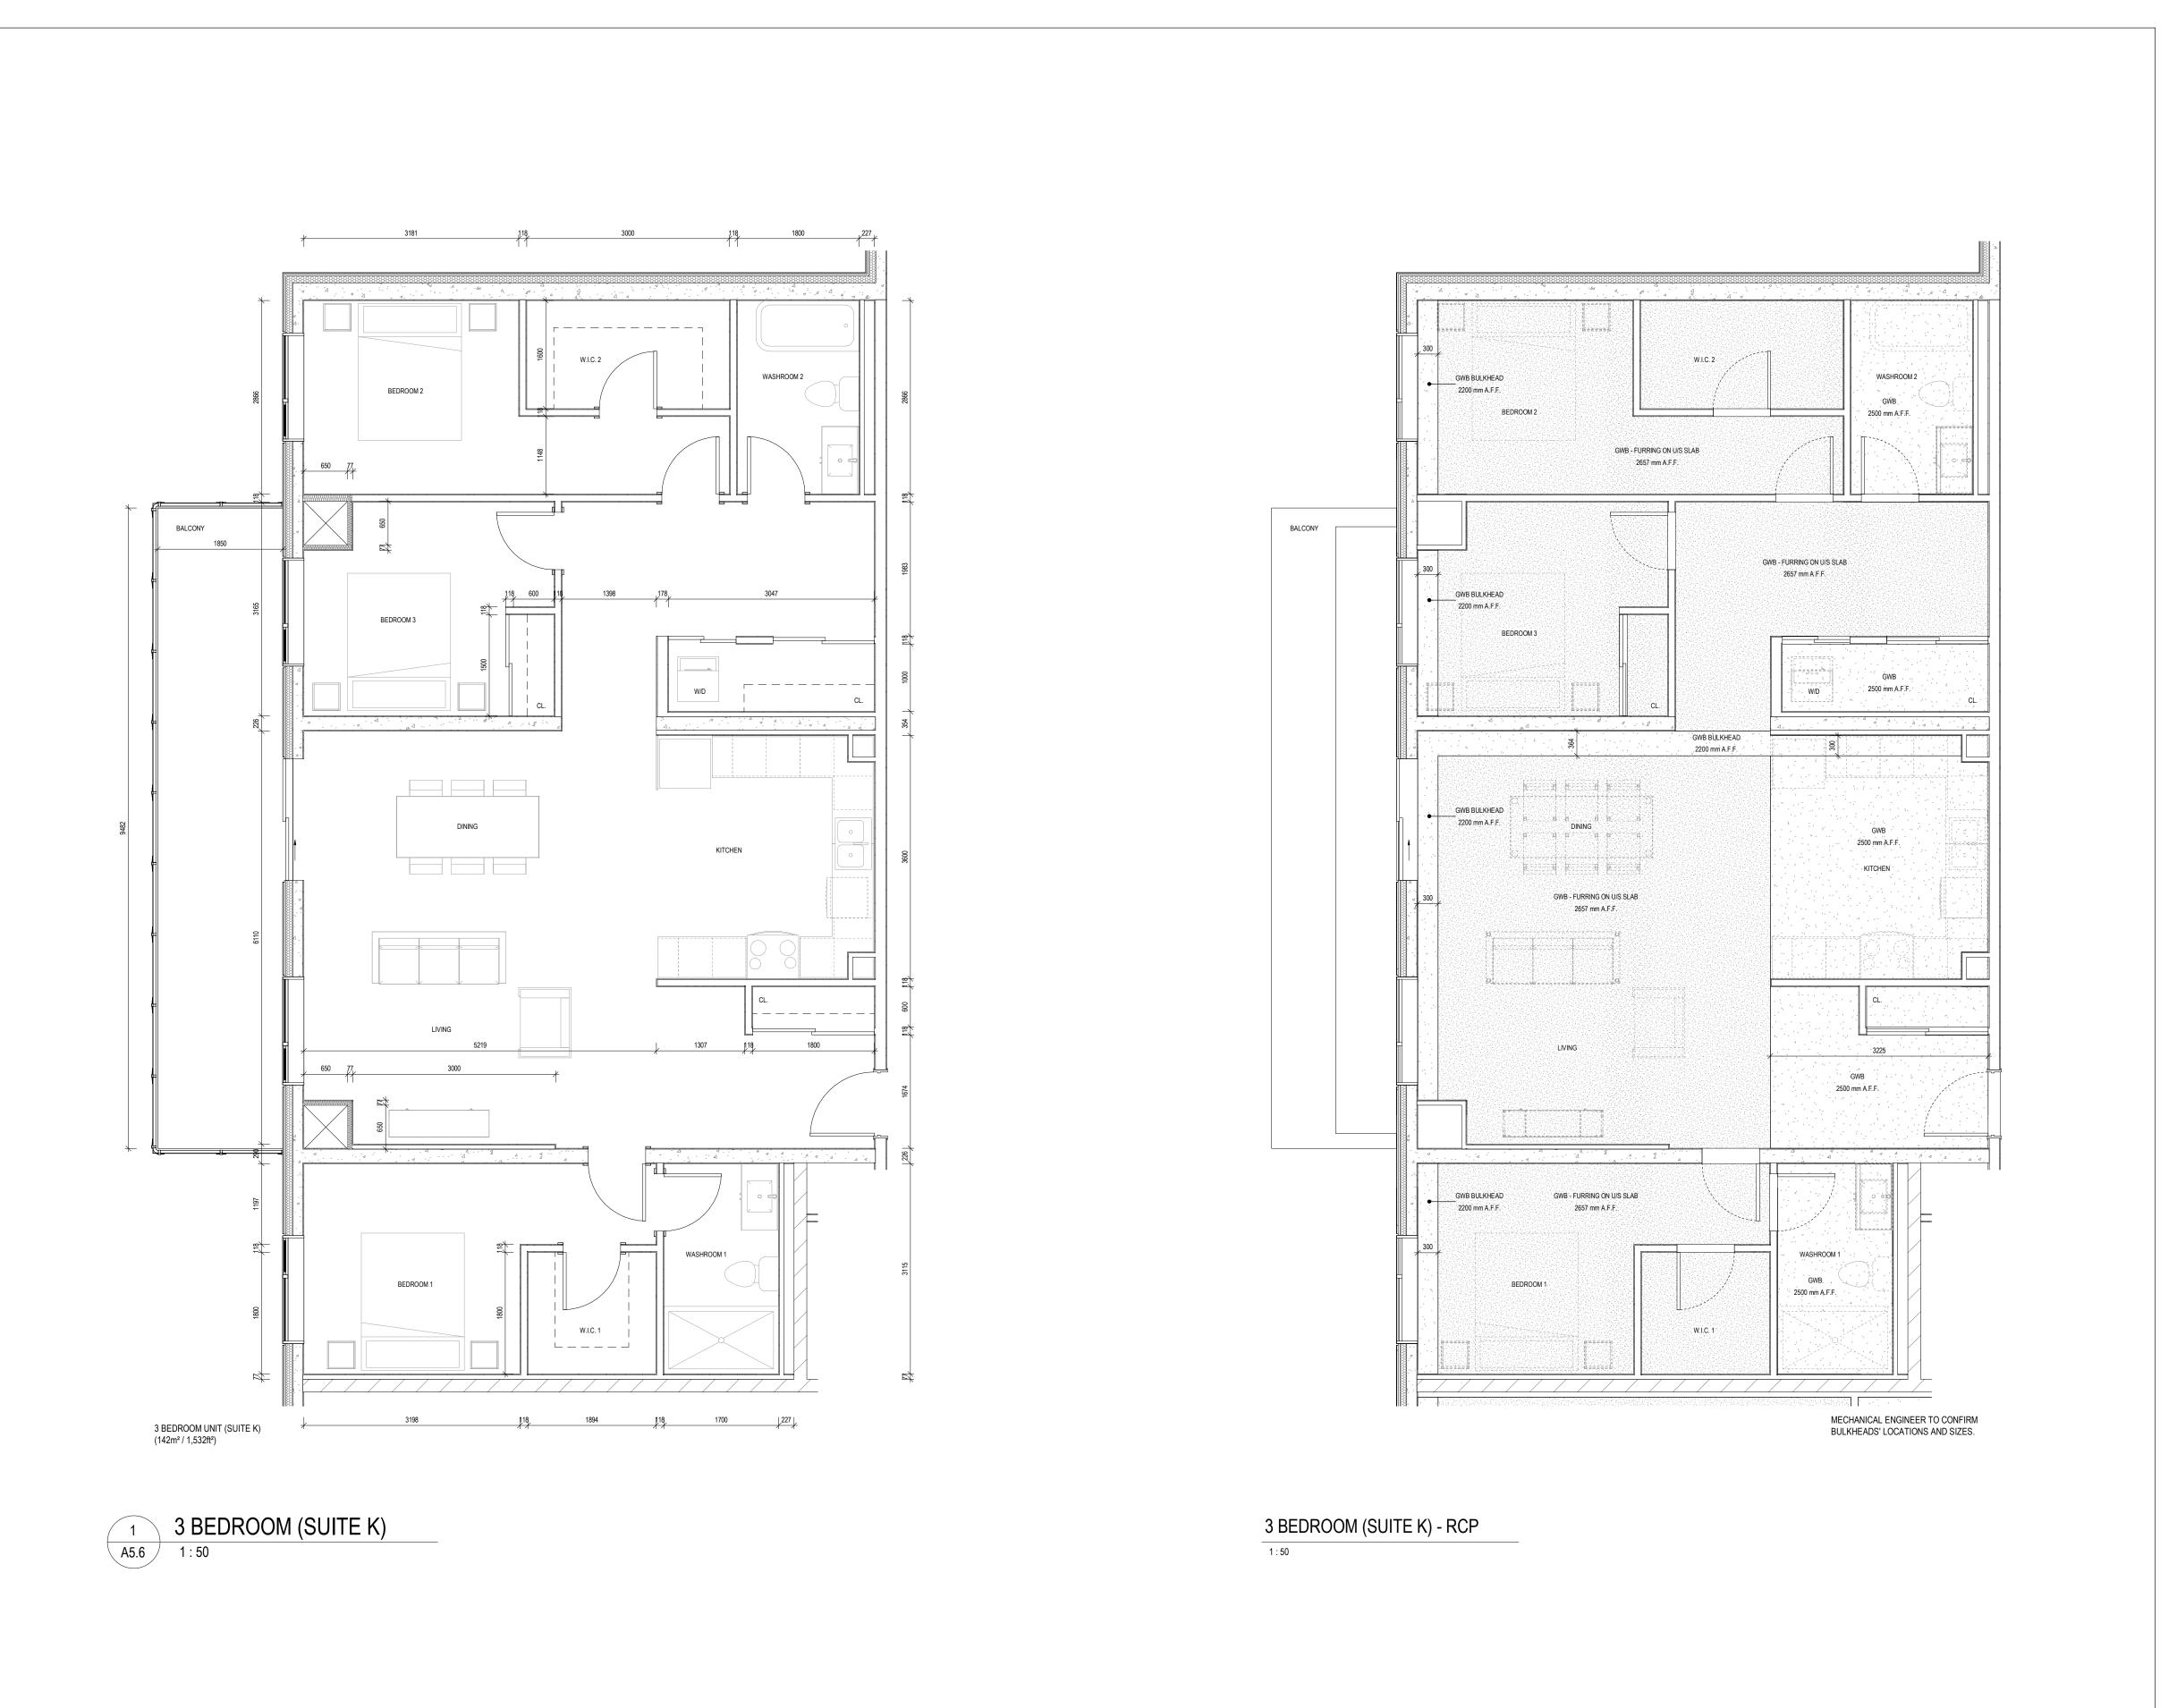

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48 ALLIANCE BLVD., UNIT 110 BARRIE, ONTARIO L4M 5K3

T 705 722 6739 WWW.MCLARCHITECTS.CA

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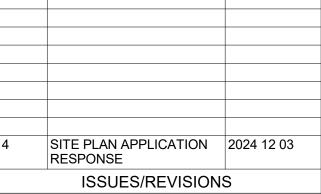
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DATE: December 03, 2024 PROJECT # SCALE:

As indicated







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T 705 722 6739 WWW.MCLARCHITECTS.CA

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UNIT PLANS


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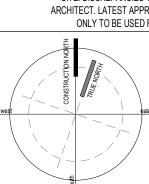
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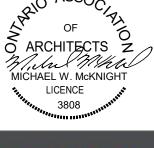






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48 ALLIANCE BLVD., UNIT 110 BARRIE, ONTARIO L4M 5K3

T 705 722 6739 WWW.MCLARCHITECTS.CA

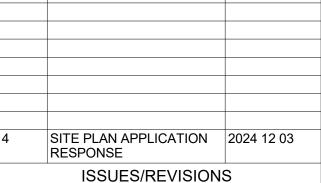DRAWING TITLE:
UNIT PLANS

PROJECT NAME: 8 STOREY CONDOMINIUM -INNISFIL 946, 950 INNISFIL BEACH RD, INNISFIL, ON

DATE: December 03, 2024 PROJECT # SCALE: As indicated



1 SOUTH ELEVATION - FRONT A6.1 1 : 150



NORTH ELEVATION A6.1 1 : 150







2 ACM PANEL 2





NORTEM - NORTHWOOD FLUTED PANEL - WALNUT




BRAMPTON BRICK - ECLIPSE SUAVE FINISH

SITE PLAN APPLICATION 2024 12 03 RESPONSE SITE PLAN APPLICATION 2024 05 27 RESPONSE SITE PLAN APPLICATION 2023 05 28 RESPONSE SITE PLAN APPLICATION 2022 11 24 RESPONSE

ISSUES/REVISIONS

ALL DIMENSIONS TO BE CHECKED AND VERIFIED ON SITE. DISCREPANCIES TO BE REPORTED TO THE ARCHITECT. LATEST APPROVED STAMPED DRAWINGS ONLY TO BE USED FOR CONSTRUCTION.

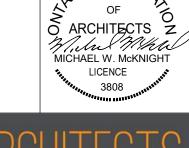



48 ALLIANCE BLVD., UNIT 110 BARRIE, ONTARIO L4M 5K3

T 705 722 6739 WWW.MCLARCHITECTS.CA

A6.1

DRAWING TITLE:

**ELEVATIONS** 

PROJECT NAME:

8 STOREY CONDOMINIUM -INNISFIL 946, 950 INNISFIL BEACH RD, INNISFIL, ON

DATE: December 03, 2024 PROJECT #

SCALE: As indicated



1 WEST ELEVATION

A6.2 1 : 150



**EAST ELEVATION** 

A6.2 1 : 150

1 ACM PANEL 1



ALCOTEX - MOUSE GREY







NORTEM - NORTHWOOD FLUTED PANEL - WALNUT



BRAMPTON BRICK - ECLIPSE SUAVE FINISH

SITE PLAN APPLICATION 2024 05 27 RESPONSE SITE PLAN APPLICATION 2023 05 28 RESPONSE SITE PLAN APPLICATION 2022 11 24 RESPONSE

> ISSUES/REVISIONS ALL DIMENSIONS TO BE CHECKED AND VERIFIED ON SITE. DISCREPANCIES TO BE REPORTED TO THE ARCHITECT. LATEST APPROVED STAMPED DRAWINGS

ONLY TO BE USED FOR CONSTRUCTION.

MICHAEL W. MCKNIGHT LICENCE ,,,, 3808

48 ALLIANCE BLVD., UNIT 110 BARRIE, ONTARIO L4M 5K3

PROJECT NAME:

T 705 722 6739 WWW.MCLARCHITECTS.CA

DRAWING TITLE:

**ELEVATIONS** 

8 STOREY CONDOMINIUM -INNISFIL 946, 950 INNISFIL BEACH RD, INNISFIL, ON

DATE: December 03, 2024 SCALE: As indicated

PROJECT #









SITE PLAN APPLICATION RESPONSE	2024 05 27
SITE PLAN APPLICATION RESPONSE	2023 05 28
SITE PLAN APPLICATION RESPONSE	2022 11 24
•	

ALL DIMENSIONS TO BE CHECKED AND VERIFIED ON SITE. DISCREPANCIES TO BE REPORTED TO THE ARCHITECT. LATEST APPROVED STAMPED DRAWINGS ONLY TO BE USED FOR CONSTRUCTION.



MCLARCHIECIS MCKNIGHT CHARRON LIMITED

48 ALLIANCE BLVD., UNIT 110 BARRIE, ONTARIO L4M 5K3 T 705 722 6739 WWW.MCLARCHITECTS.CA

DRAWING TITLE:
RENDERINGS

PROJECT NAME: 8 STOREY CONDOMINIUM -INNISFIL

946, 950 INNISFIL BEACH RD, INNISFIL, ON

 DATE:
 December 03, 2024
 PROJECT #

 DRAWN BY:
 LR
 22-1114

### **INNOVATIVE PLANNING SOLUTIONS**

planners • project managers • land development

#### 946-950 Innisfil Beach Road

Planning Justification Report
TOWN OF INNISFIL

APPLICATION FOR

#### **COMMITTEE OF ADJUSTMENT - MINOR VARIANCE**

PREPARED BY

#### INNOVATIVE PLANNING SOLUTIONS

647 Welham Road, Unit 9A Barrie, ON L4N 0B7 TEL: (705) 812-3281

FAX: (705) 812-3438

ON BEHALF OF

#### RYAN DECARIA-STOPAY & JOHN PAUL DECARIA-STOPAY

**JUNE 2025** 

PLANNING JUSTIFICATION REPORT IPS File No: 21-1047

946-950 INNISFIL BEACH ROAD

#### **TABLE OF CONTENTS**

1.0 INTRODUCTION	3
2.0 SUBJECT LANDS & SURROUNDING LAND USES	4
3.0 PROPOSED DEVELOPMENT	10
4.0 MINOR VARIANCE ANALYSIS	13
5.0 CONCLUSION	26

#### LIST OF FIGURES

Figure 1.	Subject I	Lands
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Figure 2. Land Use Designation

Figure 3. Zoning By-Law

Figure 4. Surrounding Uses

Figure 5. Site Plan Drawing

#### **LIST OF TABLES**

Table 1: Zoning By-law Table (MU2) zone

#### LIST OF APPENDICES

Appendix 1: SURVEY

Appendix 2: SITE PLAN DRAWING

Appendix 3: CONCEPTUAL ELEVATION DRAWINGS

#### 1.0 INTRODUCTION

Innovative Planning Solutions has been retained by Ryan Decaria-Stopay & John Paul Decaria-Stopay, to prepare a Planning Justification Report relative to a Minor Variance Application for lands municipally known as 946-950 Innisfil Beach Road in the Town of Innisfil.

The purpose of the subject application is to obtain Committee of Adjustment approval for Six (6) Minor Variances in order to permit the development of an 8 Storey, 58 residential unit & 195m<sup>2</sup> commercial space mixed-use building with associated parking structure and landscape areas. The requested variances for parking, building height including angular plane, rear and side yard setbacks, landscape buffer strip, and indoor amenity area are required in order to accommodate the proposed development as outlined further below.

#### 2.0 SITE DESCRIPTION & SURROUNDING LAND USES

The Subject Lands ('lands') are located at 946-950 Innisfil Beach Road (IBR) in the Town of Innisfil. The lands have an area of approximately 3,896m² with 44.46m of frontage along IBR (Arterial road classification) (**Figure 1**). The properties currently contain one (1) single detached dwelling, accessory sheds and vegetation along property borders on each property. Both 946 & 950 IBR will be merged in title to form one parcel of land to facilitate the proposed development. A copy of the legal survey is provided in **Appendix 1**.

The lands contain two designations, the majority are currently designated 'Downtown Commercial Area' abutting Innisfil Beach Road and 'Residential Low Density 1' at the rear of the Subject Lands under Schedule B1 (Land Use: Alcona) in the Town's Official Plan (**Figure 2**) The entire Subject Lands are zoned 'Mixed Use 2 (MU2) under the Town's Zoning By-law (**Figure 3**). The front portion of the subject site is located within the Lake Simcoe Region Conservation Authority (LSRCA) boundary and is subject to LSRCA regulations.

The lands are ideally positioned along the north side if IBR central to downtown Alcona, offering a variety of employment opportunities, commercial amenities, public services, and recreational open spaces. The site is also a short walk to Innisfil Beach Park and approximately 15 minutes from Highway 400 and the commercial/industrial areas abutting the Highway.

Uses in the surrounding area are shown in **Figure 4**, and include:

North: Lands designated 'Residential Low Density 1, consisting of Single detached


dwellings and accessory structures.


East: Lands designated 'Downtown Commercial Area' and 'Residential low Density 1' consisting of Commercial uses and amenities along with Single Detached Dwellings.


**South:** Lands designated 'Downtown Commercial Area' and 'Residential low Density 1' consisting of Commercial/institutional uses and amenities along with Single Detached Dwellings further south.


West: Lands designated 'Downtown Commercial Area' and 'Residential low Density 1' consisting of Commercial uses and amenities along with Single Detached Dwellings.



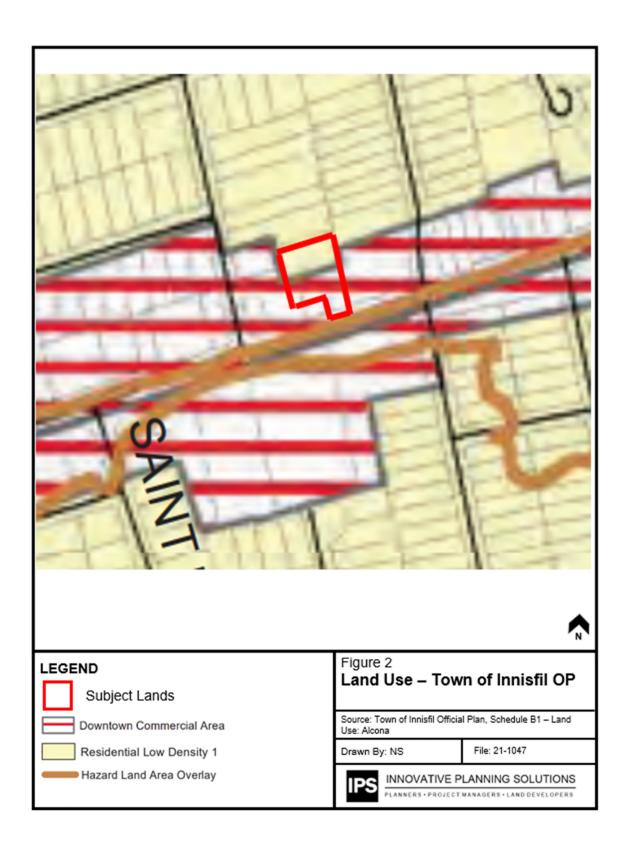

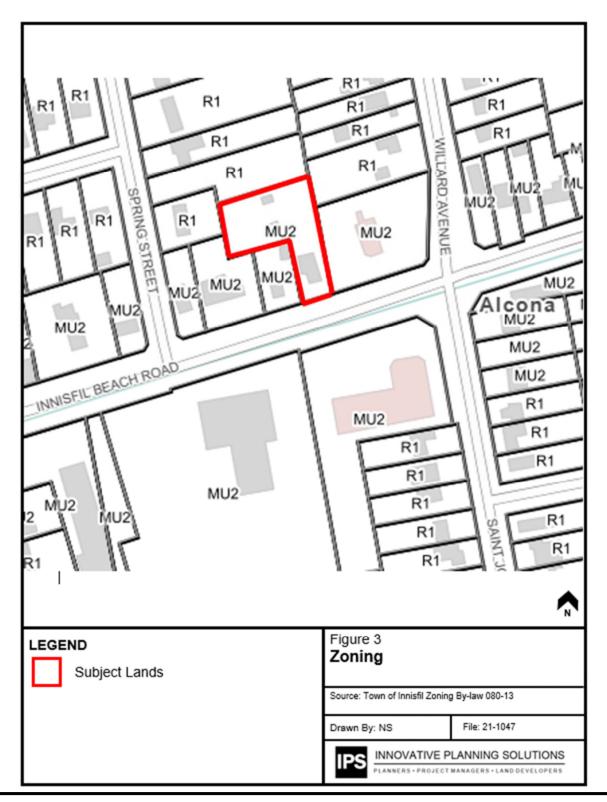

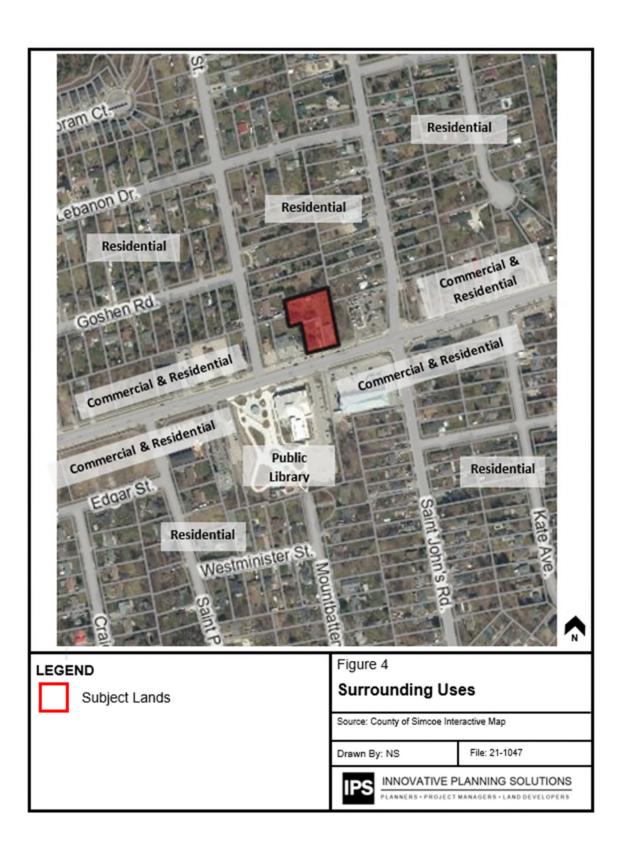

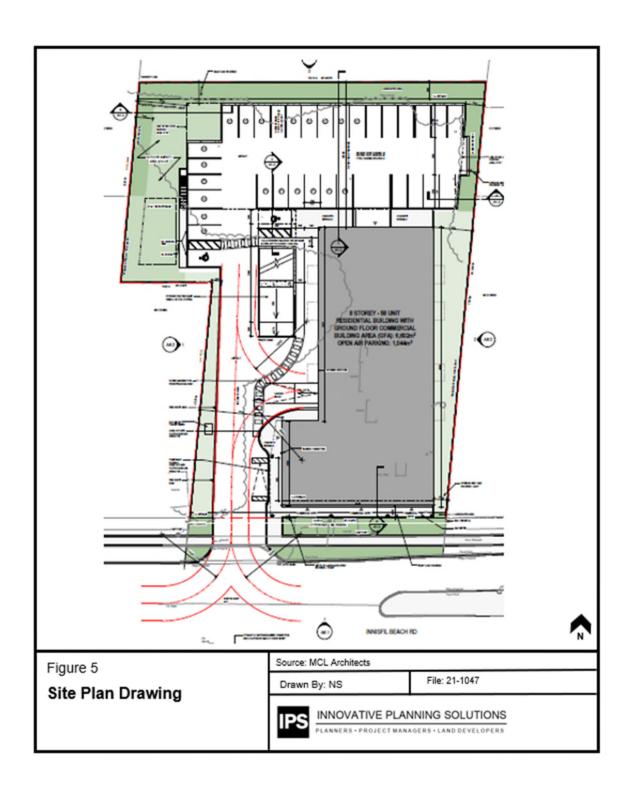

#### 3.0 PROPOSED DEVELOPMENT

The proposed Minor Variance application is intended to accommodate the development of an 8 Storey, 58 residential unit & 195 m<sup>2</sup> commercial space mixed-use building with associated parking structure and landscape areas on the Subject Lands. A copy of the Site Plan is included in **Appendix 2** of this report and conceptual elevation drawings are included in **Appendix 3**. Prior to development occurring, all structures will be demolished, and the two existing parcels will be merged into a single parcel of land.

The proposed common element condominium mixed-use development will provide a single vehicular access from IBR by way of an internal drive aisle which provides access to a two (2) level parking structure at the rear of the property. Parking is also provided within the building located on the ground & second floor and accessed at the rear. Residential, commercial and visitor parking is provided along with Barrier Free spaces. The 195 m² commercial space consisting of 3 commercial units is strategically located at the front of the building facing IBR accessible by a pedestrian walkway while pedestrian access to the residential lobby is provided along the west facing wall slightly behind the commercial space. The 58 residential units occupy floors three (3) to eight (8) in a one (1) to two (2) bedroom unit configuration. The proposal provides an outdoor common amenity area of 310 m², located in the northwest corner of the site. Landscape buffer strips border the site along the west, north, and east property lines to provide vegetative buffering in combination with fencing.

The proposal provides a total of ninety (90) parking spaces, fifteen (15) of which are visitor spaces, five (5) for commercial parking, including two (2) Type 'A' & two (2) Type 'B' barrier-free spaces. The two (2) level open air parking structure located at the rear of the property along with parking within the building on the ground floor and second floor provide convenient and accessible parking for the proposed development. Existing municipal infrastructure is available to service the proposed development including water, sanitary, and storm sewer. Garbage containment is located within the building.

The development proposal has been submitted for Site Plan Control and is currently finalizing the 4<sup>th</sup> submission to the Town and applicable commenting agencies for review.

A review of the proposed development against the Zoning By-law and current MU2 zone standards has been completed. Table 1 below identifies the various zoning provisions and how the development complies. The development will comply with all zoning provisions except for Six (6), highlighted below. Provisions highlighted in yellow are subject to this proposed Minor Variance application.

**Table 1. Zoning Requirement Analysis Table** 

MIXED-USE 2 (MU2) Zone			
Provision	Required	Provided	
Lot Area (min.)	1000m <sup>2</sup>	3,896 m <sup>2</sup>	
Lot Frontage (min.)	15m	44.46m	
Building frontage (min.)	<30m min. 60% >30m min. 50%	26.2m	
Front Yard (min.) Front Yard (max.)	1m 4m	1.9m	
Side yard (min.) East	0m or 7.5m with 45 degree angular plane abutting R1 zone	3.0m from parking structure and within 45 degree angular plane (49 degrees provided) from R1 zoned property (2124 Willard Avenue)  2.3m from mixed use building abutting MU2 zoned property, not subject to 45 degree angular plane	
Side Yard (min.) West	0m or 7.5m with 45 degree angular plane abutting R1 zone	8.6m from parking structure, not within 45 degree angular plane  14.4m from mixed use building abutting MU2	

		zoned property, not
		subject to 45 degree
		angular plane
		3.7m from parking
		structure and within 45
		degree angular plane
	7.5m with 45 degree	(48.8 degrees provided)
Rear Yard Setback (min.)		
	angular plane	25.18m from mixed use
		building and within 45
		degree angular plane
		(45.8 degrees provided)
Landscaped Open Space (min.)	N/A	31% of lot area
Landscape strip (min.) front yard	1 – 4m	0.2m
Landscape strip (min.) rear yard	3m	3m
Landagene etrin (min ) side yarde	0m	1.6m west
Landscape strip (min.) side yards		2.1m east
Lot Coverage (max.)	N/A	27%
Floor area per residential unit	47m²	+47m²
(min.)	47111	T4/III
	7.5m (min.)	OF Are within 4F dogge
Duilding Height	24m (max.) for mixed use	25.4m within 45 degree
Building Height	Subject to 45 degree	angular plane (45.8
	angular plane	degrees provided)
Density (max.)	N/A	158 UPH
	4m² per residential unit =	
	232m²	310m <sup>2</sup> (outdoor amenity)
Amenity Area (total min.)	2m² per residential unit =	+ 424m² (balconies)
Outdoor Amenity Area (min.)	116m <sup>2</sup>	,
Indoor Amenity Area (min.)	2m² per residential unit =	0 m <sup>2</sup> indoor amenity
	116m <sup>2</sup>	,
	3	

	1 space per 40m <sup>2</sup> of	
	commercial leasable area	5 commercial spaces
Parking (min.)	= (195m <sup>2</sup> ) 5 spaces	
Commercial &	1.5 spaces per residential	85 residential spaces
Residential	unit = (58 units) 87 spaces	Total parking = 90
	Total required parking =	<mark>spaces</mark>
	92 spaces	
	2 Type 'A' B.F. spaces	2 Type 'A' B.F. spaces
Barrier Free Parking (min.)	2 Type 'B' B.F. spaces	2 Type 'B' B.F. spaces
	4 total B.F. spaces	4 total B.F. spaces
	0.25 per residential unit,	
Visitor Parking (min )	included within residential	15 visitor spaces
Visitor Parking (min.)	parking total = 15 spaces	15 visitor spaces

### **4.0 MINOR VARIANCE ANALYSIS**

The Committee of Adjustment, under Section 45(1) of the Planning Act, may authorize a Minor Variance from the provisions of the Zoning By-law, subject to the following considerations, known as the four tests:

- 1. The variance maintains the general intent and purpose of the Official Plan;
- 2. The variance maintains the general intent and purpose of the Zoning By-law;
- 3. The variance is desirable for the development and use of the land; and,
- 4. The variance is minor in nature

In accordance with Section 45(1) of the Act, the subject application has been reviewed against the four tests with an analysis provided below, specifically as it relates to the following requested variances:

- Side yard setback and angular plane from R1 zone (east side yard) Section:
   Table 5.2.b.C
- 2. Rear yard setback and angular plane Section: Table 5.2.b.E
- 3. Building height maximum Section: Table 5.2.b.F
- 4. Front landscape strip Section: Table 5.2.b.
- 5. Indoor amenity space Section: Table 5.2.b.Note 6
- 6. Residential parking space Section:3.35.1.1.d

### 4.1 Does the variance maintain the general intent and purpose of the Town of Innisfil Official Plan?

The subject lands are located within a Primary Settlement Area (Alcona) as per section 9.2 and designated 'Downtown Commercial Area' in the Town of Innisfil's Official Plan ('The Plan'). Primary Settlement Area – "Particular focus shall be given to creating and maintaining vibrant public spaces in the Downtown Commercial Area with a strong pedestrian and built form connection between the Downtown and Innisfil Beach Park along Innisfil Beach Road". Although a small area at the rear of the property is designated 'Residential Low Density 1' and does not contain the mixed-use building within this designation, this report will focus on the 'Downtown Commercial Area' designation of the Official Plan relative to the proposed development and requested minor variances. Within the Downtown Commercial Area designation mixed-use buildings are permitted and promote commercial uses on the ground floor areas fronting IBR and residential uses above. In addition, The Plan encourages infill and intensification and will be directed to the delineated Built-up Areas of Alcona and focused in Strategic Growth Areas. The requested variances are noted below with rational based on the proposal aligning with the general intent and purpose of the Town's Official Plan.

No.	Variance Requested	Rational Based on Proposal
1	Side yard setback and angular plane from R1 zone (east side yard) – Section: Table 5.2.b.C	As outlined in section 11.1.9 of the OP, 45 degree angular planes provide a gradual transition between Mixed Use buildings and low density residential. Similarly, setback provisions provide additional separation from property lines and structures. The proposed two (2) level parking structure is located within the angular plane when abutting a low density residential property, municipally known as 2124 Willard Avenue. The parking structure is constructed with open air which reduces building impacts to abutting lands while only being slightly within the 45 degree angular plane

		provision (49 degrees). The additional setback and angular plane requirements are only a result of mixed use properties abutting low density residential property thus, the only structure affecting this policy is the two (2) level parking structure. Section 11.1.10 of the OP contains polices for screening to residential uses. The two (2) level parking structure provides architectural features to screen vehicular headlines from abutting residential properties while allowing adequate space for additional vegetative screening. As proposed, the reduced side yard setback abutting low density residential lands and slight projection into the 45 degree angular plane along with architectural/vegetative features adhere to OP policies.
2	Rear yard setback and angular plane – Section: Table 5.2.b.E	Similarly to above, section 11.1.9, 11.1.18, & 11.2.7 of the OP identify policies that require transition from mixed use developments when abutting low density lands. Again the reduction in rear setback for the two (2) level parking structure is considered acceptable as architectural/vegetative features buffer the parking structure from residential lands. The 45 degree angular plane is only slightly impacted by the proposed height of the building (0.8 degrees) from the rear yard by the roof parapet and mechanical enclosure. As proposed, the development generally aligns with these policies.
3	Building height maximum  – Section: Table 5.2.b.F	The proposed development aligns with section 11.2.6 of the OP, such that the proposed building is 8 storeys in height. The additional height request is to address the roof top parapet and mechanical structures. The proposed development provides adequate transition to low density residential lands and does not conflict with section 11.6.7 of the OP. As proposed, the development generally aligns with these polices and takes into account transitional provisions from low density residential lands while promoting intensification. See architectural drawing package for illustrations of the elevations and angular plane.
4	Front landscape strip – Section: Table 5.2.b.	The proposed building location, orientated close to IBR, minimizes the front yard landscape area. This allows convenient pedestrian connections in a pedestrian first design, that align with OP policies within sections 11.1.3, 11.1.12, 11.1.13, & 11.1.15. Additional front landscape features can be provided on the municipal boulevard to further enhance the front façade area.
5	Indoor amenity space – Section: Table 5.2.b.Note 6	Due to building design including commercial space and parking areas located within the building on the ground and second floors, indoor amenity space is not proposed for this development. This does not conflict with OP policies. It can be noted that the development provides increased outdoor amenity area and private balconies provide ample amenity space for residence.
6	Residential parking space  – Section:3.35.1.1.d	The reduction of residential parking request does not negatively affect OP policies within sections 11.1.23, 11.1.25, 11.1.29, & 11.1.30. The proposed parking areas are located away from streets and effectively screened from abutting lands while providing adequate residential parking for the proposed dwellings. The proposed parking reduction does not negatively impact OP policies and the general intent of the OP is maintained.


Based on the above, the requested variances are in keeping with the general intent and purpose of the Town's Official Plan.

# 4.2 Does the application conform to the general intent of the Town of Innisfil's Zoning By-Law?

The proposed development is located with the Mixed-Use Two zone classification within the Town of Innisfil's Zoning By-law 080-13. Within the MU2 zone, mixed-use buildings are listed as permitted uses. Aside from the requested six (6) Minor Variances, the proposed development meets all other requirements of the MU2 zone. The requested variances are noted below with rational based on the proposal aligning with the general intent and purpose of the Town's Zoning By-law.

No.	Variance	Rational Based on Proposal
	Requested	
1	Side yard setback and angular plane from R1 zone (east side yard) – Section: Table 5.2.b.C	The Zoning By-law, in Table 5.2.b.C. for minimum interior side yard setback and angular plane, states: 0 m or 7.5 m and subject to the 45 degree angular plane (2) where the interior side yard abuts an R1 Zone.  With respect to interior side yard setbacks for MU2 zones when abutting Residential One (R1) zones the above noted section of the zoning bylaw applies. For lots within a MU2 zone the 7.5m setback and angular plane are not required. The location of the proposed mixed-use building is abutting a MU2 zoned lot (east lot line) municipally know as 940 Innisfil Beach Road. Therefore the setback of the mixed use building does not conflict with the zoning provision. The property municipally known as 2124 Willard Avenue is zoned R1 and the zoning provision noted above would apply to the east property line abutting the two (2) level open air parking structure. The proposed east side yard setback abutting the R1 zone is 3 metres compared to a required 7.5 metre setback resulting in a variance of 4.5 metres. The 45 degree angular plane applies in additional to the side yard setback provision. The two (2) level, open air, parking structure is slightly within the 45 degree angular plane (49 degrees proposed) as illustrated within the architectural drawing package (image provided below). The purpose of the zoning provision is to provide separation distance from R1 zoned properties to structures and allow for buffering to occur in the form of fencing, vegetation, and or architectural features. The proposed upper level of the parking structure provides an architectural feature to buffer vehicular headlights from abutting properties. The second level of the parking structure does not propose a roof to minimize structural impacts to abutting lands which reduces overall height in the rear and side yards. An opaque fence in conjunction with vegetative buffering add to decrease visual obstructions and soften views from adjoining residential lots. The

3 metre landscape strip provides ample area to allow for vegetative buffering to occur that will naturally buffer the parking structure from residential rear yard amenity areas. For these reasons, the proposed reduction of the interior side yard setback and angular plane abutting a R1 zone are in keeping with the general intent of the Zoning By-law.

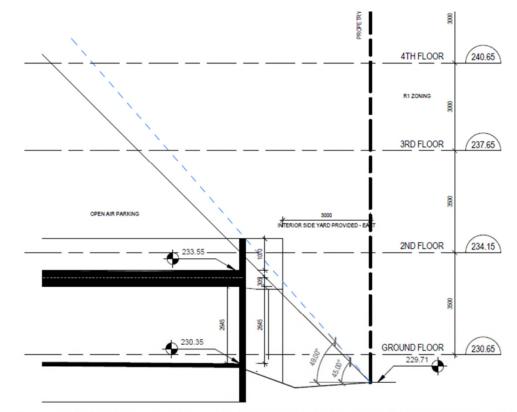


SECTION - ANGULAR PLANE EAST INTERIOR SIDE YARD
1:100

Rear yard setbackand angular planeSection: Table5.2.b.E

The Zoning By-law, in Table 5.2.b.E. for minimum rear yard setback and angular plane, states: 7.5 m and subject to the 45 degree angular plane.

Similar to the above requested variance for east side yard setback, the rear yard setback and angular plane are intended to provide a buffer from structures when abutting a R1 zone. The property municipally known as 2125 Spring Street is zoned R1 and abuts the entire rear yard of the Subject Lands. The requested rear yard variance applies only to the two (2) level open air parking structure proposed at 3.7 metres from the rear property line. Similar to above, the landscape strip of 3.7 metres allows for ample area for vegetive buffering along with an opaque fence. The second level architectural feature surrounding the perimeter of the parking structure further buffers vehicular headlights from impacting abutting properties. Due to the 3.7 metre setback, the parking structure does not impact the 45 degree angular plane however the architectural feature surrounding the perimeter of the parking structure encroaches into the 45 degree angular plane (48.8 degrees or 3.8 degrees difference), see below image. The 45 degree

angular plane does intersect the mixed use building height resulting in a variance request to the 45 degree angular plane (45.8 degrees proposed). The angular plane intersects the mixed use building above the roof line. The resulting variance is due to the roof parapet height and mechanical structure used to buffer mechanical equipment from view. It can be noted that the mixed use building is located as close as possible to the front property line resulting in a large 25.18 metre rear yard setback. The proposed rear yard setback for the two (2) level open air parking structure and mixed use building, including buffering elements, abutting a R1 zone are in keeping with the general intent of the Zoning By-law.

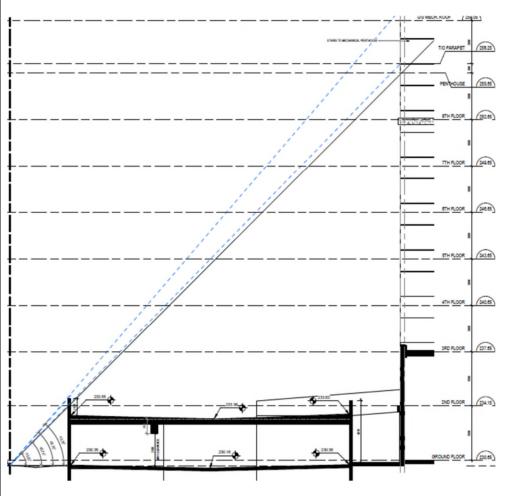

Building height maximum – Section: Table 5.2.b.F

The Zoning By-law, in Table 5.2.b.F. for maximum building height, states: 24 m for mixed use, and subject to the 45 degree angular plane. This provision takes into account the 45 degree angular plane from the rear yard and limits the maximum height from average grade to the top of the parapet wall. The proposed maximum height of the mixed-use building is 25.4m, resulting in a 1.4m variance request for overall height. As noted above, the 45 degree angular plane from the rear yard is slightly impacted (0.8 degrees) and the roof top mechanical structures does not contribute towards maximum height as defined by the Zoning Bylaw. The increased height request is due to ground and second floor parking structure

		ceiling heights within the building to accommodate vehicular and mechanical features. Overall, the height of the building does not impact the intent of the Zoning Bylaw to permit mixed use buildings through a variance that accommodates design features for covered parking areas and increase ceiling heights for commercial uses on the ground floor area. For these reasons the intent of the Zoning Bylaw is satisfied.
4	Front landscape strip – Section: Table 5.2.b.	The Zoning By-law, in Table 5.2.b. for minimum front yard landscape strip, states: 1 – 4m setback and Note 5 states: The required landscaping will correspond to the setback provided. The Zoning Bylaw provision for a front yard landscape strip is flexible with respect to the building location. To ensure the proposed mixed-use building is places as close as possible to IBR, the landscape strip along the frontage of the Subject Lands is reduced to 0.2 metres. As the building location is to align with Official Plan polices, it was determined that a covered walkway to provide pedestrian access would be preferred over a vegetated landscape strip. This results in a 0.8 metre variance request which aligns with Official Plan polices to have street facing buildings that function with a pedestrian first feel.
5	Indoor amenity space – Section: Table 5.2.b.Note 6	The Zoning By-law, in Table 5.2.b. Note 6 for minimum indoor amenity spaces, states: <i>4 m2 per residential unit</i> and Note 6 states: <i>Units shall have amenity space provided at a minimum rate of 4 m2 per unit, of which: a minimum of 2 m2 per unit shall be indoor amenity space; a minimum of 40 m2 shall be outdoor amenity space in a location adjoining or directly accessible to the indoor amenity space. The combination of ground floor commercial and first and second floor parking within the building limits the ability to provide for indoor amenity space. For this reason, the outdoor amenity space exceeds the Zoning Bylaw requirement to provide residential amenity for occupants (310m² proposed). Furthermore, each residential unit contains personal private amenity space on each balcony adding to the overall available amenity space. This aligns with the general intent of the Zoning Bylaw.</i>
6	Residential parking space – Section:3.35.1.1.d	The Zoning By-law, in section 3.35.1.1.d for minimum residential parking spaces, states: 1.5 parking spaces per dwelling unit, of which 0.25 parking spaces shall be designated as visitor parking spaces. For a 58 residential unit use, 87 residential parking spaces are required at a parking calculation of 1.5 spaces per unit. The site is providing 85 parking space dedication for the residential use including 15 visitor parking spaces. This results in two (2) deficient parking spaces and a parking calculation of 1.46 spaces per unit. The intent of the Zoning Bylaw is to facilitate adequate parking for proposed uses. The reduction of 2 spaces is appropriate given the design restriction of the site and the ability to provide additional parking that would negatively impact landscape buffer strips and outdoor amenity areas. For these reasons together with additional justification within the Traffic Brief provided by JD Engineering, the intent of the Zoning Bylaw is satisfied.

Based on the above, the requested variances are in keeping with the general intent and purpose of the Town's Zoning By-law 080-13.

# 4.3 Is it desirable for the appropriate development or use of the land, building or structure?

No.	Variance Requested	Rational Based on Proposal
1	Side yard setback and angular plane from R1 zone (east side yard) – Section: Table 5.2.b.C	The Zoning By-law variance for a 7.5m setback and subject to the 45 degree angular plane is only requested abutting the property municipally known as 2124 Willard Avenue. The variance of a 3 metre setback and slightly within the 45 degree angular plane (49 degrees proposed) as illustrated in the east interior side yard elevation is for the two (2) level parking structure. The parking structure is designed to be low impact to abutting properties through an open air design the minimizes building massing close to the property line. The second level architectural feature along the perimeter buffers vehicle headlights from impact abutting properties. For a Mixed-Use zone classification abutting low density residential, care is taken to ensure the proposal minimizes building massing and placement. The design allows for a transition from mixed use zones to residential zones while still maintaining appropriate forms of higher density developments. The two (2) level parking structure is necessary to facilitate the proposed mixed use building and is an appropriate from of development in the mixed-use zone classification.
		SECTION - ANGULAR PLANE EAST INTERIOR SIDE YARD  4TH FLOOR (240.65)  ATH FLOOR (237.65)  ATH FLOOR (237.65

2	Rear yard setback and angular plane – Section: Table 5.2.b.E	Similar to the above requested variance for east side yard setback, the rear yard setback and angular plane are intended to provide a buffer from structures when abutting a R1 zone. The two (2) level parking structure is an appropriate from of design to facilitate the proposed development and allow for increased visual buffering through vegetative plantings from residential properties. The placement of the proposed 8 storey mixed-use main structure has been located as close as possible to the street allowing for an increased distance from the rear property line. The 45 degree angular plane is slightly impacted by the height of the building (0.8 degrees) however, the placement of the structure is appropriate given the 25.18 metre rear yard setback from residential properties.
3	Building height maximum  – Section: Table 5.2.b.F	The Zoning By-law, in Table 5.2.b.F. for maximum building height, states: 24 m for mixed use, and subject to the 45 degree angular plane. This provision takes into account the 45 degree angular plane from the rear yard and limits the maximum height from average grade to the top of the parapet wall. The increased height request is due to ground and second floor parking structure ceiling heights within the building to accommodate vehicular and mechanical features. Given the proposed design and property layout, the proposed height increase takes into account the Subject Land location along IBR and aligns with overall mixed-use policy objectives for intensification.
4	Front landscape strip – Section: Table 5.2.b.	The placement of the structure as close to IBR as possible results in a reduced front yard landscape strip along the Subject Land frontage. This results in increased rear yard setbacks when abutting residential properties and allows for a pedestrian first connection to a transit orientated arterial roadway (IBR). Architectural features assist with framing the property along IBR, assisting in the creation of a streetscape design inline with Town visions of Alcona for properties fronting IBR. The reduction in front landscape strip requirements are appropriate for this area to allow for the building placement to be close to the property frontage and allow for parking to be placed in the rear yard.
5	Indoor amenity space – Section: Table 5.2.b.Note 6	As a result of building design, the indoor amenity space of 116m² is not provided. Commercial and parking areas occupy the majority of the ground floor area along with mechanical rooms and waste disposal areas. It was determined that ground floor street facing commercial space is necessary for mixed-use designs. It is also noted that Alcona Library is across IBR from the subject lands that offers residents and public indoor amenity space that contributes to overall community building initiatives. This aligns with the appropriate building design for the Subject Lands.
6	Residential parking space  – Section:3.35.1.1.d	For a 58 residential unit use, 87 residential parking spaces are required at a parking calculation of 1.5 spaces per unit. The site is providing 85 parking space dedication for the residential use including 15 visitor parking spaces. This results in two (2) deficient parking spaces and a parking calculation of 1.46 spaces per unit. As noted above, the design of the parking areas within the two (2) level open air parking structure and two (2) level parking areas within the building can accommodate the

residential units and meet the visitor parking requirement. It is also noted that pedestrian access to commercial amenities is within close proximity to the subject site reducing the need for vehicular usage. Transit options are readily available with convenient access to the site from the arterial
roadway. For these reasons, together with further justification contained within the Traffic Brief completed by JD Engineering, the design and structure are appropriate for the reduction in residential parking spaces and is in keeping with the general intent of the surrounding area.

Based on the above, the requested variances are in keeping with the general intent of the surrounding area and are appropriate for the proposed use and building.

### 4.4 Is the application minor in nature?

No.	Variance Requested	Rational Based on Proposal
1	Side yard setback and angular plane from R1 zone (east side yard) – Section: Table 5.2.b.C	The Zoning By-law, in Table 5.2.b.C. for minimum interior side yard setback and angular plane, states: 0 m or 7.5 m and subject to the 45 degree angular plane (2) where the interior side yard abuts an R1 Zone.  The proposed reduction in side yard setback (east) of 4.5 metres and slight structural (two level parking structure) encroachment into the 45 degree angular plane (49 degrees proposed) from abutting residentially zoned properties is considered minor due to the inclusion of opaque fencing, vegetative buffering, and architectural features that assist with buffering the proposed development. The provided landscape buffer strip, as illustrated in the landscape plan provided by Landmark Environmental, along the east property line abutting the parking structure allows for an adequate planting area for medium calibre vegetation, see provided landscape plans as part of the submission package. The combination of these elements considered, the proposed variance is considered minor in nature.
2	Rear yard setback and angular plane – Section: Table 5.2.b.E	The Zoning By-law, in Table 5.2.b.E. for minimum rear yard setback and angular plane, states: 7.5 m and subject to the 45 degree angular plane.  The proposed reduction in rear yard setback (north) of 3.8 metres and slight (main building) encroachment into the 45 degree angular plane (45.8)

		degrees proposed) for the main building and architectural feature surrounding the upper level parking structure (48.8 degrees proposed), can be considered minor in nature. This is due to the vegetative buffering along the rear property line to assist with screening of the parking structure, as illustrated in the landscape plan provided by Landmark Environmental, and the large rear yard setback of 25.18 metres to the main building. The slight encroachment into the 45 degree angular plane (0.8 degrees) poses little to no impact in relation to the rear yard residential properties. The rear yard setback reduction and angular plane encroachment is to facilitate a parking structure that utilizes an open air design to reduce structural impacts to abutting lands. This, combined with architectural screening around the perimeter of the second level minimizes vehicular headlight impacts to abutting properties and is further buffered through the use of vegetation. The combination of these elements considered, the proposed variance is considered minor in nature.
3	Building height maximum	The Zoning By-law, in Table 5.2.b.F. for maximum building height, states:
	- Section: Table 5.2.b.F	24 m for mixed use, and subject to the 45 degree angular plane.
		The requested height variance of 1.4 metres for a maximum building height of 25.4 metres is considered minor in nature as the design of the building incorporates parking levels within the building on the ground and second floor. This is due to high water tables found along IBR and on this property which restrict below ground parking design options. The building design also reduces the overall proposed height by minimize the height of the parapet and the inclusion of all mechanical equipment within a wholly enclosed structure on the roof. To note, the mechanical building is not included within the building height as defined within the Zoning Bylaw. By placing the building as close to the street as possible and away from residential properties, the proposed height and the slight encroachment into the 45 degree angular plan is considered minor in nature.
4	Front landscape strip -	The Zoning By-law, in Table 5.2.b. for minimum front yard landscape strip,
	Section: Table 5.2.b.	states: 1 – 4m setback and Note 5 states: The required landscaping will
		correspond to the setback provided.
		The proposed 0.2 metre front yard landscape strip resulting in a 0.8 metre variance request is considered minor in nature to allow for pedestrian first access to ground floor commercial areas. It is noted that the existing municipal boulevard area is available for increased vegetative elements that assist with an attractive building façade. Through the Site Plan Control process, design of vegetative elements are being considered by staff and are dependant on municipal infrastructure. The reduction of the front yard landscape strip does not negatively affect the building or site design and is considered minor in nature.

Indoor amenity space -The Zoning By-law, in Table 5.2.b. Note 6 for minimum indoor amenity Section: Table 5.2.b.Note spaces, states: 4 m2 per residential unit and Note 6 states: Units shall have 6 amenity space provided at a minimum rate of 4 m2 per unit, of which: a minimum of 2 m2 per unit shall be indoor amenity space; a minimum of 40 m2 shall be outdoor amenity space in a location adjoining or directly accessible to the indoor amenity space. As a result of building design to accommodate commercial and parking areas, the availability of providing indoor amenity space is not possible. To offset the zoning deficiency, additional outdoor amenity space is provided exceeding the Zoning Bylaw requirements (116m<sup>2</sup> required, 310m<sup>2</sup> proposed) to provide residents with private amenity for their enjoyment. Due to the proximity of the development site, available community indoor amenity options are available within walking distance providing further flexibility to occupants. The resulting variance is considered minor in nature due to the design restrictions and close proximity to additional amenities within the surrounding area. 6 Residential parking space The Zoning By-law, in section 3.35.1.1.d for minimum residential parking - Section: 3.35.1.1.d spaces, states: 1.5 parking spaces per dwelling unit, of which 0.25 parking spaces shall be designated as visitor parking spaces. The site is providing 85 parking space for 58 residential units including 15 visitor parking spaces. This results in two (2) deficient parking spaces and a parking calculation of 1.46 spaces per unit. The reduced parking does not impact the ability to provide a minimum of 1 parking space dedicated for each residential unit and provide ample parking for visitors. To increase additional variances for landscape buffer areas as a result of increasing parking spaces to meet Bylaw requirements is not appropriate to allow for a functional design. Rather, reducing parking spaces by two (2) allows for healthy landscape buffer areas to be provided while maintaining overall site continuity. Allowing for healthy vegetative buffer strips abutting residential properties assist with reducing development impacts and increasing greenery. The site contains a high-water table which limits the ability to provide additional parking below grade. For these reasons as well as further justification provided in the Traffic Brief as part of the submission package, the reduction in parking can be considered minor in nature.

Based on the above, the requested variances are considered minor in nature.

### 5.0 Conclusion

This report explores the merits of the proposed development as it relates to applicable planning policy, for lands located at 946 & 950 Innisfil Beach Road in the Town of Innisfil.

The purpose of this application is to obtain approval for six (6) Minor Variances in order to permit the development of an 8 Storey, 58 residential unit & 195m² commercial space mixed-use building with associated parking structure and landscape areas. The requested variances for parking, building height including angular plane, rear and side yard setbacks, landscape buffer strip, and indoor amenity area are required in order to accommodate the proposed development.

It is our professional opinion that the proposed Minor Variances satisfy the four tests under the Planning Act while demonstrating consistency with and conformity to the applicable Provincial and Municipal planning policies and objectives, representing good planning.

Respectfully submitted,

**Innovative Planning Solutions** 

**Nick Skerratt** 

Senior Planner


Darren Vella, MCIP, RPP,

President & Director of Planning


### **APPENDICIES**

#### **APPENDIX 1**

**LEGAL SURVEY** 

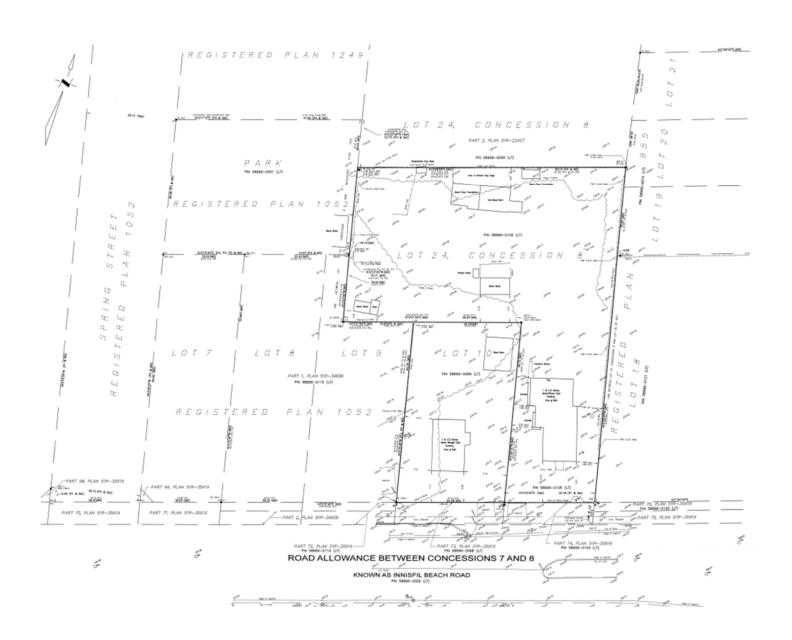



# APPENDIX 2 SITE PLAN DRAWING

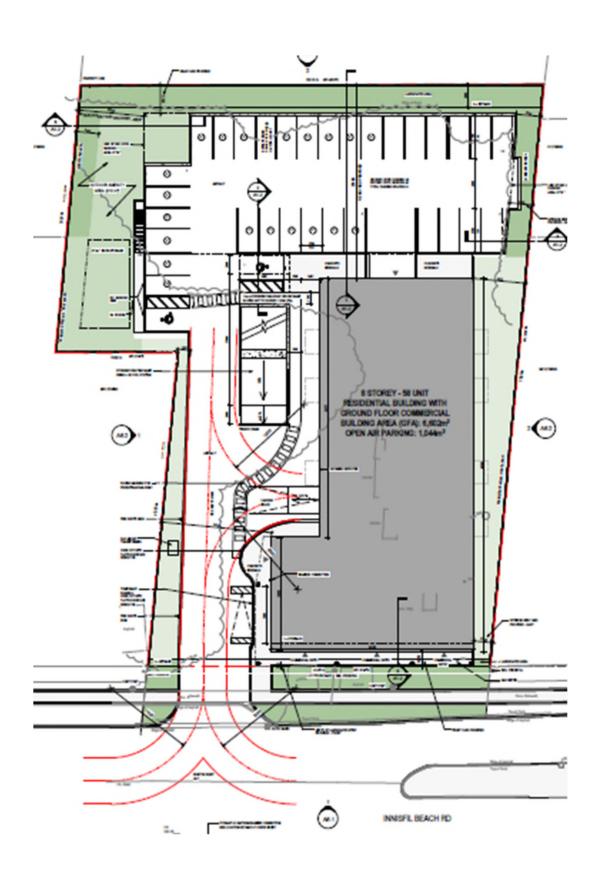


# APPENDIX 3 CONCEPTUAL ELEVATION DRAWINGS



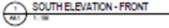

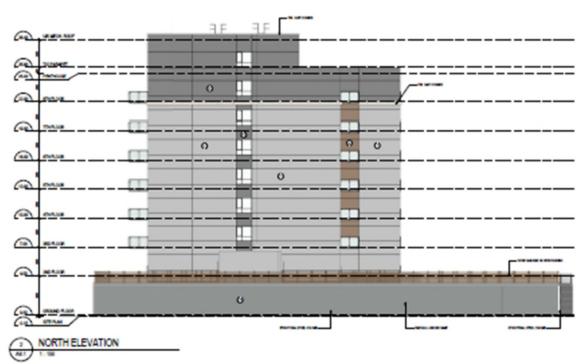

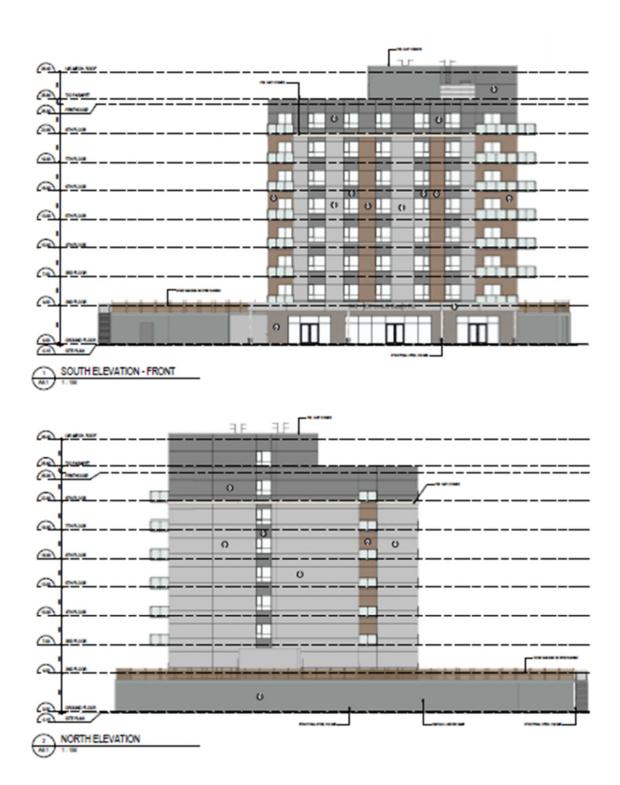











NOTES

ARE REQUIRED PRIOR TO ANY EXCAVATION WORK.

SURVEYOR'S

LOT 10, REGISTERED PLAN 1052 GEOGRAPHIC TOWNSHIP OF INNISFIL

SURVEYOR'S REAL PROPERTY REPORT PART 2 - REPORT SUMMARY

- PART OF LOT 24, CONCESSION 8, AND PART OF LOT 10, REGISTERED PLAN 1052, GEOGRAPHIC TOWNSHIP OF INNISFIL

REGISTERED EASEMENTS AND/OR RIGHTS OF WAY: COMPLIANCE WITH MUNICIPAL ZONING BY-LAWS:

THIS REPORT WAS PREPARED FOR JOHN PAUL STOPAY AND RYAN DECARIA-STOPAY AND THE UNDERSIGNED ACCEPTS NO

BEARINGS ARE UTM GRID, DERIVED FROM OBSERVED REFERENCE POINTS A AND B BY REAL TIME NETWORK OBSERVATIONS AND ARE REFERRED TO THE CENTRAL MERIDIAN 81°W, ZONE 17 BASED ON NAD 83 CSRS

MULTIPLYING BY THE COMBINED SCALE FACTOR OF 0.9997346

OBSERVATIONS USING THE CAN-NET VRS NETWORK, UTM ZONE 17
NAD 83 CSRS (2010 EPOCH)
COORDINATES TO URBAN ACCURACY PER SEC. 14 (2) OF O.REG. 216/10 615727.30

615827.87

CORNERS OR BOUNDARIES SHOWN ON THIS PLAN.

ELEVATIONS SHOWN HEREON ARE GEODETIC AND ARE DERIVED FROM GNSS OBSERVATIONS USING THE CAN—NET VRS NETWORK.
OBSERVATIONS ARE RELATED TO THE CGVD28 DATUM BY USING THE HT2\_0 GEOID MODEL.

DISTANCES AND COORDINATES SHOWN HEREON ARE IN METRES AND CAN BE CONVERTED TO FEET BY DIVIDING BY 0.3048.

DENOTES PLAN OF SURVEY BY ROBERT P. LEEPER ONTARIO LAND SURVEYOR, DATED JULY 10, 1975

PLAN OF SURVEY BY ROGER R. WELSMAN, ONTARIO LAND SURVEYOR, DATED JULY 20, 1964 S SURVEY MONUMENT FOUND DENOTES SURVEY MONUMENT SET

ADDITION TOPOGRAPHIC FEATURES ON SOUTH SIDE WERE ADDED TO THIS PLAN AUGUST 31, 2022. FIELD WORK FOR THE ADDITIONAL TOPO FEATURES WAS COMPLETED AUGUST 17, 2022.

THIS SURVEY AND PLAN ARE CORRECT AND IN ACCORDANCE WITH THE SURVEYS ACT, THE SURVEYORS ACT AND THE REGULATIONS MADE UNDER THEM.

2. THE SURVEY WAS COMPLETED ON THE 17th DAY OF AUGUST, 2022

RODNEY H. GEYER ONTARIO LAND SURVEYOR

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OCTOBER 20, 2022

RODNEY GEYER ONTARIO LAND SURVEYOR INC. 180 PARSONS ROAD, UNIT 29 ALLISTON, ONTARIO L9R 1E8 PHONE (705) 434-0411 www.geyersurveys.com


21-3381-SRPR-1

# 946-950 INNISFIL BEACH ROAD, INNISFIL, ON

MUNICIPAL FILE: SP-2021-018

LANDMARK ENVIRONMENTAL GROUP LTD.

PROJECT NO. LA 596-21

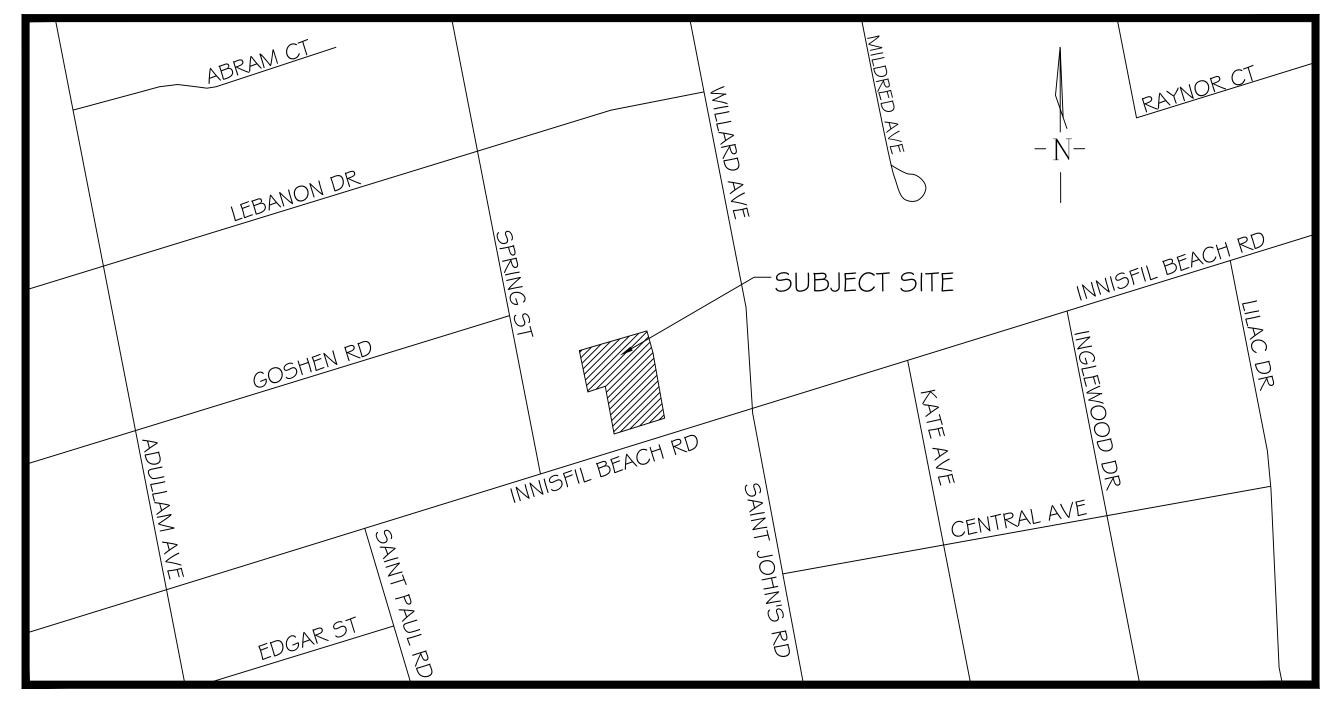

### KEY PLAN N.T.S.

### DRAWING LIST:

EX-I EXISTING CONDITIONS

TP-I TREE PRESERVATION PLAN I

TP-2 TREE PRESERVATION PLAN 2

L- I LANDSCAPE PLAN LD- I DETAILS I

LD-2 DETAILS 2 LD-3 DETAILS 3

CLIENT:

ROCH DEVELOPMENTS

7850 TRANMERE DRIVE MISSISSAUGA, ON L5S 1L9 MUNICIPALITY:



TOWN OF INNISFIL 2101 INNISFIL BEACH ROAD INNISFIL, ON

L95 IAI


LANDSCAPE ARCHITECT:



LANDSCAPE ARCHITECTS & CONSULTING ARBORISTS

OFFICE: 705-796-1122

info@LEGroupLtd.com www.LEGroupLtd.com

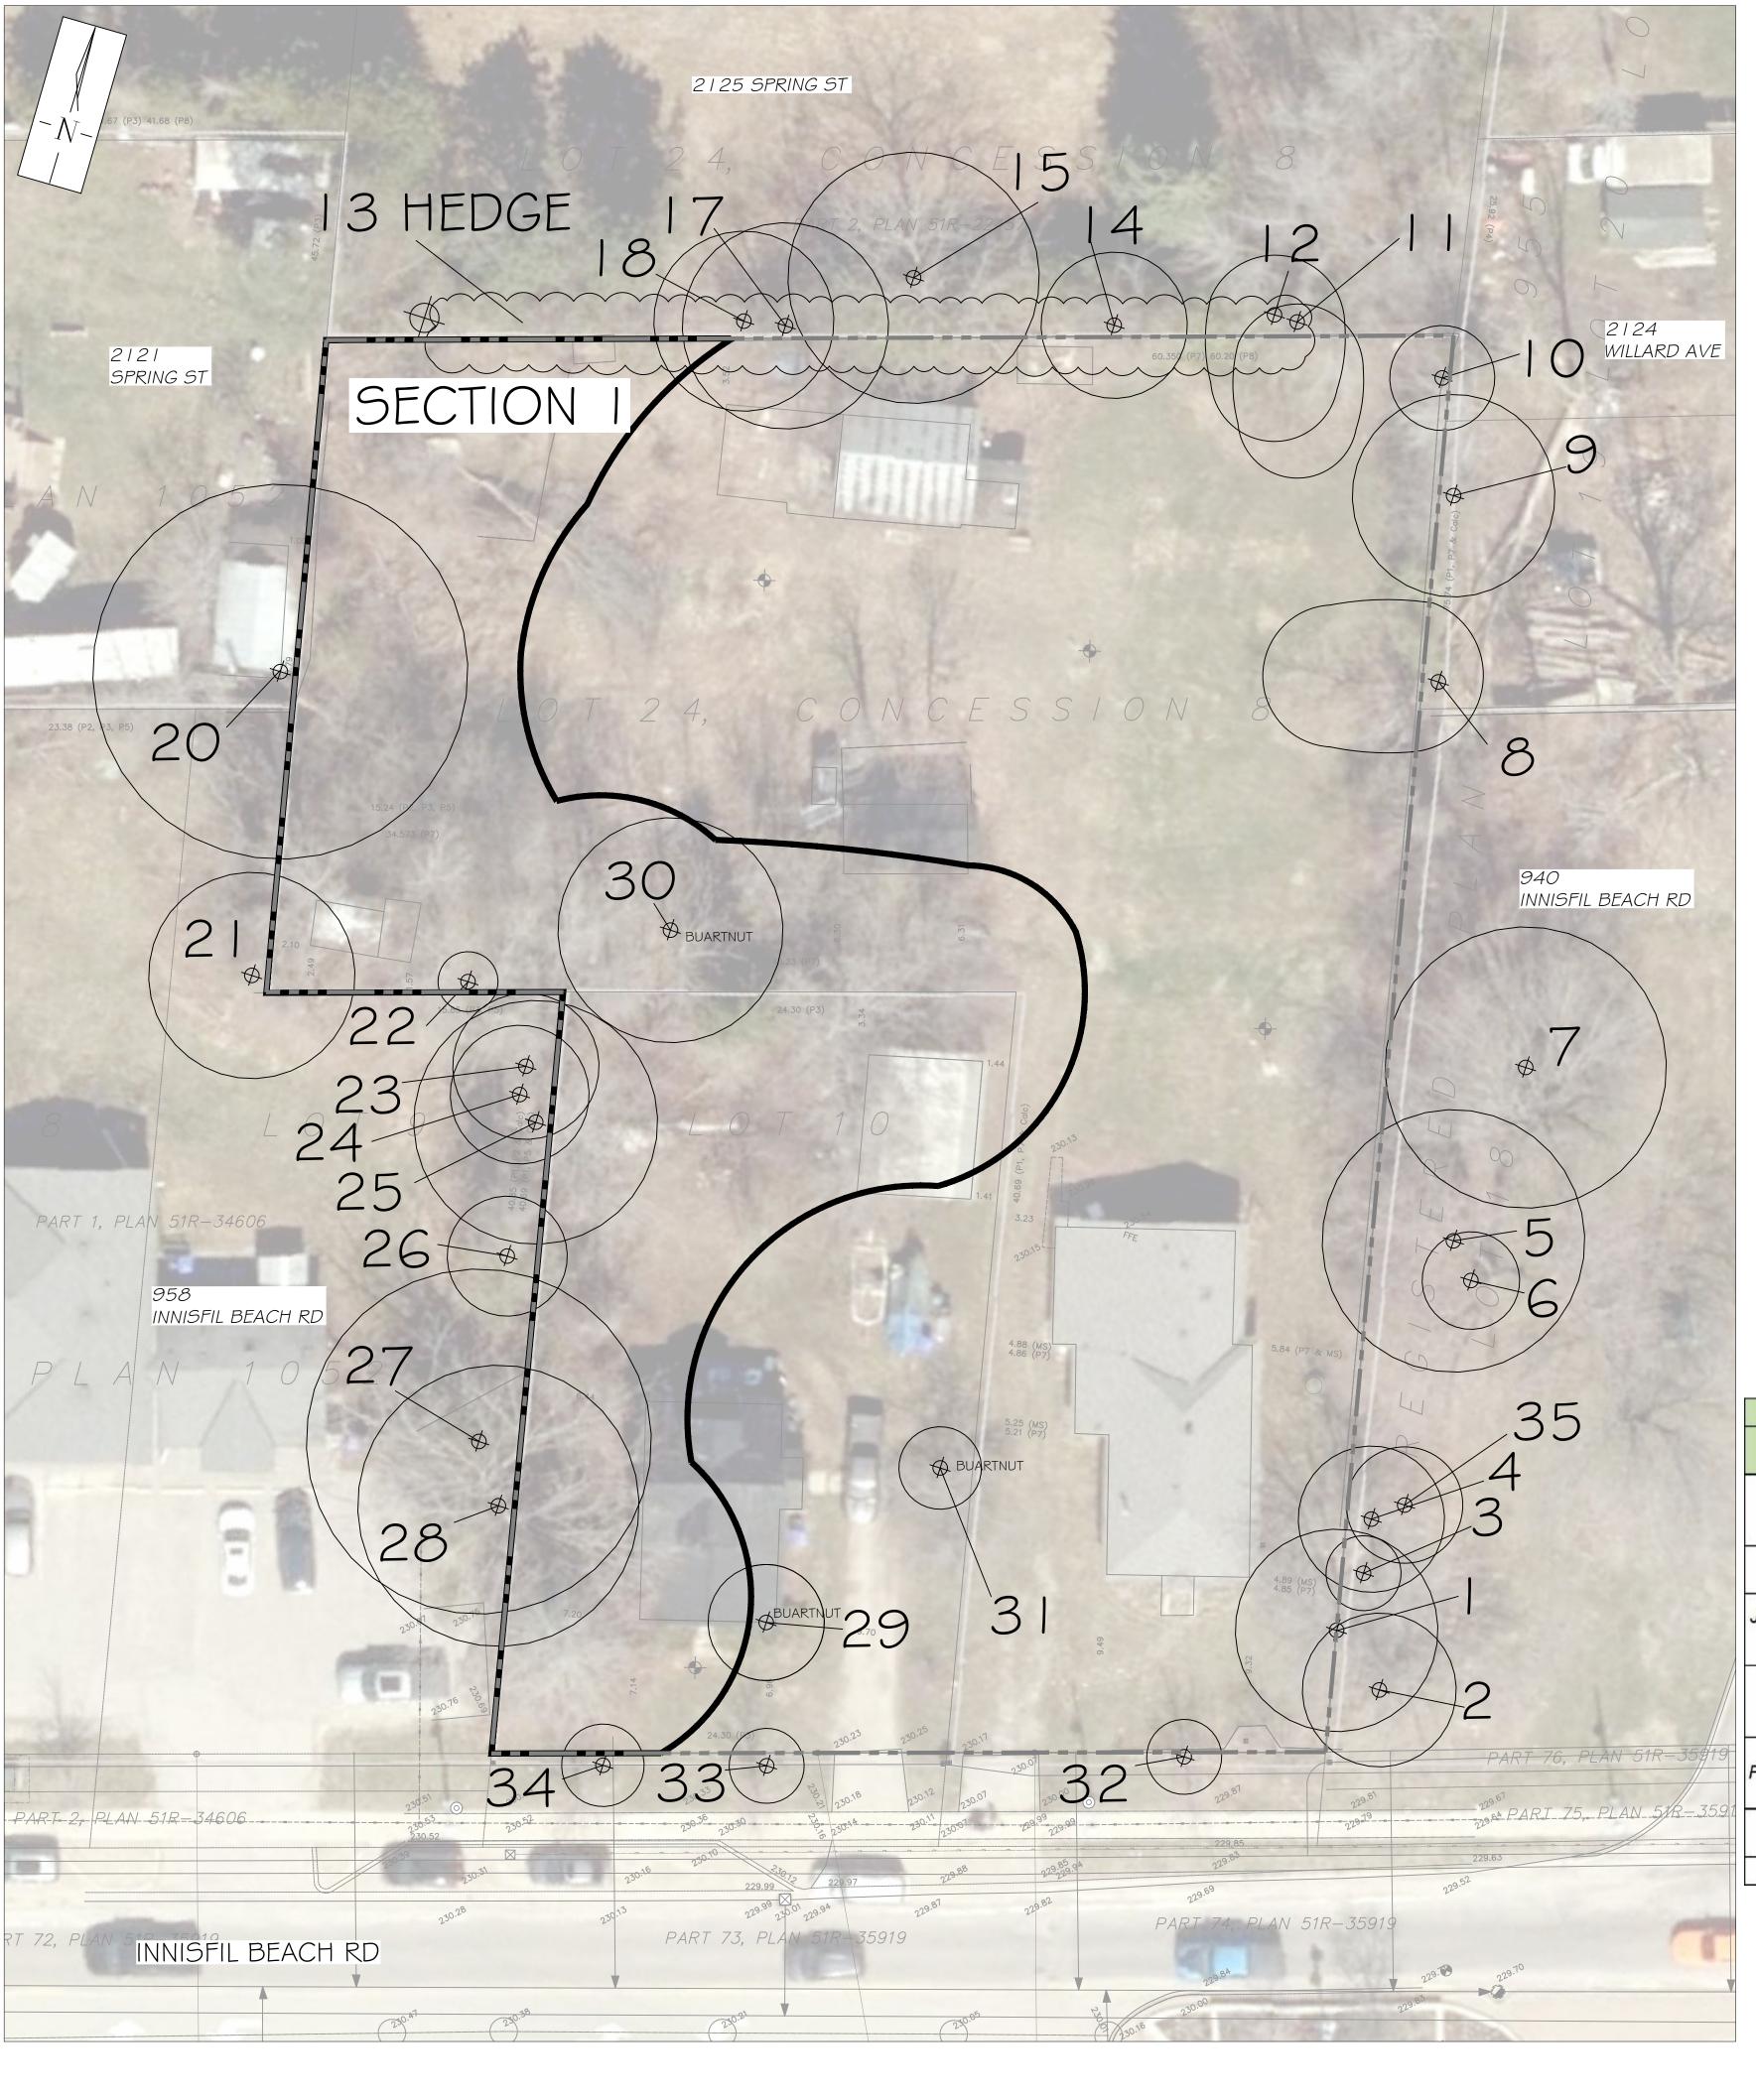

CANOPY SURVEY TREE INVENTORY							
Key	Latin Name	Common Name	Canopy Radius (m)				
1	Juglans nigra	Black Walnut	5.4				
2	Acer negundo	Manitoba Maple	4.1				
3	Juglans nigra	Black Walnut	2.0				
4	Juglans nigra	Black Walnut	3.9				
5	Acer saccharinum	Silver Maple	7.0				
6	Juglans nigra	Black Walnut	2.6				
7	Acer saccharinum	Silver Maple	7.5				
8	Acer negundo	Manitoba Maple	9.3				
9	Crataegus ssp	Cockspur Hawthorn	5.4				
10	Thuja occidentalis	Eastern White Cedar	2.8				
11	Acer negundo	Manitoba Maple	7.3				
12	Acer negundo	Manitoba Maple	6.8				
13 Hedge	Thuja occidentalis	Eastern White Cedar	3.4				
14	Fraxinus americana	White Ash	3.9				
15	Juglans ailantifolia x Juglans cinerea	Buartnut	6.7				
17	Ulmus rubra	Red or Slippery Elm	5.5				
18	Fraxinus americana	White Ash	4.8				
19	Thuja occidentalis	Eastern White Cedar	3.4				
20	Acer negundo	Manitoba Maple	10.0				
21	Acer negundo	Manitoba Maple	5.5				
22	Populus tremuloides	Trembling Aspen	1.6				
23	Acer negundo	Manitoba Maple	3.9				
24	Populus tremuloides	Trembling Aspen	3.7				
25	Juglans ailantifolia x Juglans cinerea	Buartnut	6.5				
26	Thuja occidentalis	Eastern White Cedar	3.2				
27	Juglans ailantifolia x Juglans cinerea	Buartnut	9.2				
28	Juglans ailantifolia x Juglans cinerea	Buartnut	7.5				
29	Juglans ailantifolia x Juglans cinerea	Buartnut	3.1				
30	Juglans ailantifolia x Juglans cinerea	Buartnut	6.0				
31	Juglans ailantifolia x Juglans cinerea	Buartnut	2.2				
32	Acer saccharinum	Silver Maple	2.0				
33	Acer saccharinum	Silver Maple	2.0				
34	Acer saccharinum	Silver Maple	2.2				
35	Juglans ailantifolia x Juglans cinerea	Buartnut	3.1				

Offsite Tree	
<b>Boundary Tree</b>	
Buartnut Tree	

SECTION 1								
LATIN NAME	COMMON NAME	CONDITION	AVG DBH	COMMENTS	COMPOSTION %			
Acer negundo	Manitoba Maple	Poor	15-25	lower branch dieback, poor branch structure, poor form, River Bank Grapevine entering canopies	70%			
Acer rubrum	Red Maple	Fair - Good	10-20	Minor leans, small diameter trees starting to establish	2.5%			
Juglans ailantifolia x Juglans cinerea	Buartnut	Poor - Fair	15-25	Minor Butternut Canker, suspected to be hybrids due to high seed viability and good vigour of trees	2.5%			
Picea abies	Norway Spruce	Dead/dying - Poor	15-25, two large trees near frontage	Sap pitching, lower branch dieback, Eastern Spruce Budworm, branch tip dieback	2.5%			
Populus tremuloides	Trembling Aspen	Poor - Fair	15-25	Hypoxylon Canker, lower branch dieback, natural mortality from hydric soils	20%			
Thuja occidentalis	Eastern White Cedar	Fair	5-15	Foliage dieback, epicormic branching,	2.5%			
		_		Total	100			

SECTION CANOPY AREA (m2)  $\overline{\text{SECTION I}} = 1,314 \text{ m2}$ SOLITARY TREES = 36 m2

VEGETATION CLEARING IS TO BE AVOIDED FROM APRIL I TO AUGUST 3 I TO AVOID IMPACTS TO BIRDS PROTECTED UNDER THE MIGRATORY BIRDS CONVENTION ACT. WINDOW, THE AFFECTED AREA MUST BE SCREENED BY A QUALIFIED ECOLOGIST BEFORE 48HRS OF CLEARING ACTIVITIES.

KEY PLAN NTS	5			
ABRAM CT  LEBANON D  COSHEN  COSHEN  COSHEN	SPRING ST NNOS	MILLARD AVE SUE	KATE AVE	- N- - N- - N- - N- - N- - N- - N- - N-
GENERAL NO	TES			

prior to proceeding with the works to determine the impact and suitability of the proposed works. The Landscape Architect will not be responsible for any unapproved adjustments on site. Construction of the works must conform to Authority requirements and applicable codes where they have jurisdiction.

All specifications and drawings are instruments of service and are the property and ownership of the Landmark Environmental Group Ltd. As such, the drawings shall not be

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TREE LOCATION WITH CANOPY




DELINEATED SECTIONS & GROUPINGS

--- PROPERTY BOUNDARY

13	JUNE 05, 2024	S.K	REVISED TREE PRESERVATION FENCE AS PER PEL COMMEN
12	JUNE 03, 2024	S.K	AS PER SITE PLAN ¢ ELECTRICAL PLAN UPDATES
_	APR.01, 2024	S.K	AS PER SITE GRADING / SERVICING PLAN UPDATES
-0	MAR.15, 2024	S.K	AS PER SITE PLAN / ELECTRICAL PLAN UPDATES \$ TOWN COMMEN
9	FEB.09, 2024	S.K	AS PER TOWN COMMENTS
8	SEPT 18, 2023	S.K	AS PER SITE SERVICING PLAN UPDATES
7	SEP 14, 2023	D.L	AS PER SERVICING PLAN UPDATES
6	AUG.25, 2023	S.K	AS PER ELECTRICAL PLAN UPDATES
5	AUG.01, 2023	S.K	AS PER SITE GRADING & SERVICING PLAN UPDATES
4	JULY 6, 2023	D.L	UPDATE LANDSCAPE PLAN AS PER SURVEY PLAN
3	SEPT 26, 2022	S.K	ISSUED FOR SUBMISSION TO TOWN
2	JULY 26, 2022	S.K	AS PER SITE PLAN UPDATES
1	JULY 22, 2022	L.O	AS PER UPDATED SITE PLAN

STAMP

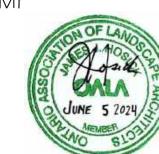

APPROVAL TOWN OF INNISFIL

AERIAL PHOTO (2022) SOURCED FROM SIMCEO COUNTY GIS SURVEY PROVIDED BY RODNEY GEYER ONTARIO LAND SURVEYOR INC. (21-3381 SRPR TOPO LOCAL SEPTEMBER 28 2021.DWG)

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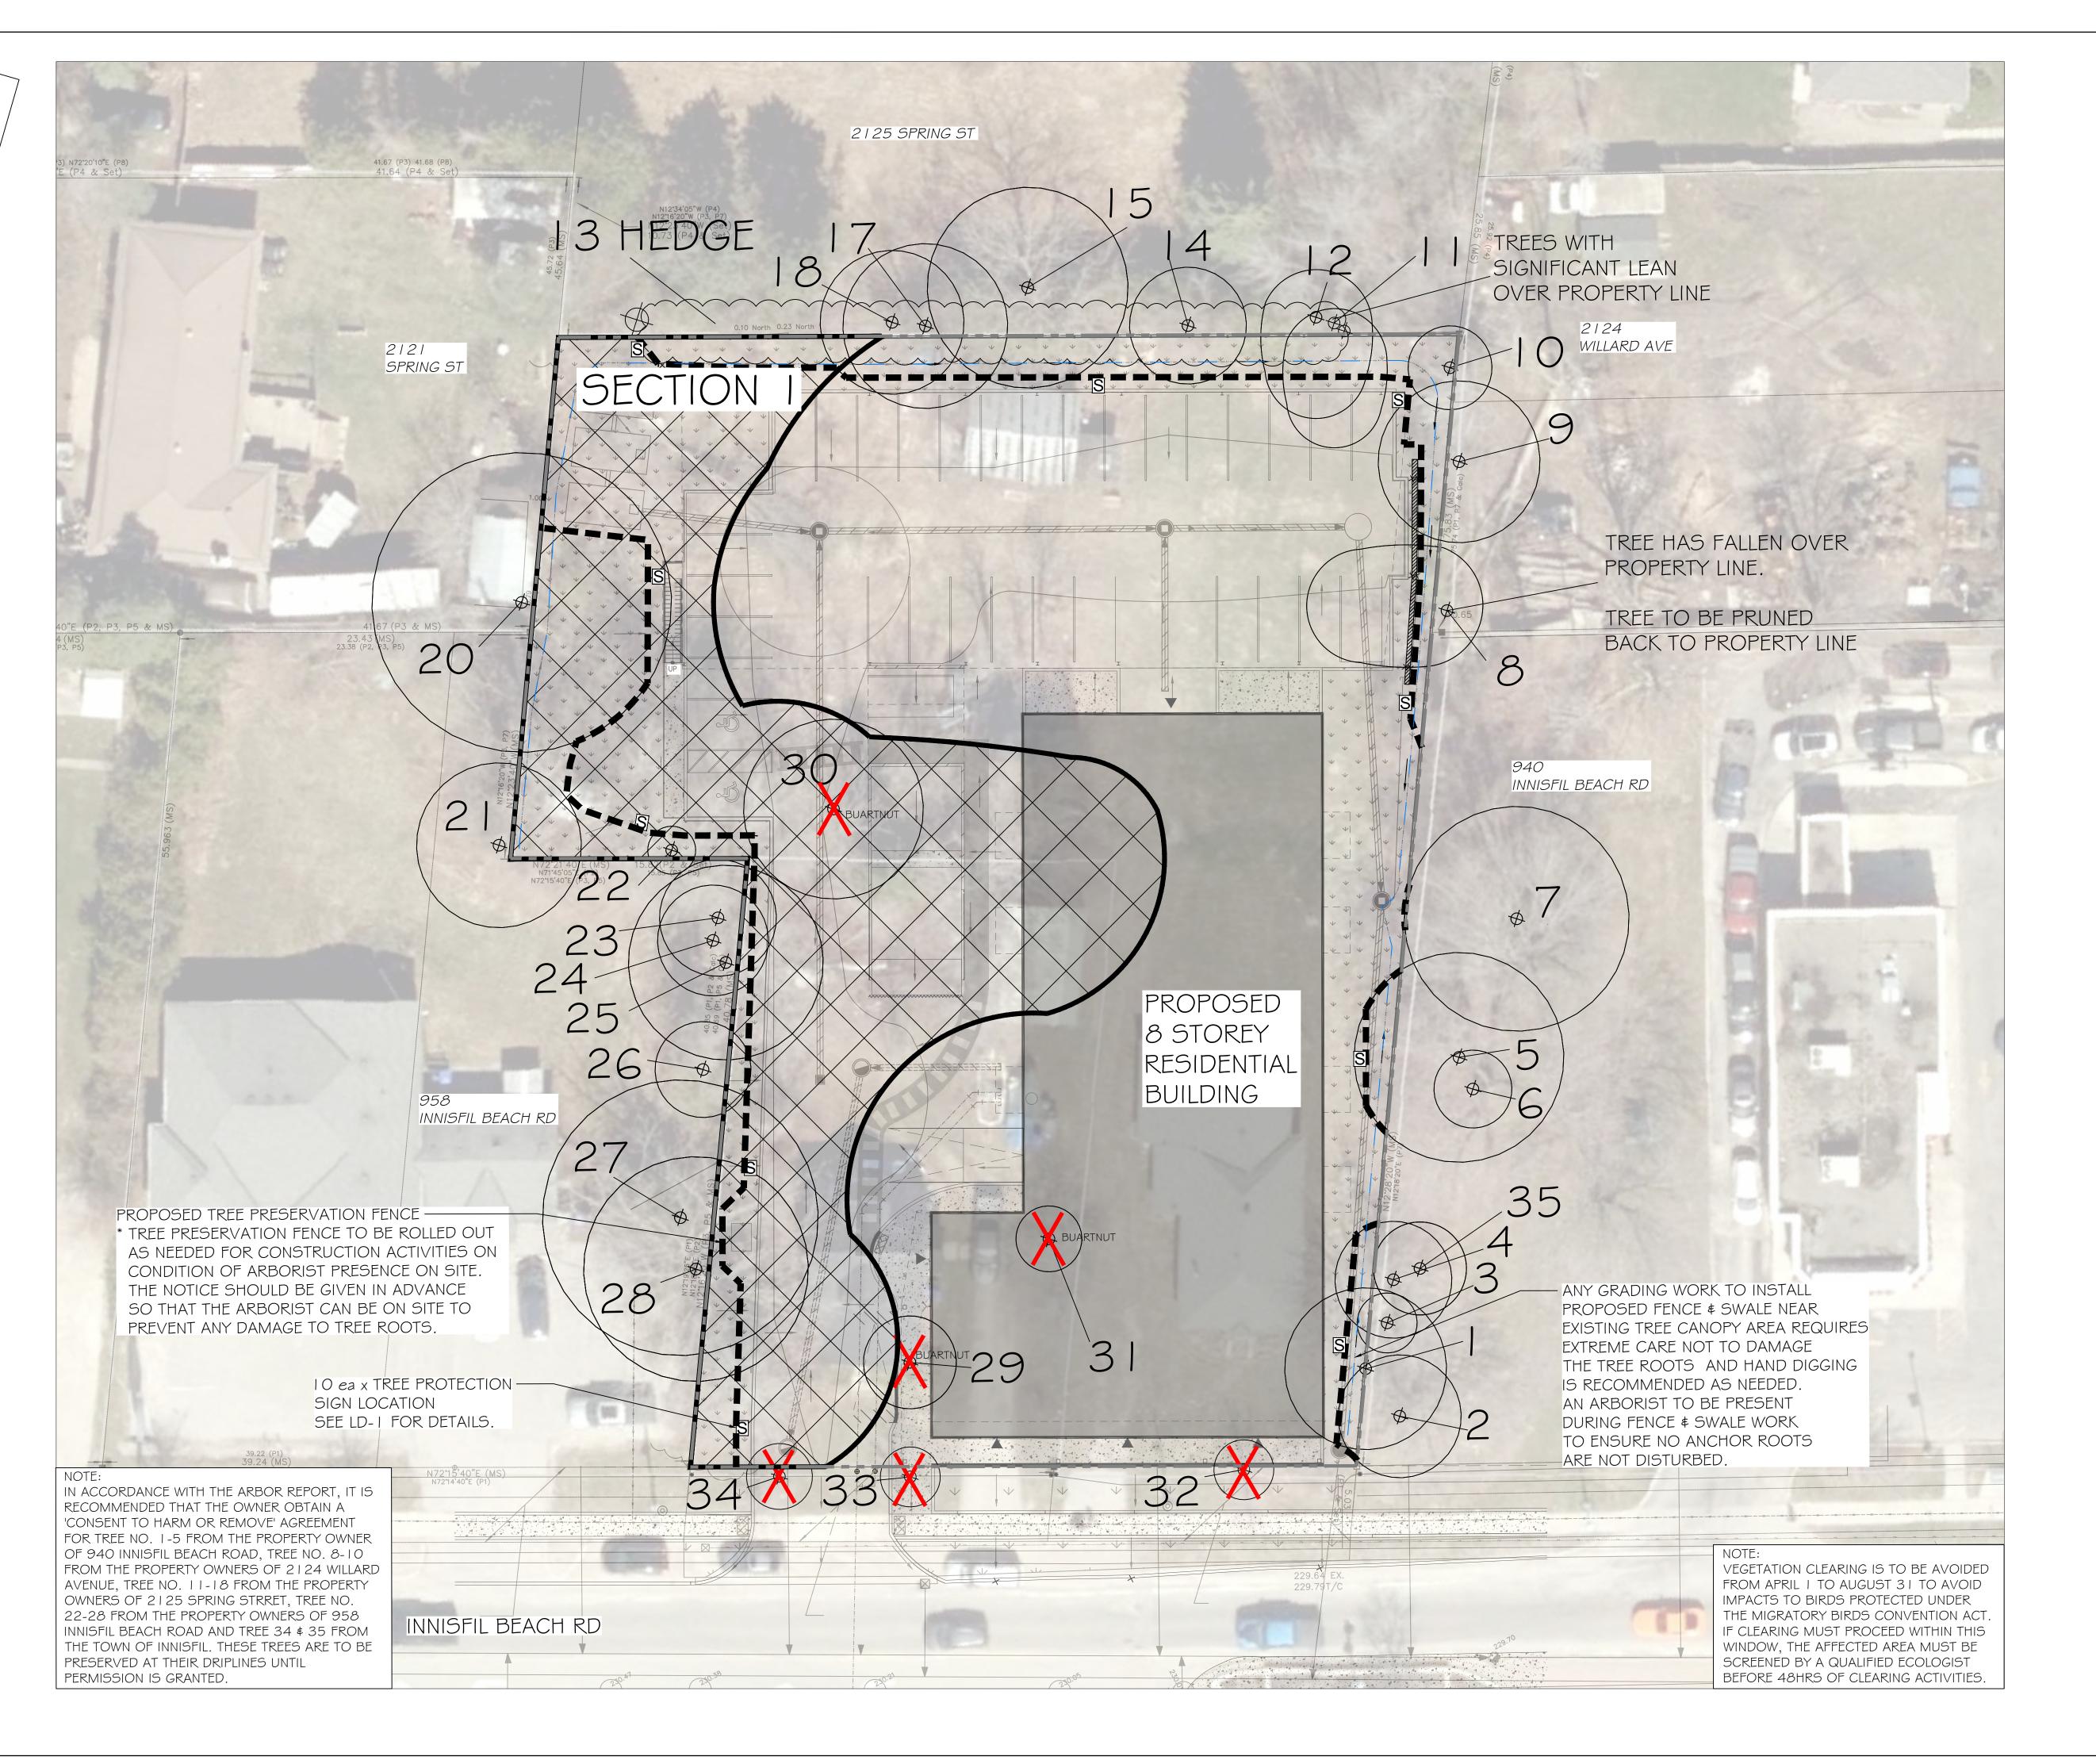
ROCH DEVELOPMENTS


PROJECT: 946-950 INNISFIL BEACH ROAD

EXISTING CONDITIONS

SCALE: PROJECT NO .: 1:200 LA 596-21 MUNICIPAL FILE NO.: NOVEMBER 17, 202 SP 2021-018 DRAWING No.: DRAWN BY: CHECKED BY: EX-1

TOTAL = 1,350 m2



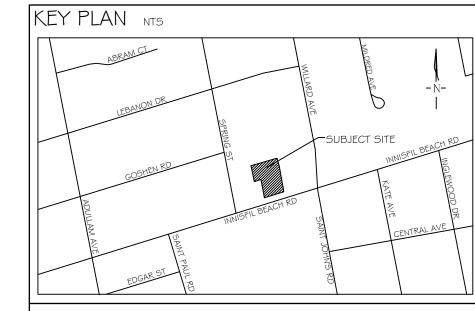

### GENERAL NOTES

The Client and its contractors are responsible for all utility locates and confirming all setbacks, elevations, grades, etc. prior to installation of the constructed works. The Contractor is to report any discrepancies in writing to the Landscape Architect prior to proceeding with the works to determine the impact and suitability of the roposed works. The Landscape Architect will not be responsible for any unapproved djustments on site. Construction of the works must conform to Authority requirements and applicable codes where they have jurisdiction.

All specifications and drawings are instruments of service and are the property and wnership of the Landmark Environmental Group Ltd. As such, the drawings shall not be nodified or reproduced without the expressed written consent of Landmark ivironmental Group Ltd. or they will be considered void. The said drawings are for Si an approval only and may require additional detailing prior to tender and construction The Landmark Environmental Group Ltd. is not liable for errors or omissions from the use f these drawings prior to approval, seal, signature and date, and will be considered void. It is advised that the Contractor contact the Landscape Architect prior to mmencement of the construction works to ensure that the Contractor has the latest pproved drawings. The Landmark Environmental Group Ltd. is not responsible for the accuracy of the base drawing information (eg Survey, Architectural, Engineering, etc). f there are any discrepancies, the Contractor will refer to the appropriate base drawing information and report discrepancies on the Landscape Drawings to the Landscape

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### LEGEND



TREE LOCATION WITH CANOPY



DELINEATED SECTIONS & GROUPINGS



SECTION DELINEATED FOR REMOVAL




TREE PRESERVATION FENCE

--- PROPERTY BOUNDARY

PROPOSED SWALE (BY OTHERS)

13	JUNE 05, 2024	S.K	REVISED TREE PRESERVATION FENCE AS PER PEL COMMEN
12	JUNE 03, 2024	S.K	AS PER SITE PLAN & ELECTRICAL PLAN UPDATES
11	APR.01, 2024	S.K	AS PER SITE GRADING / SERVICING PLAN UPDATES
10	MAR.15, 2024	S.K	AS PER SITE PLAN / ELECTRICAL PLAN UPDATES \$ TOWN COMME
9	FEB.09, 2024	S.K	AS PER TOWN COMMENTS
8	SEPT 18, 2023	S.K	AS PER SITE SERVICING PLAN UPDATES
7	SEP 14, 2023	D.L	AS PER SERVICING PLAN UPDATES
6	AUG.25, 2023	S.K	AS PER ELECTRICAL PLAN UPDATES
5	AUG.01, 2023	S.K	AS PER SITE GRADING & SERVICING PLAN UPDATE
4	JULY 6, 2023	D.L	UPDATE LANDSCAPE PLAN AS PER SURVEY PLAN
3	SEPT 26, 2022	S.K	ISSUED FOR SUBMISSION TO TOWN
2	JULY 26, 2022	S.K	AS PER SITE PLAN UPDATES
I	JULY 22, 2022	L.O	AS PER UPDATED SITE PLAN
NO	DATE	BY	REVISIONS

STAMP

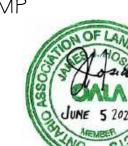

TOWN OF INNISFIL

APPROVAL

SITE GRADING & SERVICING PLAN PROVIDED BY PINESTONE ENGINEERING LTI

# LANDMARK


### LANDSCAPE ARCHITECTS & CONSULTING ARBORISTS


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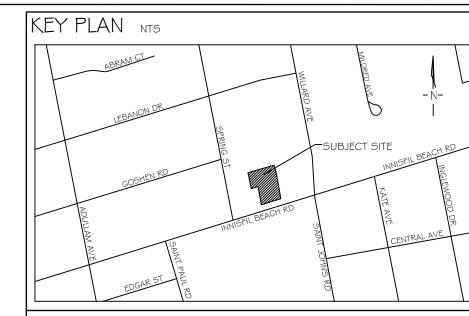
CLIENT: ROCH DEVELOPMENTS

PROJECT:

946-950 INNISFIL BEACH ROAD



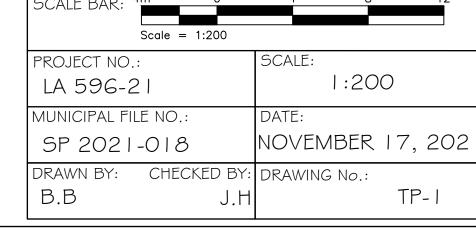

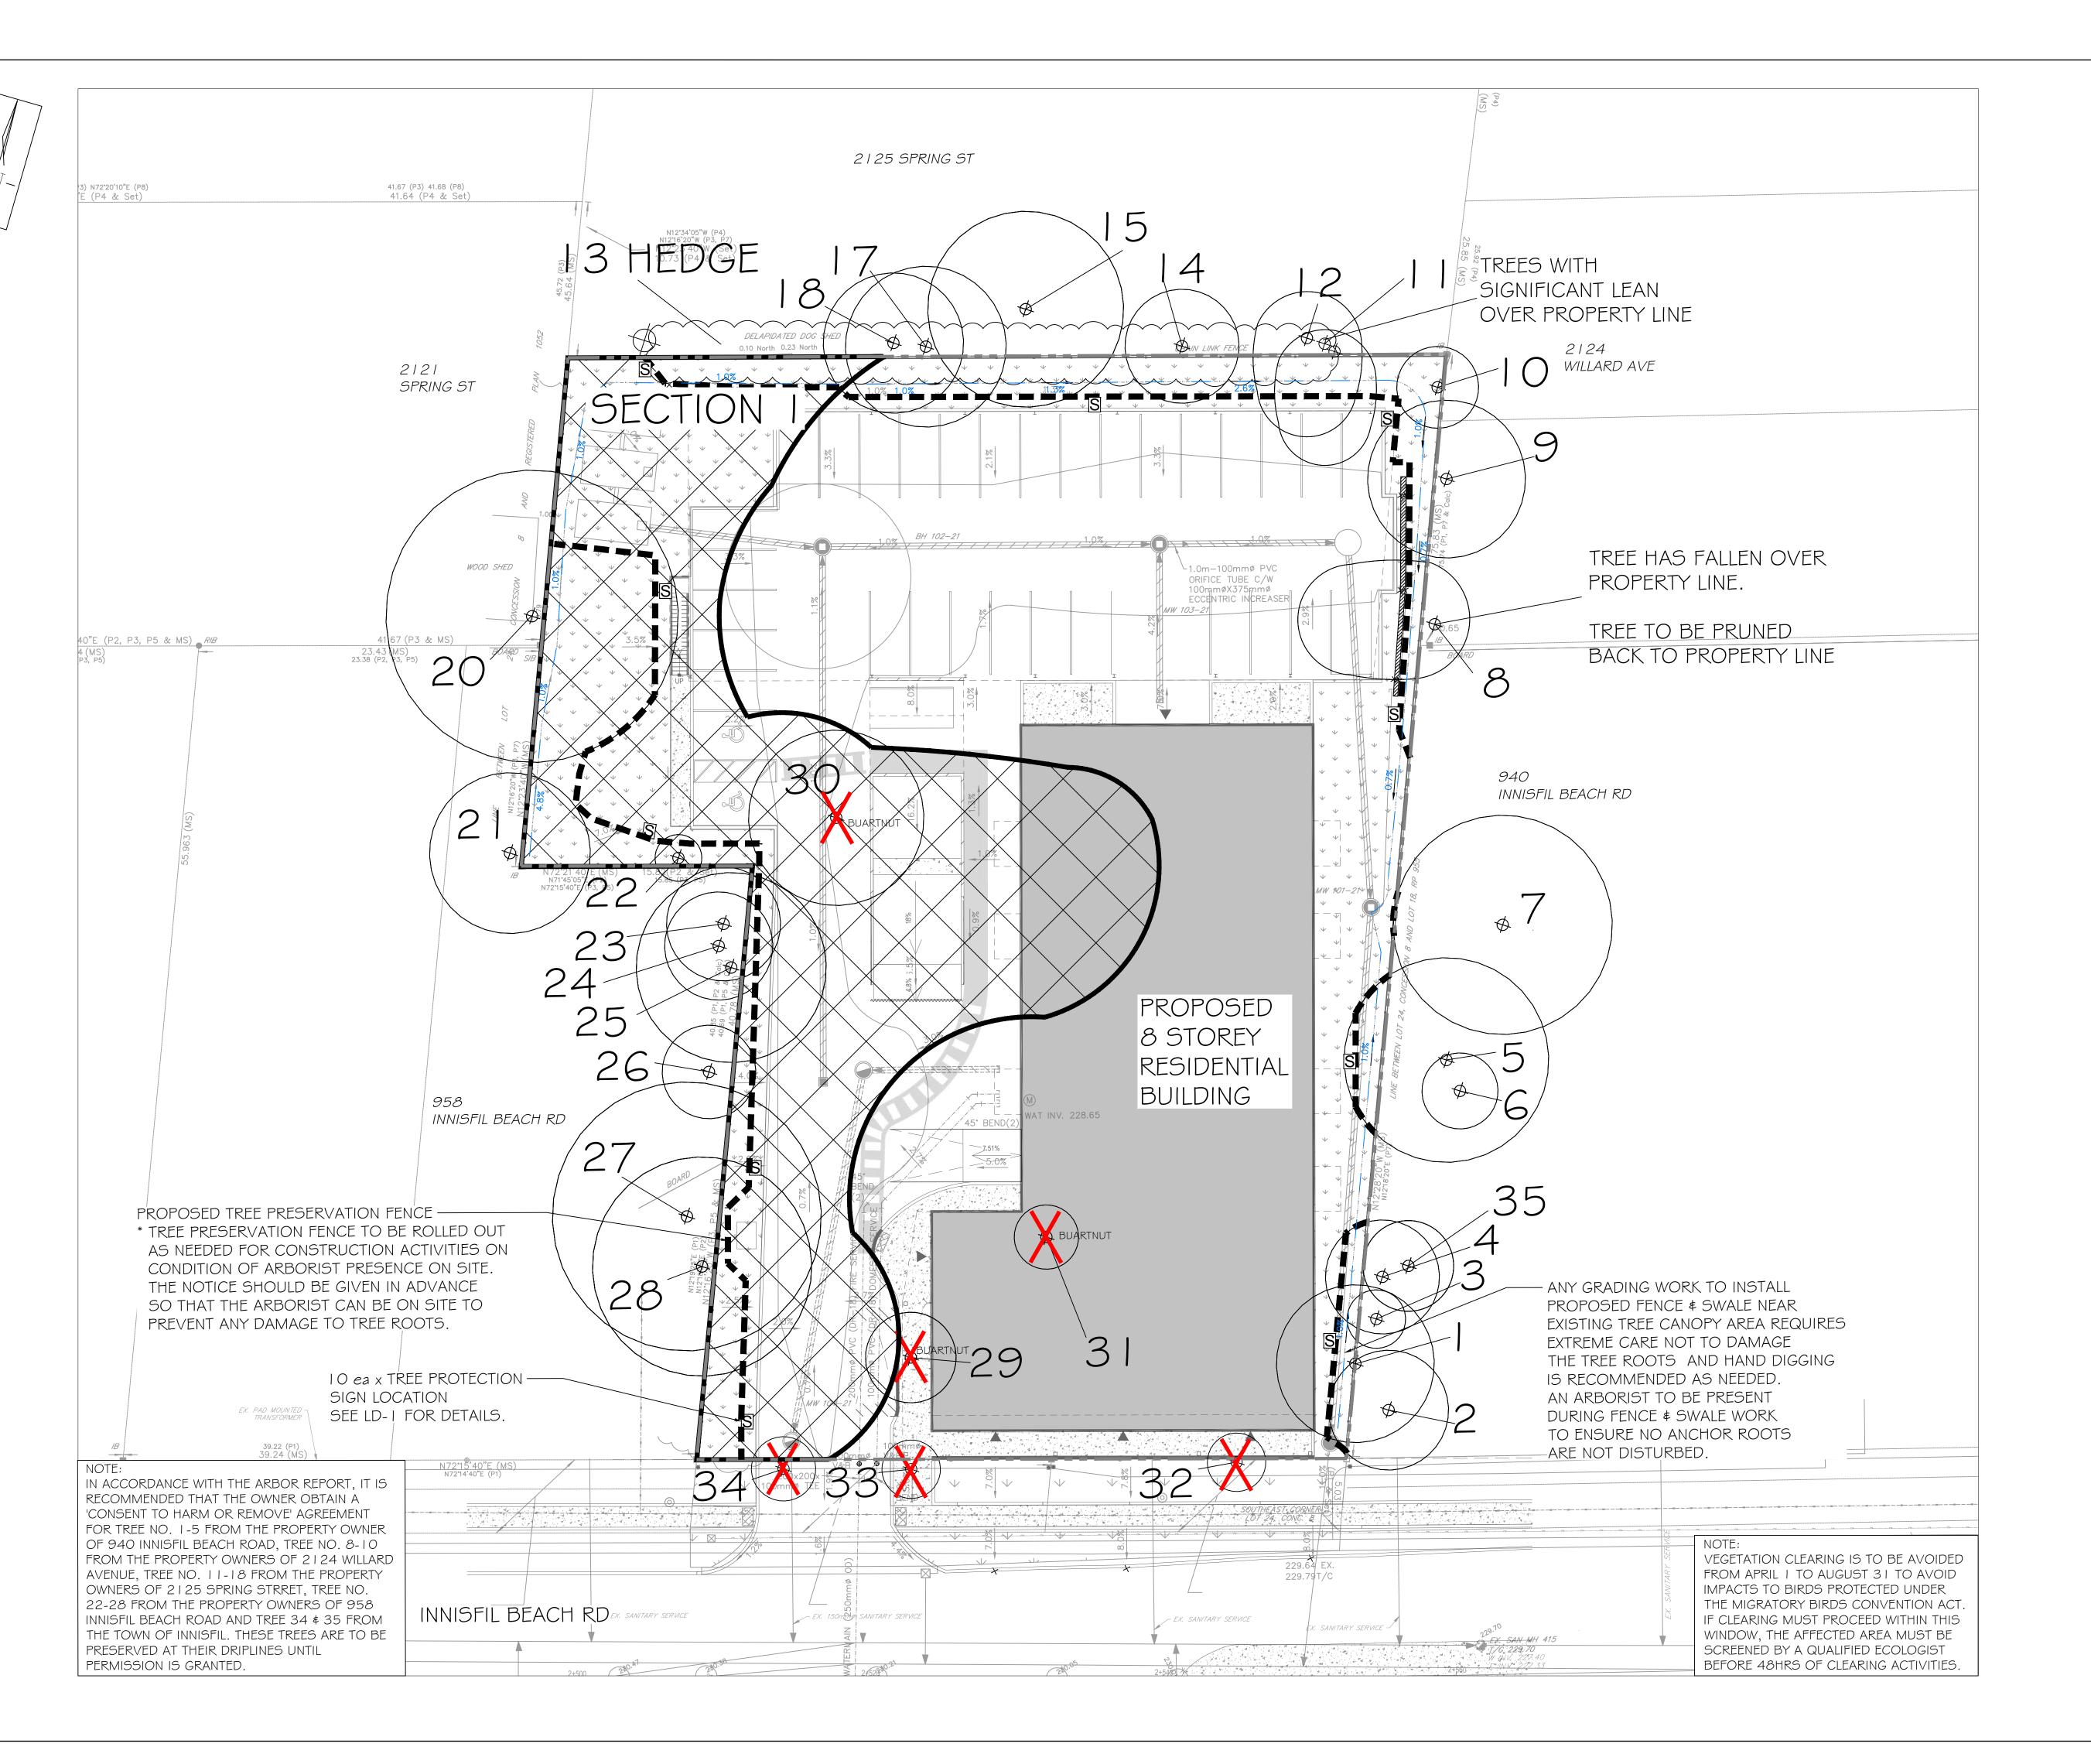

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### LEGEND



TREE LOCATION WITH CANOPY



DELINEATED SECTIONS & GROUPINGS



TREE RECOMMENDED TO REMOVE

SECTION DELINEATED FOR REMOVAL



TREE PROTECTION SIGN

--- PROPERTY BOUNDARY

(BY OTHERS)

PROPOSED SWALE

TREE PRESERVATION FENCE

13 JUNE 05, 2024 S.K REVISED TREE PRESERVATION FENCE AS PER PEL COMMENTS
12 JUNE 03, 2024 S.K AS PER SITE PLAN & ELECTRICAL PLAN UPDATES
11 APR.01, 2024 S.K AS PER SITE GRADING / SERVICING PLAN UPDATES
10 MAR. 15, 2024 S.K AS PER SITE PLAN / ELECTRICAL PLAN UPDATES & TOWN COMMENTS
9 FEB.09, 2024 S.K AS PER TOWN COMMENTS
8 SEPT 18, 2023 S.K AS PER SITE SERVICING PLAN UPDATES
7 SEP 14, 2023 D.L AS PER SERVICING PLAN UPDATES
6 AUG.25, 2023 S.K AS PER ELECTRICAL PLAN UPDATES
5 AUG.01, 2023 S.K AS PER SITE GRADING & SERVICING PLAN UPDATES
4 JULY 6, 2023 D.L UPDATE LANDSCAPE PLAN AS PER SURVEY PLAN
3 SEPT 26, 2022 S.K ISSUED FOR SUBMISSION TO TOWN

### STAMP

JULY 26, 2022

JULY 22, 2022

DATE



APPROVAL

TOWN OF INNISFIL

DATE \_\_\_\_

REVISIONS

AS PER SITE PLAN UPDATES

AS PER UPDATED SITE PLAN

SITE PLAN PROVIDED BY MCKNIGHT CHARRON LIMITED ARCHITECTS (INNISFIL BEACH ROAD (#94G \$ 950)\_2024 05 27-SHEET - A1-1 - SITE PLAN.DWG) TRANS ON MAY 27, 2024 SITE GRADING \$ SERVICING PLAN PROVIDED BY PINESTONE ENGINEERING LTD

(GRADING \$ SERVICING PLAN - 11652-SERV-GRD.DWG TRANS ON MAR.21, 2024)

# LANDMARK ENVIRONMENTAL GROUP LTD Landscape Architects Consulting Arborists Urban Forestry

# LANDSCAPE ARCHITECTS & CONSULTING ARBORISTS

OFFICE: 705-796-1122 info@LEGroupLtd.com www.LEGroupLtd.com

CLIENT: ROCH DEVELOPMENTS

PROJECT:

946-950 INNISFIL BEACH ROAD

DRAWING:

TREE PRESERVATION PLAN 2

Scale = 1:200

PROJECT NO.:

LA 596-2 | SCALE:

LA 596-2 | I:200


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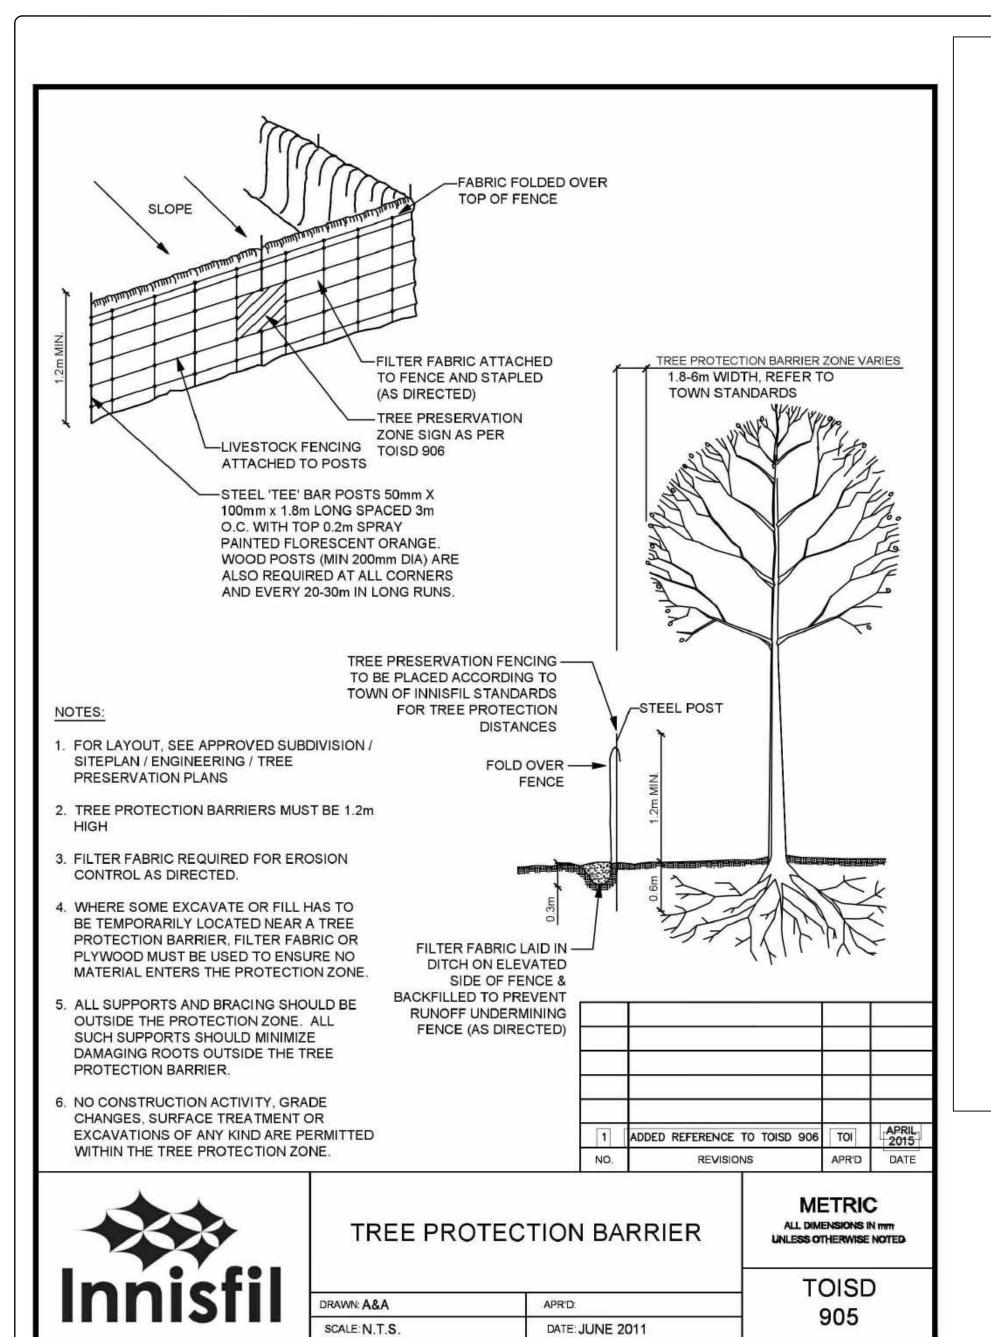
SP 2021-018 | DATE:


NOVEMBER 17, 202

DRAWN BY: CHECKED BY: DRAWING No.:

B.B J.H TP-2



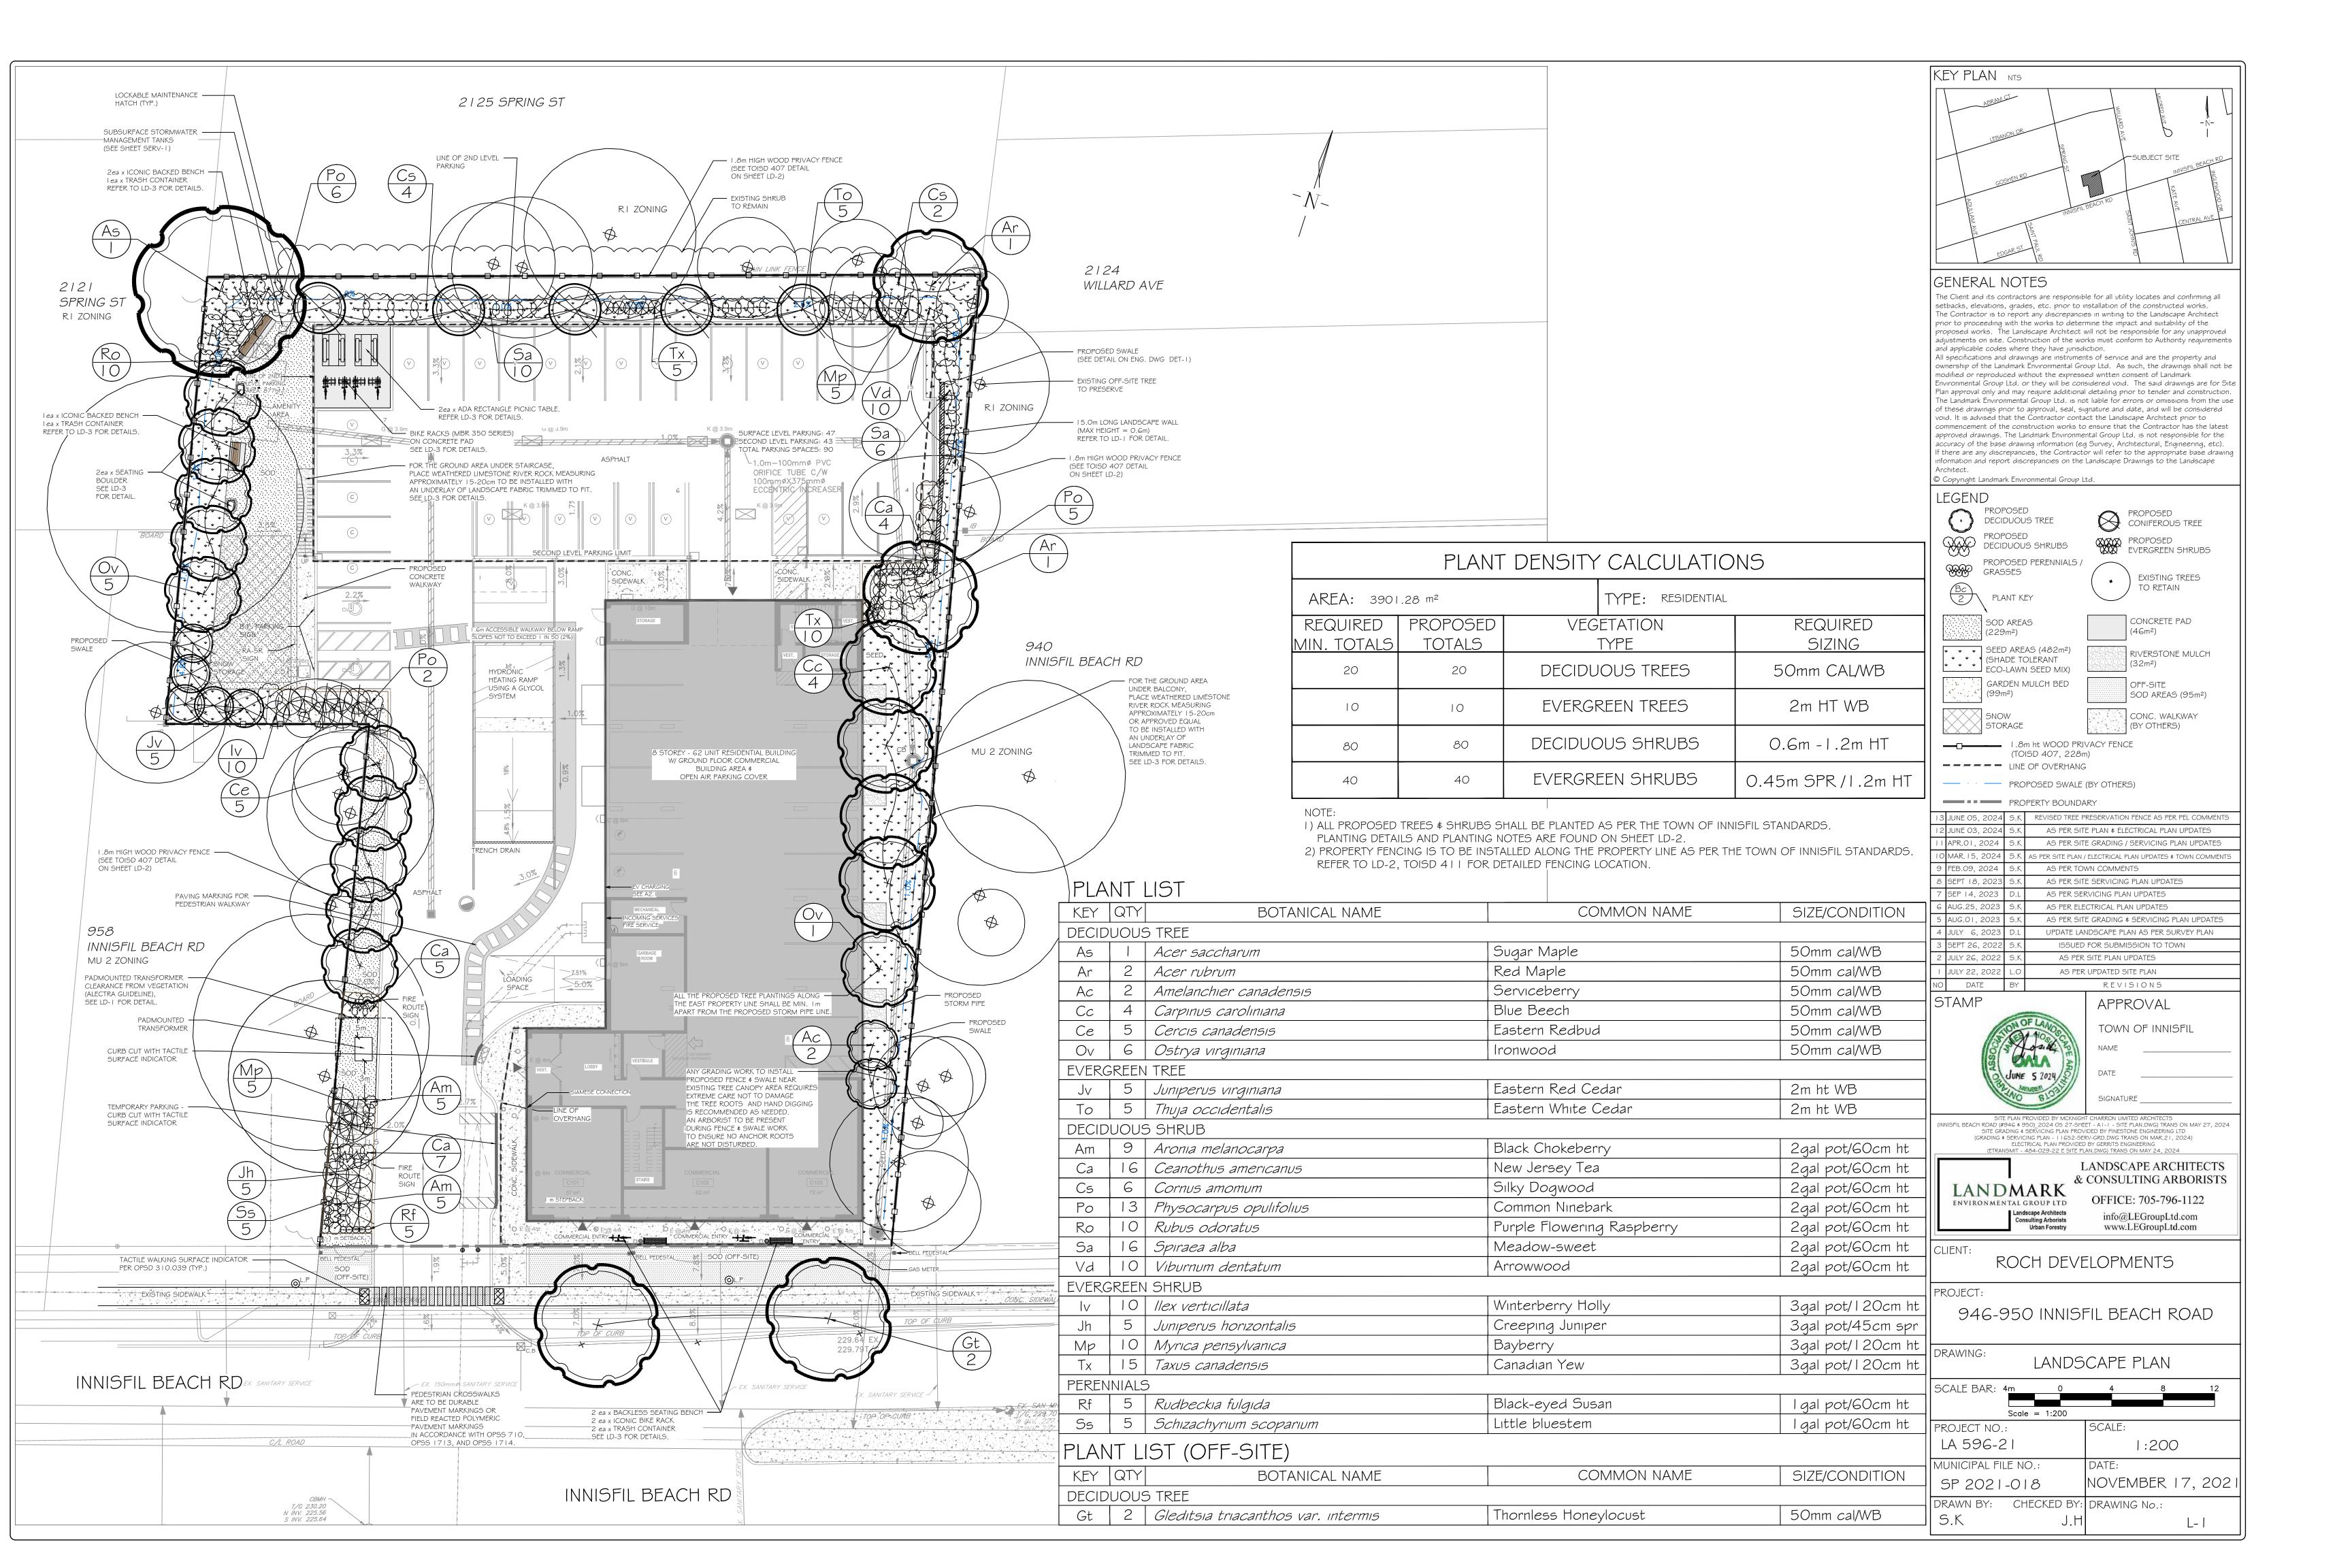

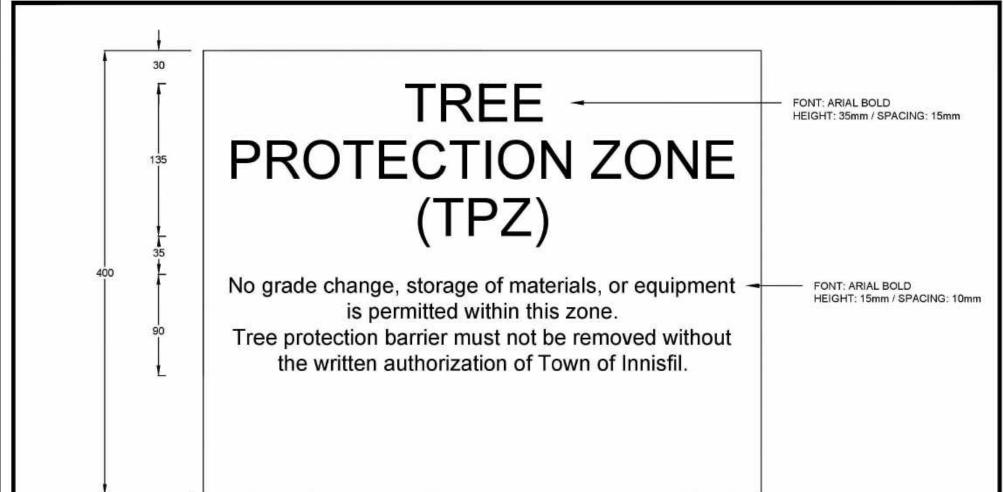

ALL DIMENSIONS IN mm

TOISD 906

TREE PROTECTION ZONE SIGN

DATE APRIL 2015

REVISIONS

### TREE PRESERVATION NOTES

I. THE INTENT OF THE TREE PRESERVATION PLAN IS TO PROVIDE PROTECTION AND PRESERVATION FOR EXISTING TREES ON THE SUBJECT PROPERTY. THEREFORE, ALL TREES ARE TO BE PRESERVED UNLESS OTHERWISE INDICATED IN THE PLAN OR THE ARBORIST'S REPORT. CONTACT THE LANDSCAPE ARCHITECT TO CONFIRM THE REMOVAL/RETENTION STATUS OF ANY TREES ON SITE, PRIOR TO CLEARING AND GRUBBING. THE OWNER WILL TAKE EVERY PRECAUTION TO PROTECT AND PRESERVE THE TREES APPROVED TO BE RETAINED IN ACCORDANCE WITH THE APPROVED PLANS.

2. PRIOR TO THE COMMENCEMENT OF ANY CLEARING, GRUBBING OR CONSTRUCTION WORKS, THE REQUIRED HOARDING WILL BE ERECTED 5M OUTSIDE OF THE OUTERMOST DRIPLINE OF ANY TREE TO BE RETAINED, IN ACCORDANCE WITH THE HOARDING DETAIL, AND TO THE SATISFACTION OF THE LANDSCAPE ARCHITECT. ERECTION OF ANY PROTECTION FENCING LESS THAN 5M SHALL BE UNDER THE DIRECTION OF THE LANDSCAPE ARCHITECT.

3. IT IS THE RESPONSIBILITY OF THE CONTRACTOR TO ERECT AND MAINTAIN ALL HOARDING AS PER THE APPROVED DETAIL, PRESERVATION NOTES AND LOCATIONS SHOWN ON THE DRAWINGS.

4.NO STORAGE OF EQUIPMENT OR VEHICLES, NOR ANY STOCKPILING OF MATERIAL IS TO OCCUR WITHIN THE AREA OF PRESERVATION/PROTECTION. TREES SLATED FOR PROTECTION WILL NOT BE USED FOR RIGGING OR WRAPPING. THE PROTECTION/PRESERVATION AREA SHALL NOT BE USED TO EMPTY CONTAMINANTS, REFUELING OR REPAIR OF VEHICLES OR EQUIPMENT.

5. TREES LOCATED ON THE IMMEDIATE EDGE OF THE CONSTRUCTION WORKS ARE TO BE PRUNED IN THE INTEREST OF SAFETY, IN ACCORDANCE WITH APPROVED ARBORICULTURAL PRACTICES.

6. TREE LOCATIONS ARE APPROXIMATE AND THEREFORE VERIFICATION ON SITE IS REQUIRED.

7. SHOULD A TREE REQUIRED TO BE PROTECTED BECOME DAMAGED OR REMOVED WITHOUT WRITTEN PERMISSION OF THE TOWN OF INNISFIL OR THE LANDSCAPE ARCHITECT, THE CONTRACTOR OR OWNER WILL BE RESPONSIBLE FOR REPLACEMENT OF THE TREE OF EQUAL CALIPER AND ACCEPTABLE TREE SPECIES AT THE DISCRETION AND SATISFACTION OF THE LANDSCAPE ARCHITECT.


8. THE WORK COMPLETED BY THE CONTRACTOR WILL NOT CAUSE OR EXACERBATE FLOODING CONDITIONS OR CAUSE SEDIMENT BUILDUP OVER THE ROOTZONE OF PROTECTED TREES. NO GRADING SHALL TAKE PLACE WITHIN THE TREE PRESERVATION AREA UNLESS OTHERWISE APPROVED BY THE LANDSCAPE ARCHITECT.

9. ANY REQUIRED LIMB TRIMMING SHALL BE UNDER THE DIRECT SUPERVISION OF THE LANDSCAPE ARCHITECT OR A QUALIFIED ARBORIST.


I O. PRESERVATION FENCING TO BE INSTALLED IN ACCORDANCE WITH THE APPROVED DETAIL. FILTER FABRIC TO BE INSTALLED IN CONJUNCTION WITH THE APPROVED ENGINEERING DRAWINGS.


I I. HOARDING/TREE PRESERVATION MAY BE COMPLETED IN CONJUNCTION WITH SEDIMENTATION CONTROL.



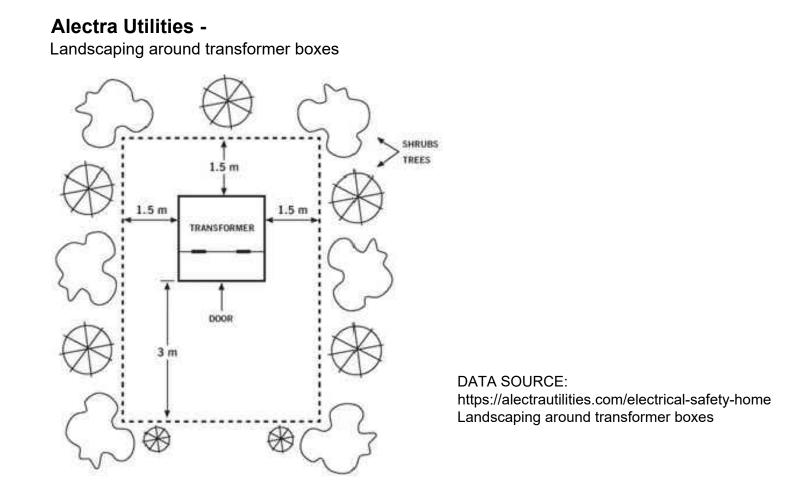

# RETAINING WALL (O.6m ht max) PISA SMOOTH, CLIFFSIDE GREY COLOR

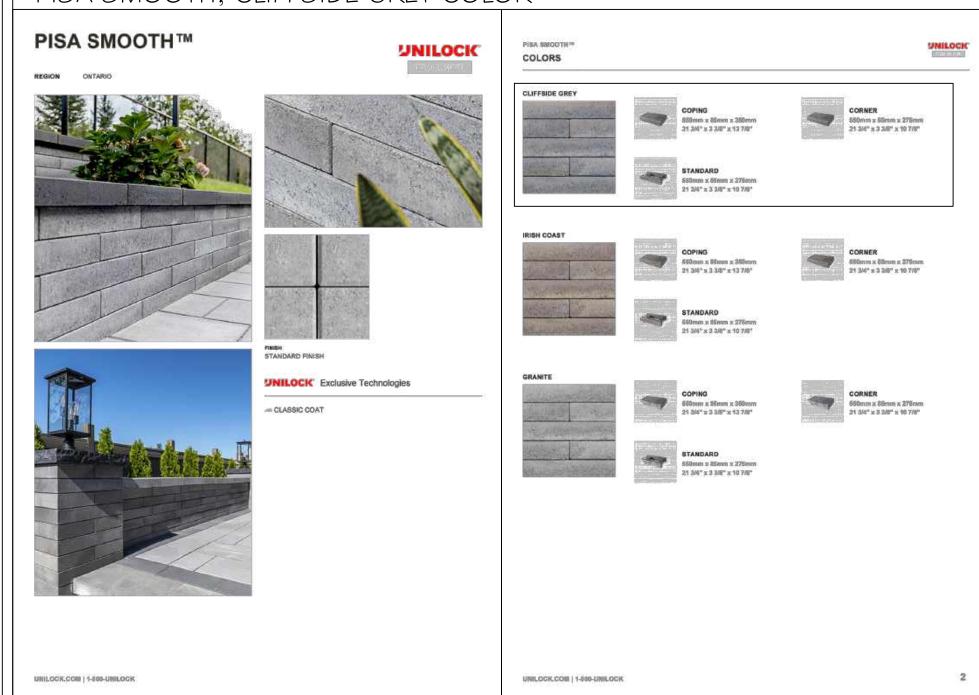

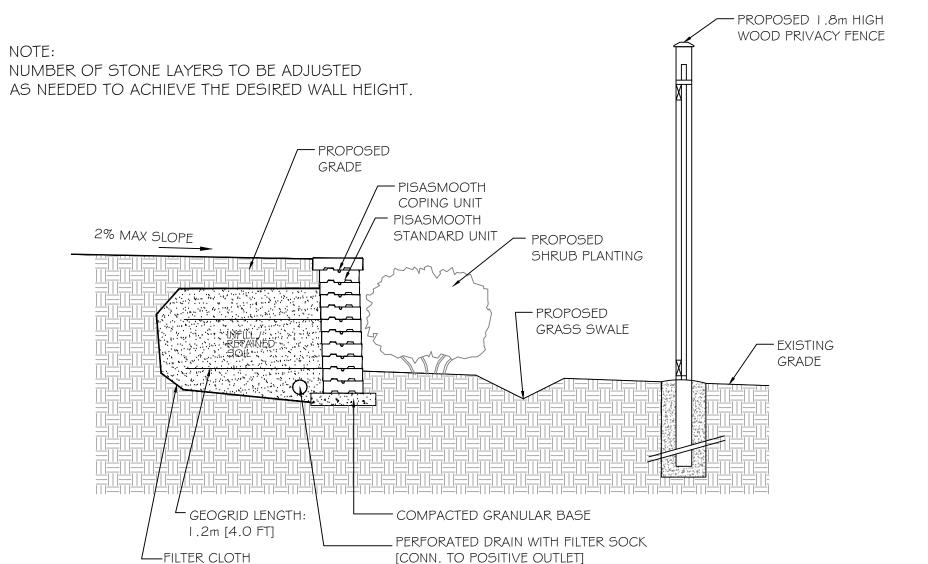


LANDMARK
ENVIRONMENTAL GROUP LTD
Landscape Architects
Consulting Arborists
Urban Forestry

RETAINING WALL DETAIL (TYP.)

DETAIL SOURCE: https://commercial.unilock.com/resources/cross-sections-and-details/

RE <sup>v</sup>	VIEWED: J.H.	DATE:JUNE 23-23
DR	AWN: S.K	SCALE: N.T.S.

1,374

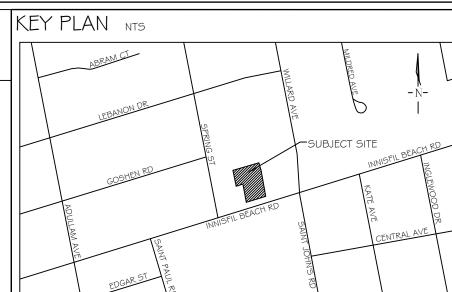

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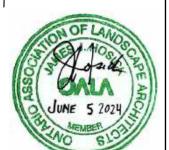
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LEGEND	
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NO	DATE	BY	REVISIONS

STAMP



APPROVAL

TOWN OF INNISFIL

NAME

DATE

No N	let	Loss"	Calculation	Table	for	Innisfil	Compensa
	_	1					

Date: March 15, 2024	Project: 948-950 Innisfil Beach Road, Innisfil	File Number: LA 596-21	

No Net Loss Calculations	
Total Canopy Area on Site (m2):	1,350
Total Canopy Area to be Retained (m2):	0
Total Canopy Area to be Compensated (m2):	1,350

		Com	pensation Tree Reccomendations		20.
Latin Name	Common Name	QTY	Canopy Diameter Expectation (m)	Canopy Area (m2)	Total Canopy Area (m2)
Acer saccharum	Sugar Maple	1	18	254	254
Acer rubrum	Red Maple	2	12	113	226
Amelanchier canadensis	Serviceberry	2	4	13	26
Carpinus caroliniana	Blue Beech	4	10	79	314
Cercis canadensis	Eastern Redbud	5	8	50	252
Ostrya virginiana	Ironwood	6	8	50	302
		Total Ca	anopy Area	ž.	1,374
		No	Net Loss Calculation Results		**************************************
Total Canopy Area Compensation Required (m2):				1,350	

Total Canopy Area Compensation Provided (m2):



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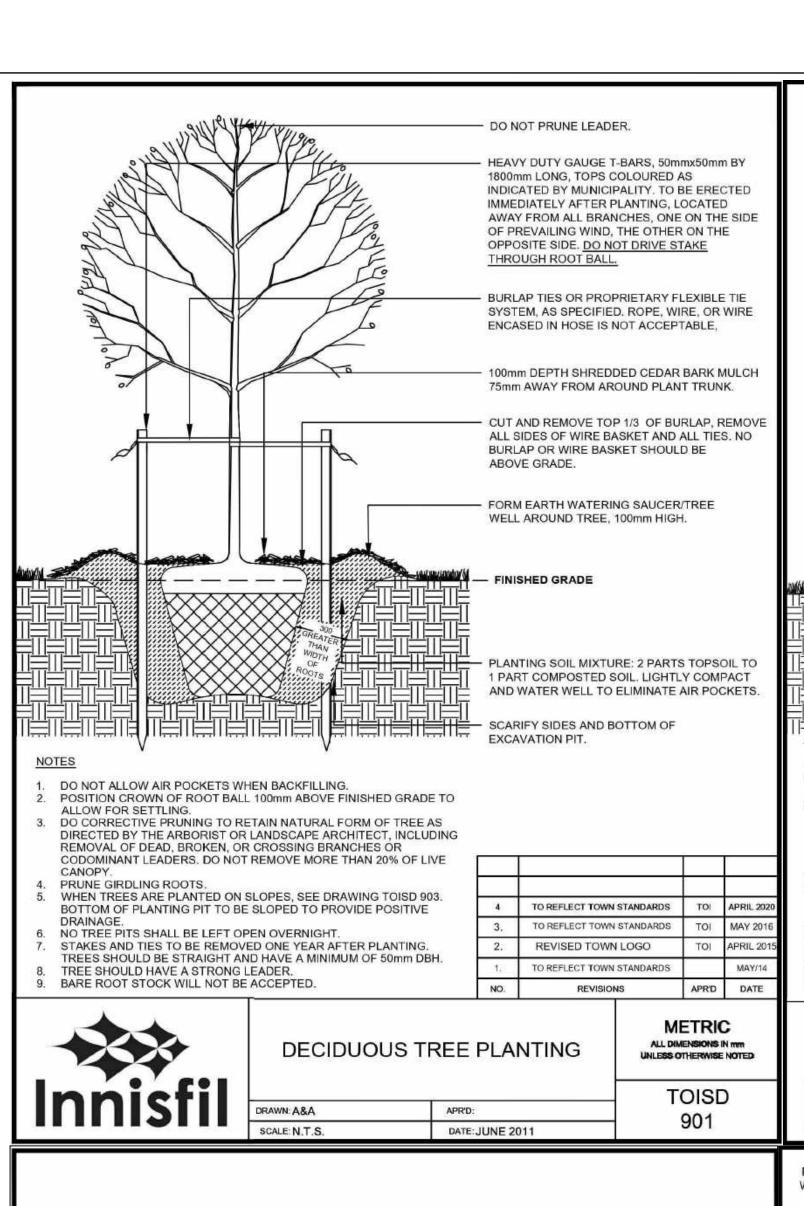
CLIENT:

PROJECT:

946-950 INNISFIL BEACH ROAD

ROCH DEVELOPMENTS

DETAI	ILS I
SCALE BAR:	
PROJECT NO.: LA 596-21	SCALE: N.T.S
MUNICIPAL FILE NO.:	DATE:
SP 2021-018	NOVEMBER 17, 202
DRAWN BY: CHECKED BY: B.B, S.K J.H	DRAWING No.:
[D.D, D.I]	



POST FOOTING DETAILS

1100

1100

1200

1100

1250

1370

STANDARD PANEL

-3.5mm Ø BOTTOM WIRE

FASTENED @ 500mm O.

GROUND LINE-

-CONCRETE 100mm BELOW GRADE

TOPS OF FOOTINGS TO BE DOMED

TOP RAIL

-FASTENERS

STEEL OR

POST FOOTING DETAILS ADJUSTED TOI APRIL 201

TOI MAY 2016

TOI APRIL 201

APR'D DATE

ALL DIMENSIONS IN mm

TOISD

405

UNLESS OTHERWISE NOTED

TO REFLECT TOWN STANDARDS

REVISED TOWN LOGO

REVISIONS

ALUMINUM @

FABRIC HEIGHT

1200

1800

CORNER PANEL

38mm WIRE MESH

100mm CLEARANCE →

ONLY REQUIRED FOR 1800mm FENCE. FIRST AND/OR CORNER PANELS TO HAVE BRACE BAR ALONG BOTTOM INSTEAD OF GUIDE WIRE.

CHAIN LINK FENCE

DATE: JUNE 2011

TOP EDGE FASTENER @ 450mm

3.6mm STEEL OR ALUMINUM

43mm O.D. BRACE BAR\*

ALL FABRIC SHALL BE 3.6mm KNUCKLED AT TOP AND BOTTOM AND ONE

ALL POST AND RAILS SHALL BE GALVANIZED STEEL "SCHEDULE 40 PIPE" CONFORMING TO CURRENT SPECIFICATIONS FOR BLACK & HOT DIPPED

ALL REQUIRED FITTINGS AND HARDWARE SHALL BE OF A SUITABLE

STEEL WIRE, HOT DIP GALVANIZED AFTER WEAVING

3) STEEL WIRE, ELECTRO GALVANIZED BEFORE WEAVING

ORDINARY USES, ASTM. DESIGNATION A 120.

ALUMINUM ALLOY OR OF A STEEL DUCTILE IRON.

END CORNER

STRAINING OR GATE POST

3.2mmx19.0mm

4.8mmx19.0mm ALUMINUM

BAR BANDS @

4.8mmx19.0mm-

OF THE FOLLOWING MATERIALS:

ASTM. SPECIFICATIONS (A 152)


FRAMES AND BRACES

FABRIC AND WIRE POST AND RAILS

CAST FITTINGS OTHER FITTINGS

STRETCHER BAR

STEEL OR

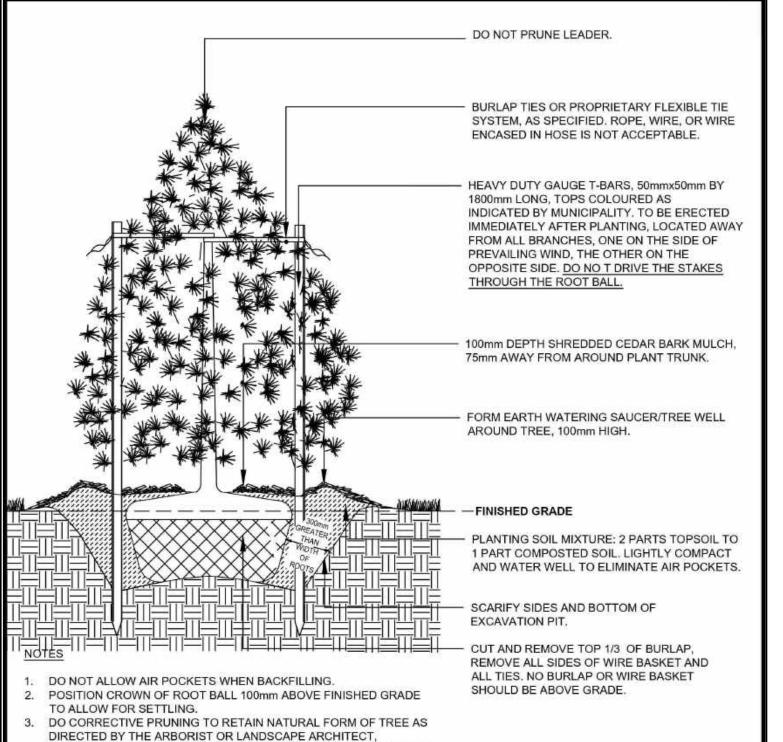


INCLUDING REMOVAL OF DEAD, BROKEN, OR CROSSING BRANCHES OR CODOMINANT LEADERS. DO NOT REMOVE MORE THAN 20% OF				
LIVE CANOPY.				
PRUNE GIRDLING ROOTS. WHEN TREES ARE PLANTED ON SLOPES, SEE DRAWING TOISD 903.		8)		
BOTTOM OF PLANTING PIT TO BE SLOPED TO PROVIDE POSITIVE DRAINAGE.	4	TO REFLECT TOWN STANDARDS	тоі	APRIL 2020
NO TREE PITS SHALL BE LEFT OPEN OVERNIGHT.	3.	TO REFLECT TOWN STANDARDS	TOI	MAY 2016
STAKES AND TIES TO BE REMOVED ONE YEAR AFTER PLANTING. TREE SHOULD BE STRAIGHT AND BE A MINIMUM OF 200mm TALL.	2.	REVISED TOWN LOGO	TOI	APRIL 2015
TREE SHOULD HAVE A STRONG LEADER.	1,	TO REFLECT TOWN STANDARDS		MAY/14
BARE ROOT STOCK WILL NOT BE ACCEPTED.	NO.	REVISIONS	APR'D	DATE

CONIFEROUS TREE PLANTING

METRIC
ALL DIMENSIONS IN mmm
UNLESS OTHERWISE NOTED

TOISD
902

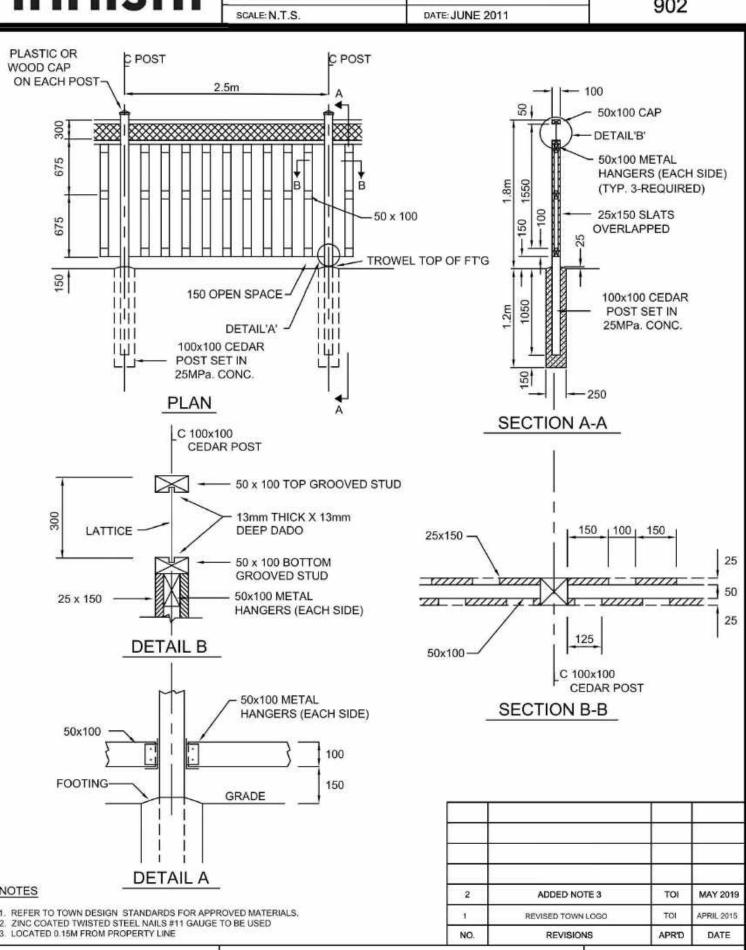

1.8m HIGH

WOOD PRIVACY FENCE

APR'D:

DATE: JUNE 2011

ALL DIMENSIONS IN mm

UNLESS OTHERWISE NOTED

TOISD

### PLANTING NOTES

I. The Contractor shall review all information in all drawings details and specifications and report any discrepancies to the Landscape Architect in writing prior to commencement of works.

2. All planting and related work shall be completed by experienced personnel under the direction and supervision of a qualified foreman.

- 3. All plant material which cannot be planted immediately will be properly heeled in or covered with a similar material which will keep root surfaces moist until planted.
  4. All plant material and operations shall meet or exceed current horticultural standards of the Canadian Nursery Trade Association and the Ontario Landscape Contractors Association. All plant material to be No. 1 Grade Nursery Stock. All
- unsatisfactory stock including field grown will be refused on site.

  5. The Landscape Architect reserves the right to reject any material, plantings and sod prior to or after installation which does not conform to approved specifications in accordance with approved details. The Contractor will be asked to remove any unapproved material which does not conform to specifications
- unless there is prior written agreement with the Landscape Architect.

  6. Trees and shrubs shall have an uncut, strong central leader, be sound, healthy, vigorous, well-branched, densely foliated, free of disease, insects and have well-developed root systems.

7. Where applicable, sod to be Canada No. I Nursery Sod, meeting Ontario Sod Growers Association Standards. All Areas to receive 200mm minimum depth of topsoil under sod unless otherwise indicated. See Drawings and Specifications for areas to be mulched.

8. The Contractor shall stake out all planting locations for approval by the Landscape Architect or Contract Administrator prior to planting. Where dimensions are not provided, the drawing may be scaled ONLY to determine approximate locations of plant material. Dimensions are in millimeters unless otherwise stated.


9. All mass plantings shall be in continuous beds with mulch as specified in planting details.


IO. All planting will be under warrantee by the Contractor for a minimum of I year. The Contractor shall water at time of planting and whenever deemed necessary to maintain trees in a healthy condition. Apply aqueous fertilizer in a ratio of IO-6-4 in accordance with manufacturers instructions. Sod, where specified, to be maintained and guaranteed until established, minimum after two mowings.

II. Unwrap or do not wrap tree trunks. Stake trees in accordance with required specifications.

I 2. Provide sufficient rodent protection on all new planting so as to deter bark or shoot damage by rodents. Significant rodent damage, as determined by the Landscape Architect will require plant replacement.

LANDMARK ENVIRONMENTAL GROUP LTD Laddcage Acceledata Censulting Acceledata

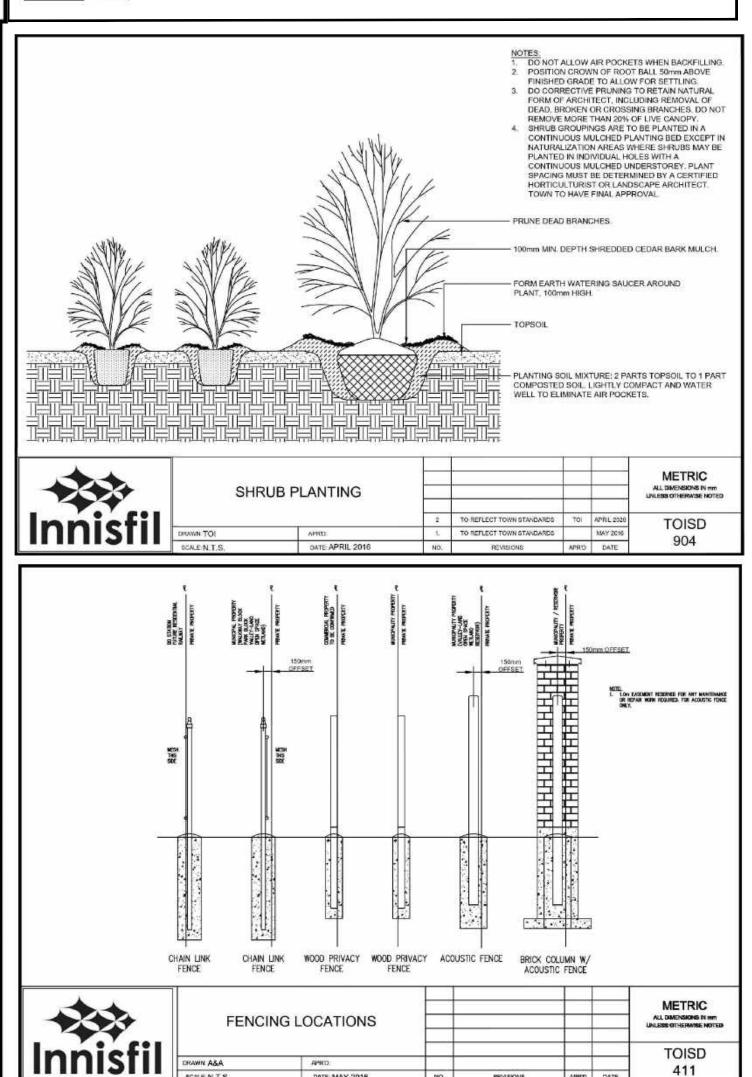

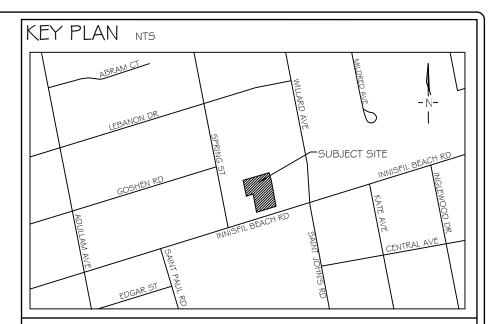

### GENERAL NOTES


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NO	DATE	BY	REVISIONS

STAM



APPROVAL

TOWN OF INNISFIL

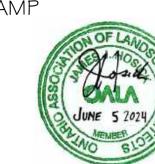NAME

ATE \_\_\_\_\_

LANDMARK
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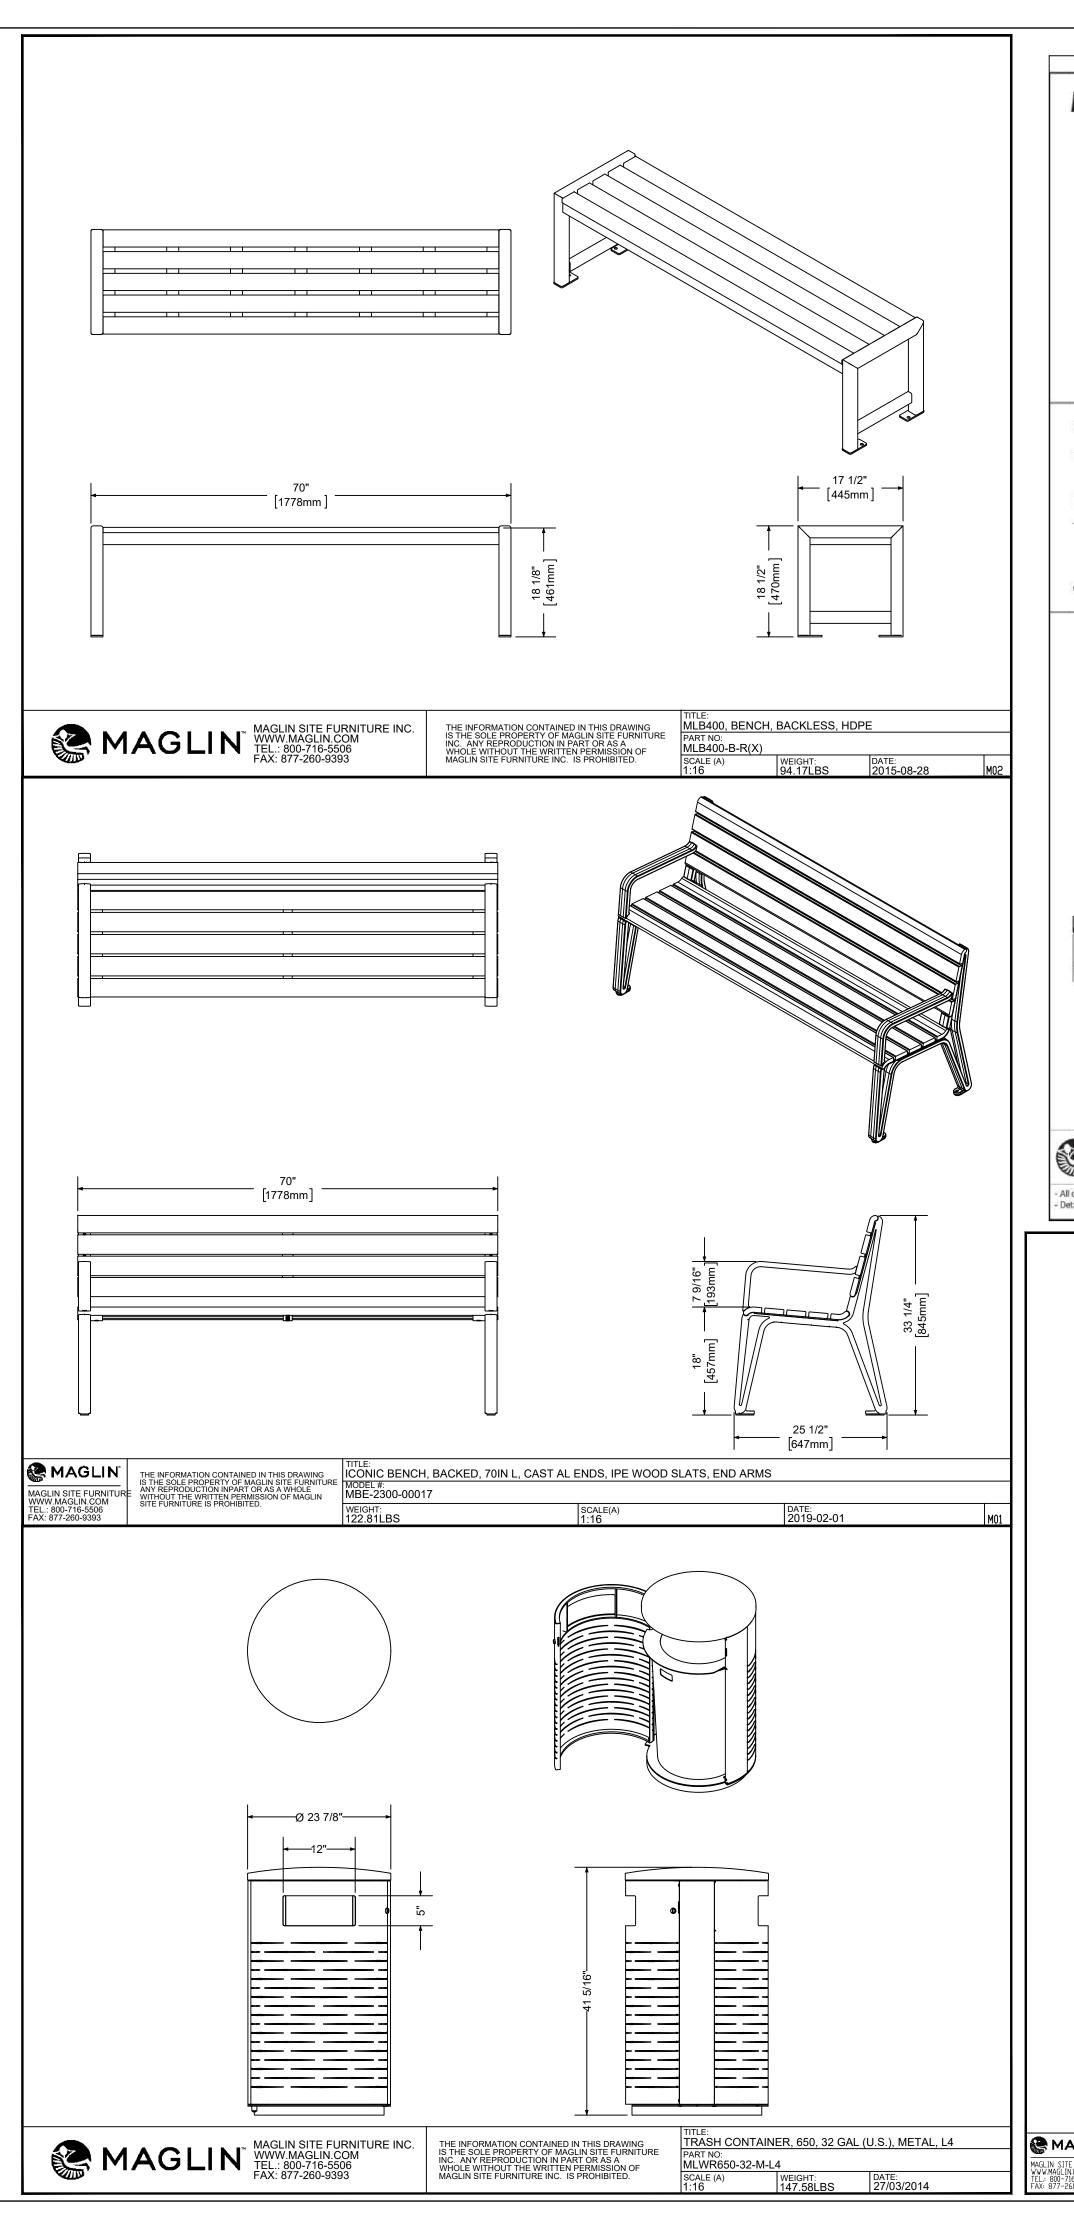
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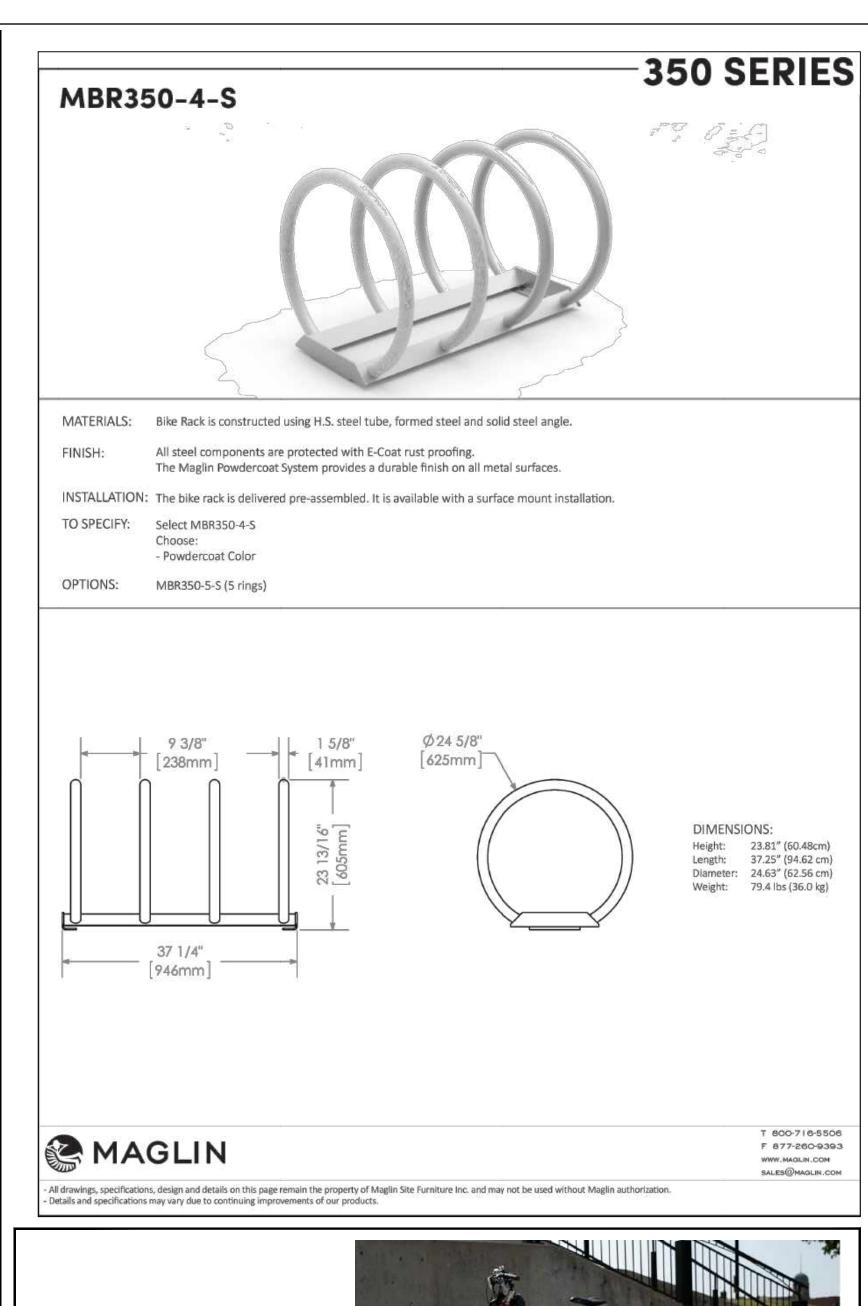
DRAWING:


DETAILS 2


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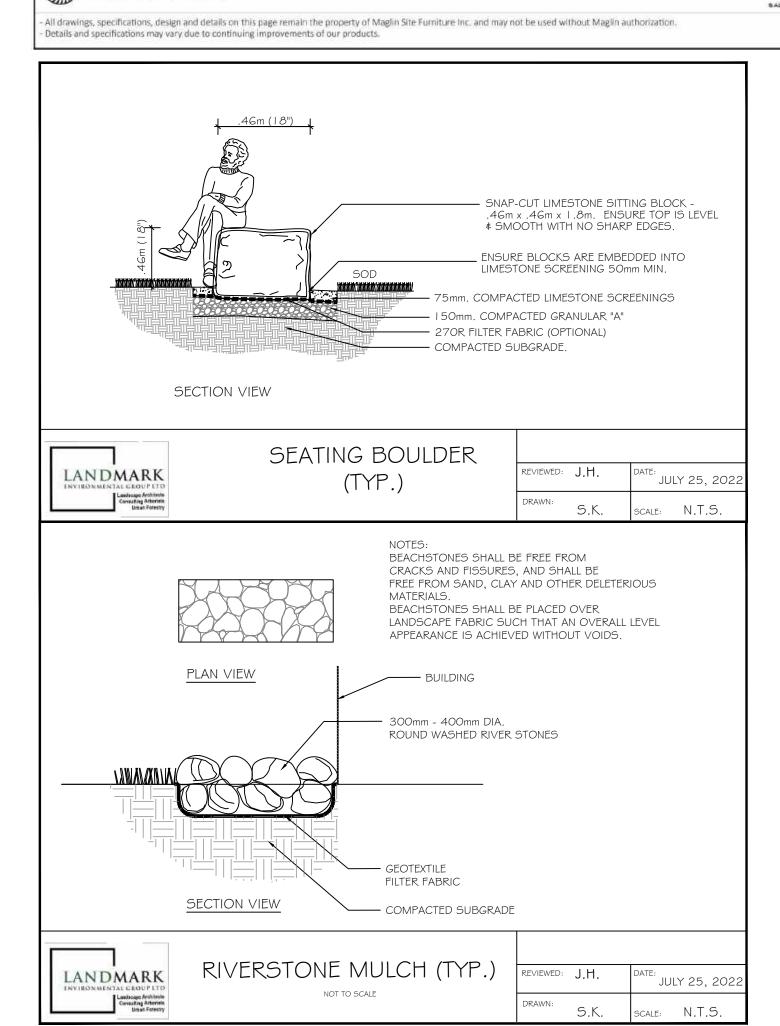
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LA 596-21	N.T.S
MUNICIPAL FILE NO.:	DATE:
SP 2021-018	NOVEMBER 17, 202
DRAWN BY: CHECKED BY:	DRAWING No.:








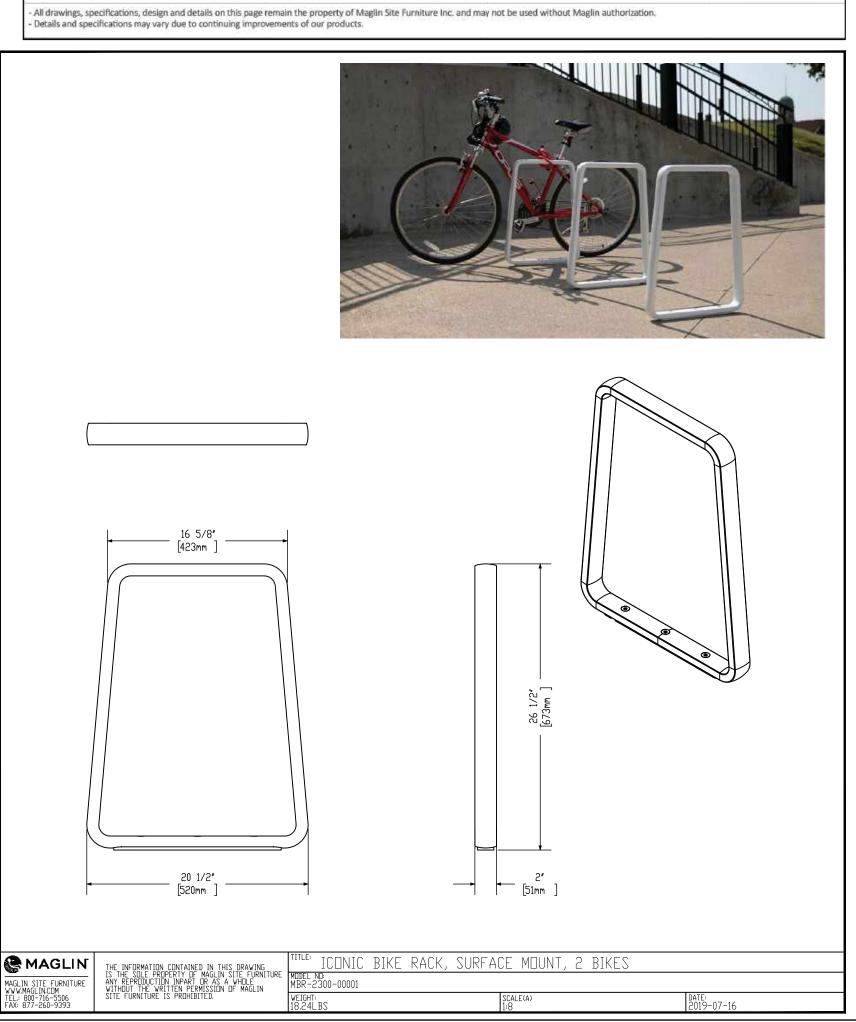

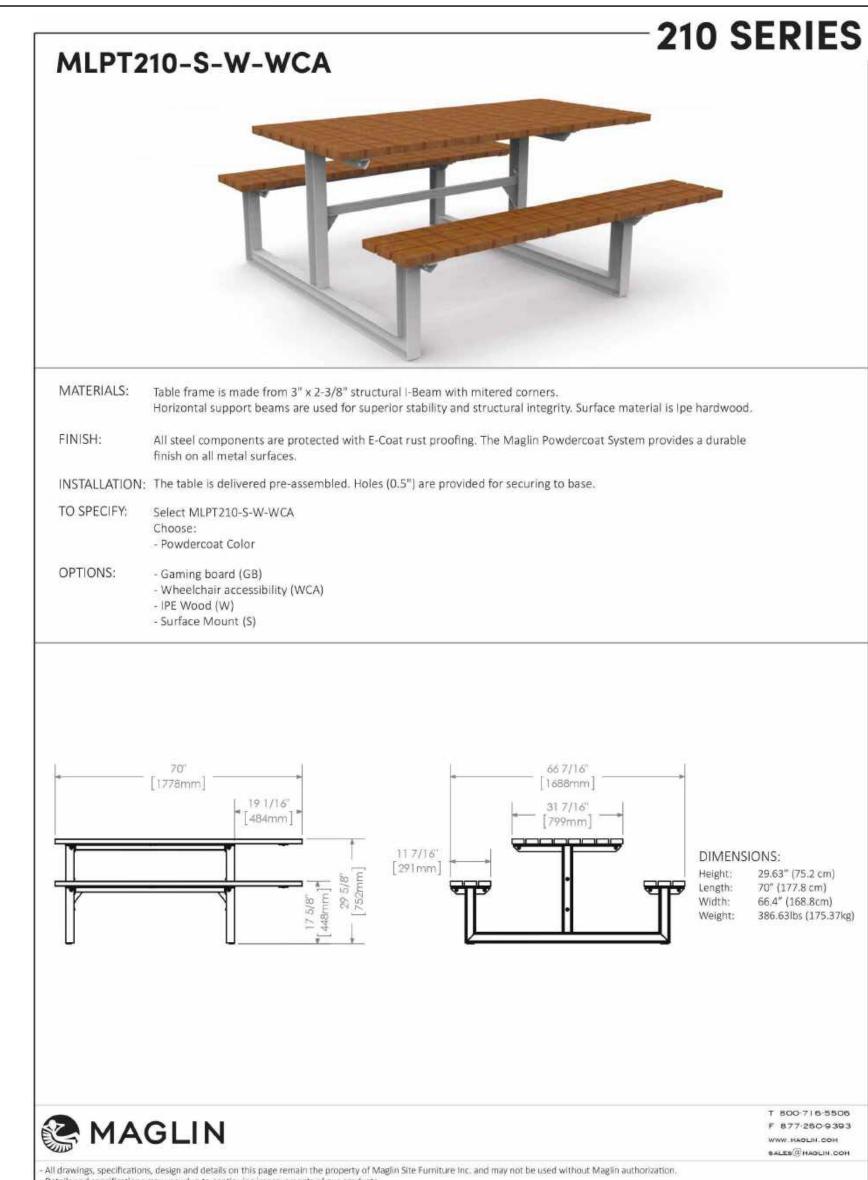

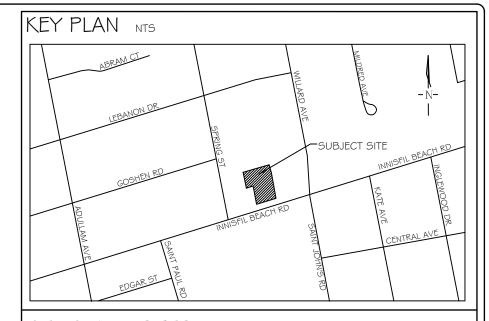

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AS PER ELECTRICAL PLAN UPDATES

AS PER SITE GRADING \$ SERVICING PLAN UPDATES

UPDATE LANDSCAPE PLAN AS PER SURVEY PLAN 4 JULY 6, 2023 AS PER SITE PLAN UPDATES JULY 22, 2022 AS PER UPDATED SITE PLAN DATE REVISIONS STAMP APPROVAL

6 AUG.25, 2023

TOWN OF INNISFIL

SIGNATURE

LANDMARK Landscape Architects
Consulting Arborists

LANDSCAPE ARCHITECTS & CONSULTING ARBORISTS OFFICE: 705-796-1122 info@LEGroupLtd.com www.LEGroupLtd.com

CLIENT:

ROCH DEVELOPMENTS

PROJECT:

946-950 INNISFIL BEACH ROAD

DRAWING:

SCALE BAR:

DETAILS 3

PROJECT NO .: LA 596-21

N.T.S

SCALE:

MUNICIPAL FILE NO. NOVEMBER 17, 202 SP 2021-018 DRAWN BY: CHECKED BY: DRAWING No.: LD-3