



COMMITTEE OF ADJUSTMENT NOTICE OF PUBLIC HEARING APPLICATION NO. A-2025-040 & A-2025-048

TAKE NOTICE that an application has been received by the Town of Innisfil from **John Savio**, **Owner**, for a minor variance from Zoning By-law 080-13, pursuant to Section 45 of the *Planning Act*, R.S.O. 1990, c. P.13, as amended.

The subject properties are described legally as PLAN 51M1069 LOT 3 known municipally as 1208 Gilford Rd and is zoned "Residential Estate Exception 6 (RE-6) and Environmental Protection Exception 13 (EP-13)".

The applicant is seeking relief of section 3.3b) of the Zoning By-law which allows a maximum gross floor area of an accessory building or structure of up to 50m2. The applicant is proposing to construct a detached garage with a gross floor area of approximately 80m2. Also seeking relief from section 3.3f) which states that no accessory building shall exceed the height of the principal building on the lot or 5.0m, whichever is the lesser. The proposed height of the garage is approximately 5.4m.

The Committee of Adjustment for the Town of Innisfil will consider this application in person at Town Hall and virtually through Zoom on **Thursday**, **September 18**, **2025**, at **6:30 PM**.

To participate in the hearing and/or provide comments, you must register by following the link below or scanning the above QR code:

https://innisfil.ca/en/building-anddevelopment/committee-of-adjustmenthearings.aspx

Requests can also be submitted in writing to: Town of Innisfil Committee of Adjustment, 2101 Innisfil Beach Road, Innisfil, Ontario, L9S 1A1 or by email to planning@innisfil.ca.

If you wish to receive a copy of the decision of the Committee of Adjustment in respect of the proposed consent, you must make a written request to the Secretary-Treasurer of the Committee of Adjustment by way of email or regular mail. The Notice of Decision will also explain the process for appealing a decision to the Ontario Land Tribunal (OLT).




Additional information relating to the proposed application is available on the Town of Innisfil website. Accessible formats are available on request, to support participation in all aspects of the feedback process. To request an alternate format please contact Planning Services at planning@innisfil.ca.


Dated: **August 28, 2025**Sarah Burton Hopkins

Secretary Treasurer

sburtonhopkins@innisfil.ca 705-436-3710 ext. 3504

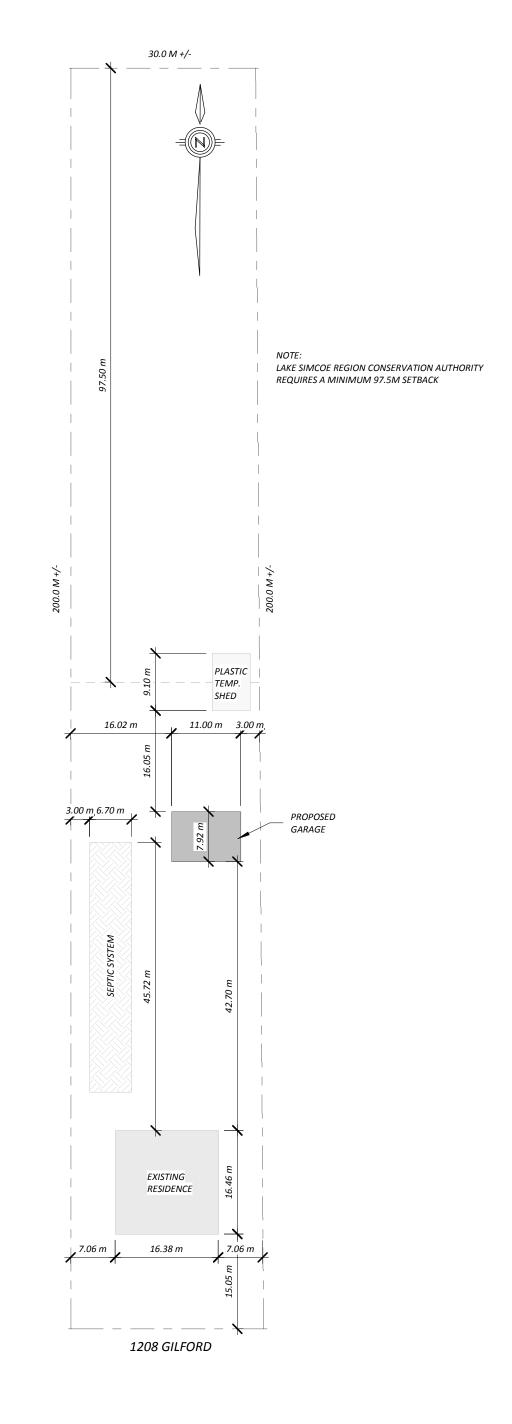


Project.: Address:	1208	8 Gilford Ro	d, Gilford	Drawing Title: Location	Revision:	Prawing No.:
Drawn By:	J.S.	Scale: 1" = 50'-0"	July 2025	Simcoe County	Project No.:	2023-11

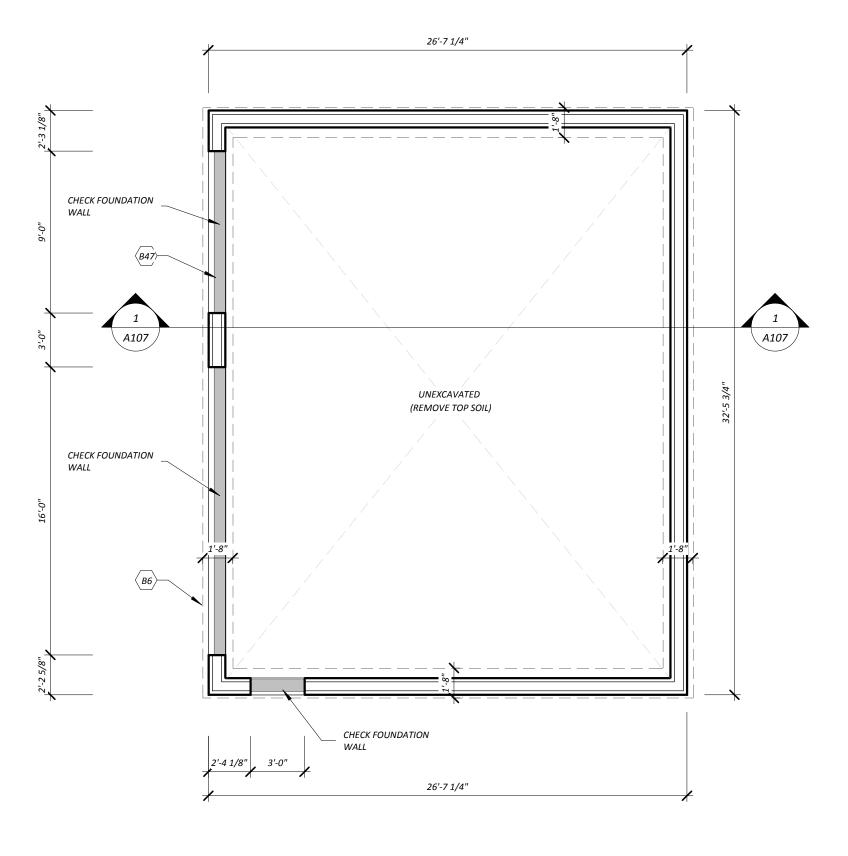


1 Foundation Plan 3/16" = 1'-0"

Project.: Address:	1208	Gilford Roa	ad, Gilford	Prawing Title: Foundation Plan		A 100
Drawn By:	J.S.	Scale: 3/16" = 1'-0"	July 2025	Simcoe County	Project No.:	2023-11

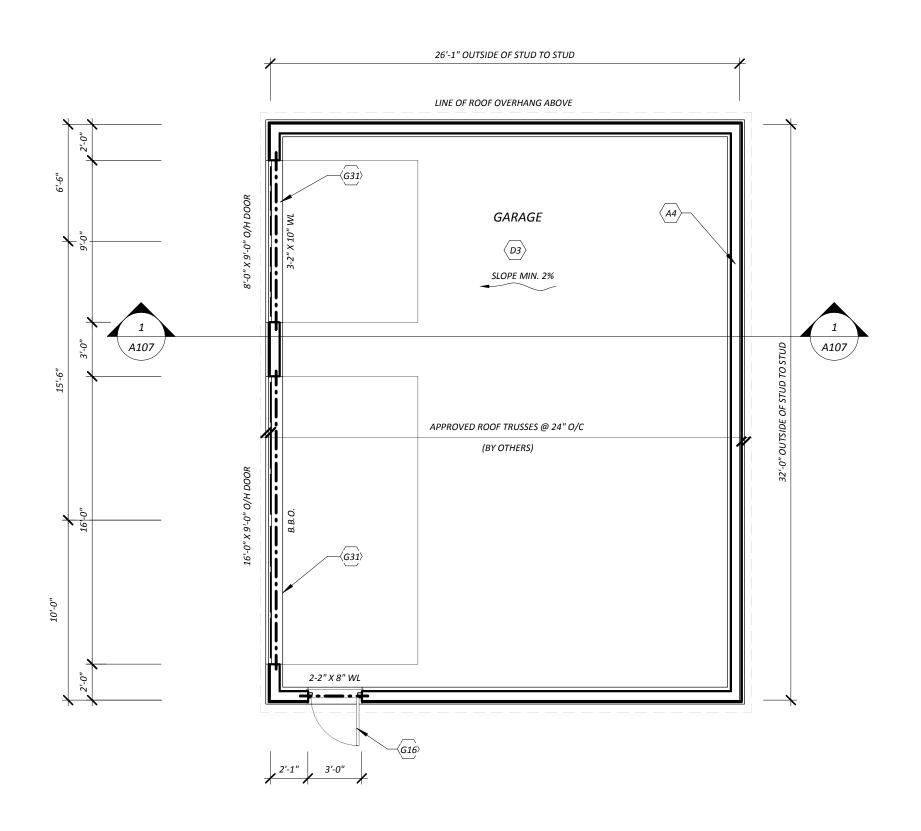

1 Garage Floor Plan
3/16" = 1'-0"

Project.: Address:	1208	Gilford Roa	nd, Gilford	Drawing Title: Plan	Revision:	A 101
Drawn By:	J.S.	Scale: 3/16" = 1'-0"	July 2025	Simcoe County	Project No.:	2023-11

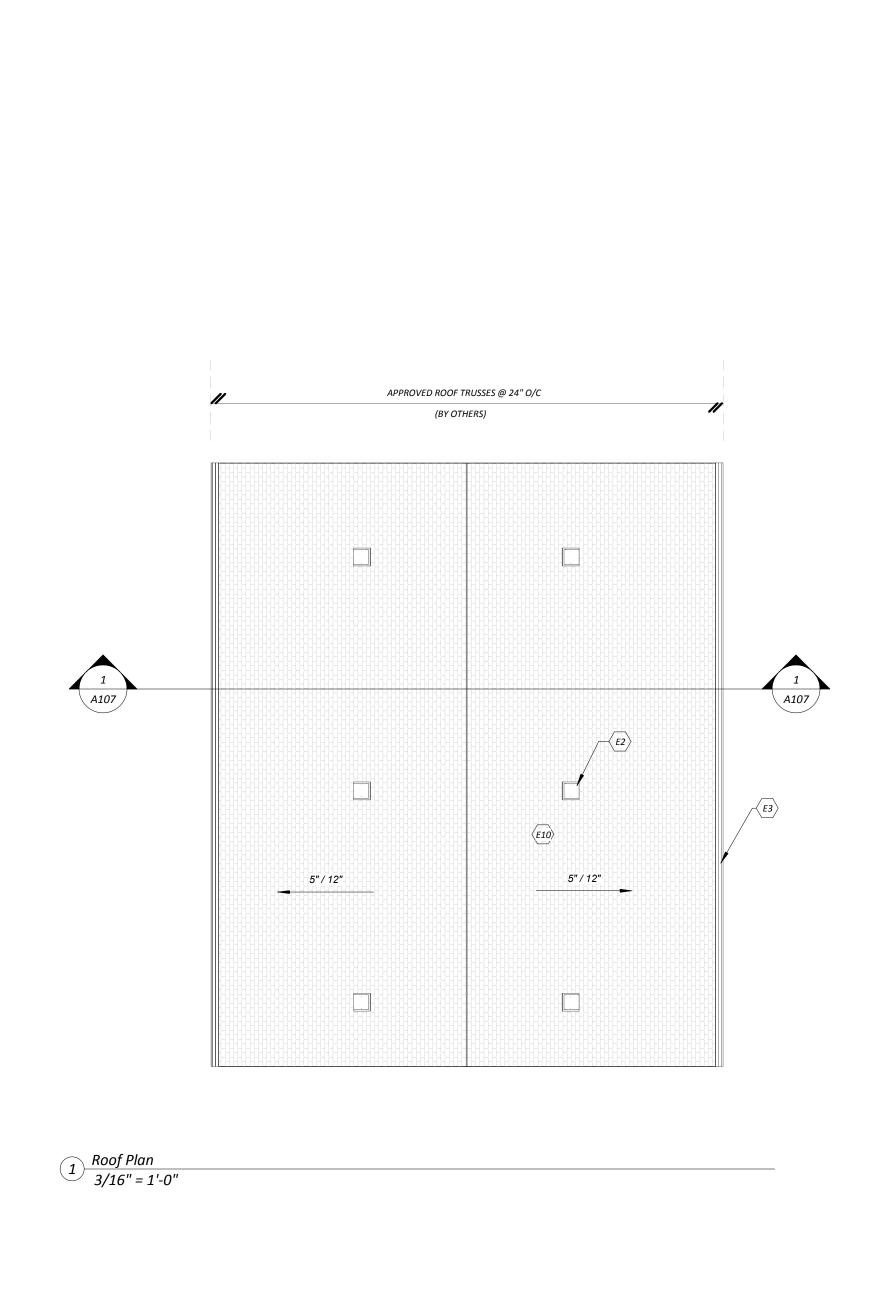


Project.:

1208 Gilford Road, Gilford
Roof Plan

Drawing Title:
Revision:
A 102

Drawing No.:
A 102

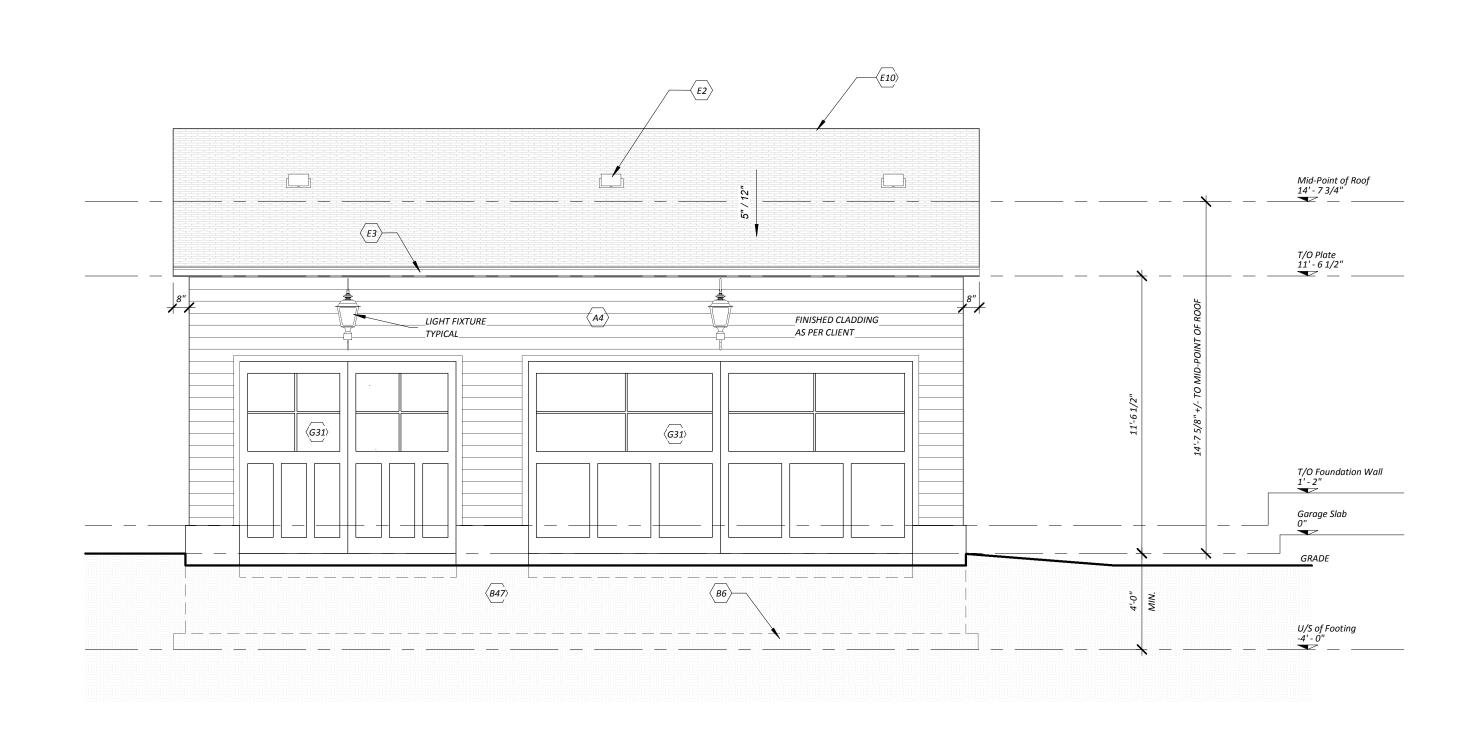

1 Front Elevation 1/4" = 1'-0"

Project:

1208 Gilford Road, Gilford

Address:

Drawn By:

J.S.

Scale:

14" = 1'-0"

July 2025

Drawn G Title:

Front Elevation

Front Elevation

Front Elevation

Front Elevation

Front Elevation


July 2025

Since County

Drawing No.:


Project No.:

A 103

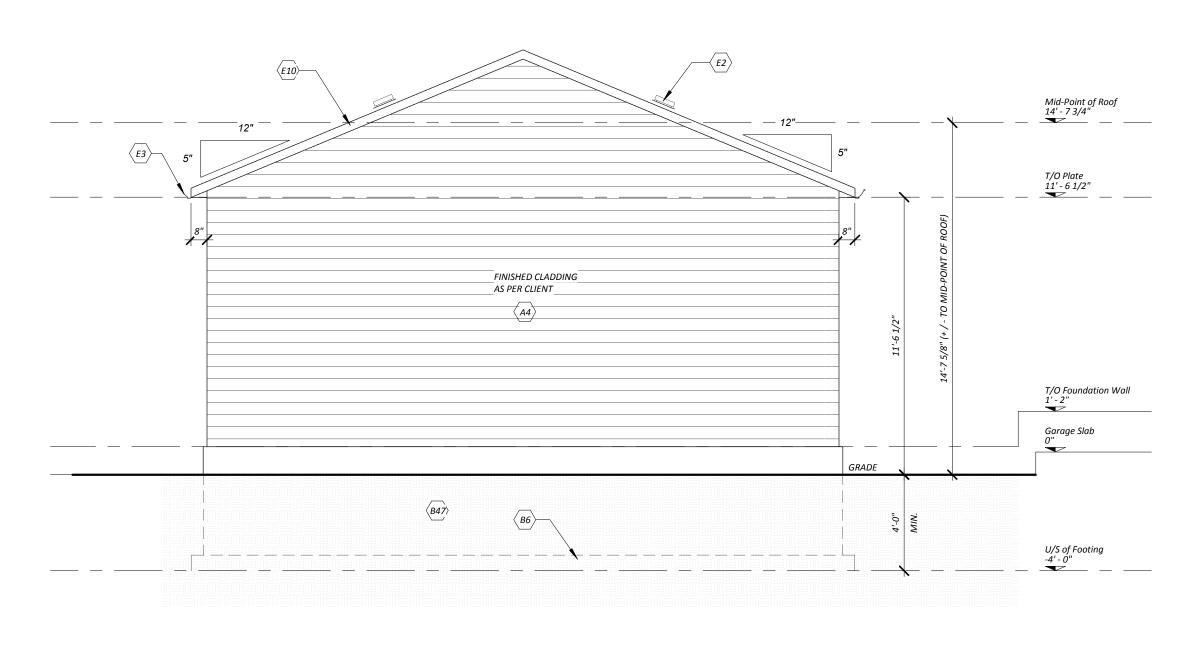

1 Left Side Elevation 1/4" = 1'-0"

Project.:				Drawing Title:	Revision:	Project No.:	Drawing No.:
	1208	Gilford Ro	ad, Gilford	Left Side Elevation			
						2023-11	A104
Address:							A 1 U4
Drawn By:	J.S.	Scale: 1/4" = 1'-0"	July 2025	Simcoe County			

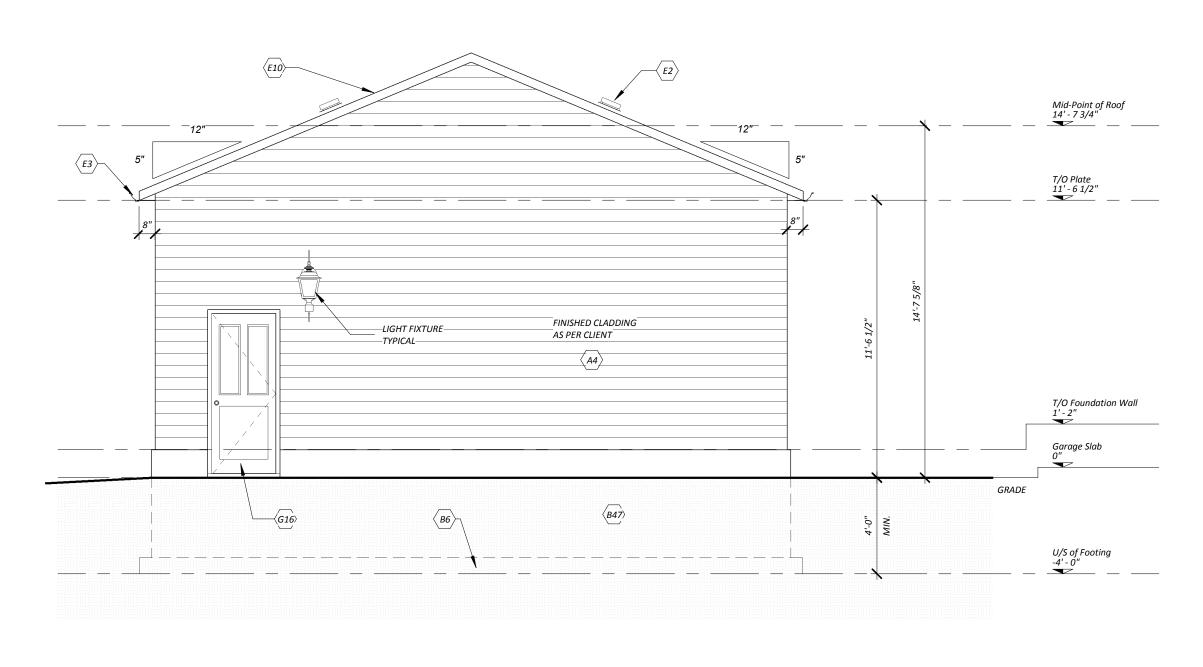

Right Side Elevation
1/4" = 1'-0"

Project.:


1208 Gilford Road, Gilford

Revision:

Address:


2023-11

A 105

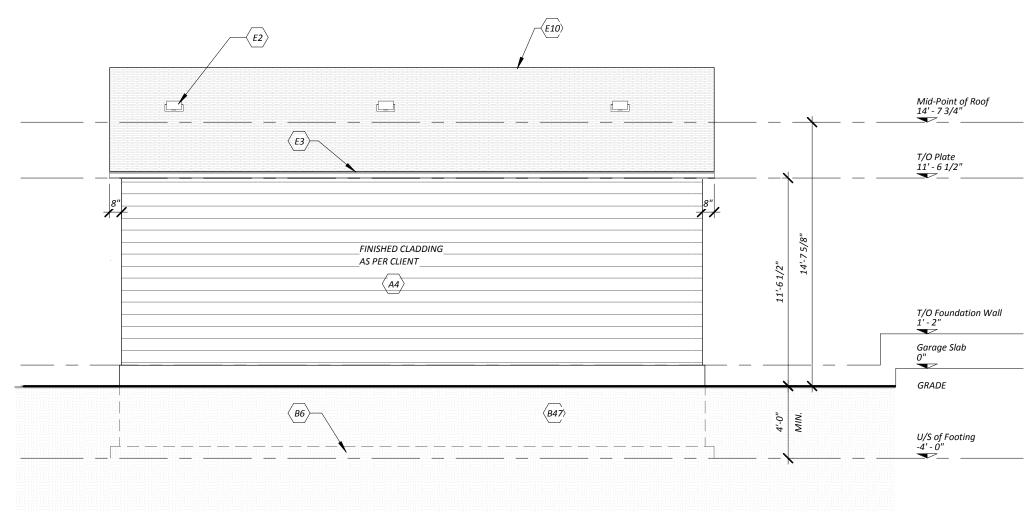

1 Rear Elevation 3/16" = 1'-0"

Drawing Title: Revision: Project No.: Drawing No.: Project.: 1208 Gilford Road, Gilford Rear Elevation 2023-11 A106 Address: Simcoe County 3/16" = 1'-0" July 2025

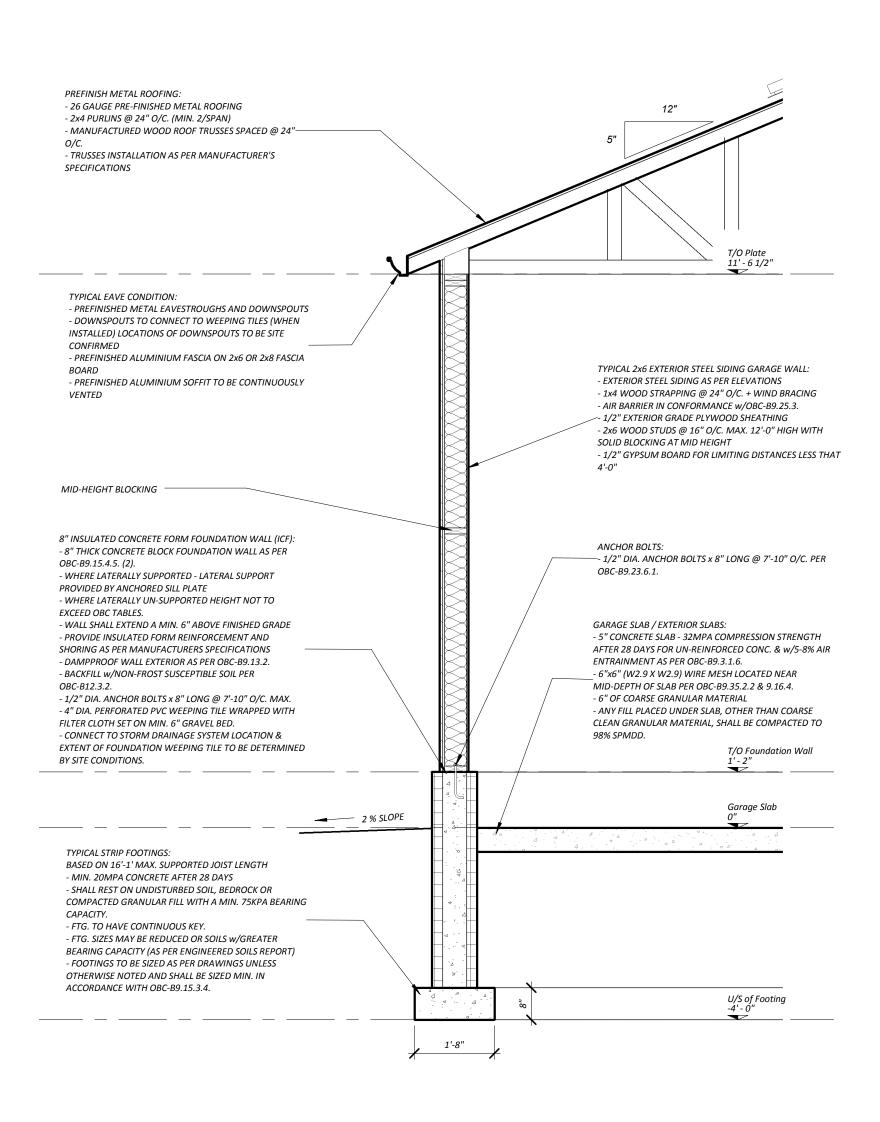

1208 Gilford Road, Gilford

Typical Wall Section

Project.:

Typical Wall Section

Project No.: Drawing No.:


Address:

Drawing Title:

Typical Wall Section

Project No.: 2023-11

Typical Wall Section.
1/2" = 1'-0"

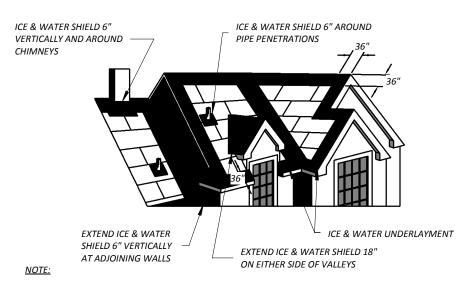

ICE & WATER UNDERLAYMENT SHOULD BE INSTALLED AS SHOWN AT ALL ROOF EDGES, EAVES, RAKES, VALLEYS, HIPS, UNVENTILATED RIDGES AND AROUND ALL PENETRATIONS SUCH AS CHIMNEYS AND VENT PIPES.


ALL WORK SHALL BE EXECUTED IN ACCORDANCE WITH THE ONTARIO BUILDING CODE LATEST EDITION THEREOF AND IN ACCORDANCE WITH MANUFACTURERS RECOMMENDATIONS AND INSTALLATION INSTRUCTIONS.



Drawn By:

Eaves Protection


NTS

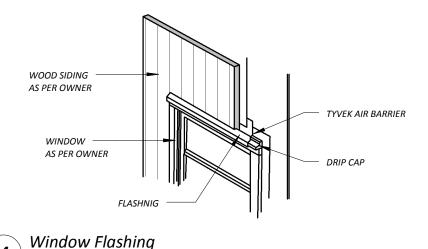

As indicated

July 2025

Simcoe County

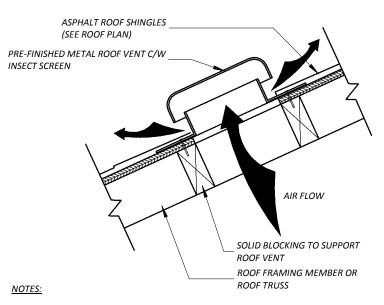

- 1. REFER TO ROOF PLAN FOR LOCATION AND QUANTITY OF ROOF VENTS.
- 2. INSTALLATION TO BE COMPLETED IN ACCORDANCE WITH ONTARIO BUILDING CODE OBC 9.19.1.2 AND IN ACCORDANCE WITH THE MANUFACTURERS SPECIFICATIONS.
- 3. VENTS SHALL BE DESIGNED TO PREVENT THE ENTRY OF RAIN, SNOW AND INSECTS.
- 4. COLOUR TO MATCH ROOFING.




G31

Roof Vent Detail

16' - 0"

8' - 0"

N.T.S.

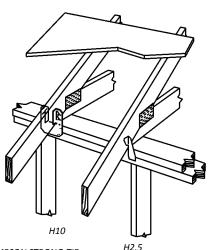

SIMPSON STRONG-TIE

TRUSS AND RAFTER CONNECTIONS TO WOOD TOP PLATES



Truss Connection Detail

NTS

			Door Schedule	
				Finish
Door Number	Width	Height	Description	Comments
•				
G21	3' - 0"	7' - 0"	Exterior Man Door	Colour and style as per client
G31	9' - 0"	8' - 0"	Overhead Garage Door	Colour and style as per client

Colour and style as per client

Overhead Garage Door

Project.:		Drawing Title:	Revision:	Project No.:	Drawing No.:
	1208 Gilford Road, Gilford	Details & Door Schedule			
				2023-11	1100
Address	:		1	2020 11	A 1 0 9

WOOD FRAMING:

ALL FRAMING LUMBER TO OBC STANDARDS SIZES OF JOISTS, LINTELS, ETC. INDICATED ON DRAWINGS, SPECIFIED AS PER NO.2 OR BETTER (UNLESS NOTED OTHERWISE).

BEAMS TO HAVE A MINIMUM 3 1/2" END BEARING.

LATERAL SUPPORT - (WALLS SUPPORTING JOISTS) - ANCHOR SILL PLATE AT 6'-7" O/C WITH 1/2" DIA. ANCHOR BOLTS EMBEDDED MIN. 4" INTO MASONRY OR CONCRETE OR ANCHORED EVERY 4TH JOIST NOT RESTING ON A PLATE WITH 3/16"X1 1/2" STEEL JOIST ANCHORS (N.B. -NOT REQUIRED IF FOUNDATION WALL SUPPORTS SOLID MASONRY).

LATERAL SUPPORT - (WALLS PARALLEL TO JOISTS) BEND 3/16"X1 1/2" STEEL STRAP 3" INTO MASONRY AND FIX SILL PLATE (ANCHORED) TO 3 RIGIDLY CONNECTED FLOOR JOISTS AT 6'-7" O/C MAXIMUM.

ALL JOISTS TO HAVE BRIDGING OVER INTERIOR BEARING WALLS AND BEAMS.

MINIMUM SILL PLATE 2"X4"

SILL PLATE ANCHORS TO BE MINIMUM 1/2" DIA. BOLTS EMBEDDED MINIMUM 4" INTO FOUNDATION WALLS, MAX. SPACING OF 6'-7".

HEADER JOISTS TO BE DOUBLED IF OVER 2'-8" AND NOT OVER 10'-8".

TRIMMER JOISTS TO BE DOUBLED IF OVER 2'-8" AND NOT OVER 6'-7" O/C.

SPACE FLOOR JOISTS AT 12" O/C CANTILEVERS

DOUBLE JOISTS UNDER ALL PARALLEL PARTITIONS

TRIPLE JOISTS UNDER ALL PARALLEL BEARING PARTITIONS.

MINIMUM 1 1/2" END BEARING REQUIRED FOR SUPPORT FOR JOISTS, CEILING JOISTS, ROOF JOISTS AND RAFTERS.

PROVIDE METAL - JOIST HANGERS FOR SUPPORT OF JOISTS FRAMING ONTO SIDES OF WOOD BEAMS. TRIMMER AND HEADERS WHEN REQUIRED. ALL CONCEALED SPACES TO BE FIRE STOPPED BETWEEN STOREYS AT FLOOR, CEILING, ROOFS

AND AT STAIRS. WOOD STUD PARTITIONS TO BE MADE UP OF 2"X4" SPRUCE 16" O/C AND 2"X4" TOP AND

BOTTOM PLATES (DOUBLE TOP PLATE IN BEARING STUD). USE 2"X4" STUDS AT 12" O/C FOR GROUND FLOOR OF 3 STOREY STRUCTURES. DOUBLE STUDS AROUND OPENINGS AND TRIPLE STUDS IN CORNERS IN BEARING STUD PARTITIONS.

ROOF CONSTRUCTION:

PROVIDE EAVES PROTECTION WITH SELF SEALING COMPOSITE MEMBRANES OF "ICE AND WATERSHIED". PROTECTION MUST EXTEND 3'-0" FROM THE ROOF EDGE UP THE SLOPE AND A MINIMUM OF 12" FROM INSIDE FACE OF EXTERIOR WALL.

STARTER STRIP, ROLL ROOFING OR ROOF SHINGLES OF SAME WEIGHT AND QUALITY AS USED ON ROOF LAID WITH TARS FACING UP.

HIP AND VALLEY RAFTERS TO BE 2" DEEPER THAN COMMON RAFTERS.

ROOF SHEATHING 1/2" OSB STRAND BOARD OR PLYWOOD IF EDGES UNSUPPORTED 2'-0" SPACING OF SUPPORTS OR 3/8" OSB OR PLYWOOD WITH "H" CLIPS 2'-0" O/C SPACING OF SLIPPORTS

ROOF EDGE SUPPORTS TO BE 2"X2" BLOCKING MIN.

1/8" = 1'-0"

TRUSS BRACING AND BRIDGING PROVIDE 1"X4" CONTINUOUS AT EACH 2"X4" WALL TIES. PROVIDE 2"X4" BRACES AND BRIDGING FOR ROOF SLOPES GREATER THAN 4/12.

ROOF DRAINAGE:

ROOF WATER FROM UPPER ROOF LEVEL MUST BE PIPED DIRECTLY TO LOWER LEVEL.

FLASHING:

Address: Drawn By: FLASHING IS REQUIRED UNDER ALL JOINTED SILLS AND OVERHEADS OF WINDOWS AND DOORS IN EXTERIOR WALLS IF DISTANCES BELOW EAVES IN MORE THAN 1/4 ROOF OVERHANG.

FLASHING REQUIRED AT INTERSECTION OF ROOFS, WALL AND VALLEY'S.

FLASHING BETWEEN ROOF SHINGLES AND WALL SIDING 20 GAUGE GALVANIZED METAL 3"

July 2025

Simcoe County

PROVIDE STEP FLASHING BETWEEN VERTICAL WALL AND ADJACENT ROOF SURFACES.

NATURAL VENTILATION:

INSULATION SHALL BE INSTALLED AND OTHER CONSTRUCTION WORK UNDERTAKEN IN A MANNER WHICH WILL NOT REDUCE THE FLOW OF AIR THROUGH VENTS OR THROUGH ANY PORTION OF THE ROOF SPACE OR ATTIC WHERE NECESSARY TO ENSURE EFFECTIVE AIR CIRCULATION SPECIAL VENTING DEVICES SUCH AS DUCTS OR BAFFLES SHALL BE INSTALLED

ROOF SPACES OR ATTICS ABOVE INSULATED CEILINGS SHALL BE VENTILATED WITH OPENINGS TO THE EXTERIOR HAVING A TOTAL UNOBSTRUCTED AREA OF NOT LESS THAN 1/300 OF THE INSULATED CEILING AREA (OF WHICH 1/2 TO BE LOCATED IN SOFFIT). SUCH VENTS SHALL BE LOCATED SO AS TO PROVIDE MAXIMUM EFFECTIVE AIR CIRCULATION AND IN RIDGE TYPE ROOFS APPROXIMATELY HALF OF THE TOTAL VENT AREA SHALL BE LOCATED AT OR NEAR THE RIDGE.

GENERAL NOTES / SPECIFICATIONS:

1. THESE WORKING DRAWINGS ARE PROVIDED TO MAKE THE FULL DETAILS OF THE BUILDING OR STRUCTURE SHOWN. THEY MAY ALSO BE USED AS DOCUMENTS FOR CONSTRUCTION. ALL NOTES AND DIMENSIONS ARE SUBJECT TO CHANGE ACCORDING TO THE ARCHITECTURAL DRAWINGS, OWNER, LOCAL BUILDING OFFICAL, APPLICABLE CODES, BUILDING REQUIREMENTS AND SITE CONDITIONS. THESE DRAWINGS ARE TO BE CHECKED BY THE CUSTOMER, OWNER AND / OR CONTRACTOR(S) INCLUDING COORDINATION OF THESE AGAINST ANY OTHER CONSTRUCTION DOCUMENTS. ANY FRRORS OR OMISSIONS MUST BE REPORTED IN WRITING TO THE DESIGNER PRIOR COMMENCEMENT OF CONSTRUCTION.

2. THESE DRAWINGS ARE NOT TO BE SCALED.

3. ALL WORK SHALL BE DONE IN ACCORDANCE WITH THE ONTARIO BUILDING CODE, ONTARIO ELECTRICAL CODE, AND ONTARIO FIRE CODE LATEST EDITIONS THEREOF.

4. THE WORK SHALL ALSO BE IN ACCORDANCE WITH ALL LOCAL CODES, AUTHORITIES HAVING JURISDICTION AND WITH ANY OWNER REQUIREMENTS NOT SPECIFICALLY COVERED.

5. THE CONTRACTOR SHALL COORDINATE WITH ALL TRADES INCLUDING SUBCONTRACTORS TO ENSURE NO CONFLICTS AND TO ENSURE EFFICIENT COMPLETION OF THE WORK.

6. EVERY ATTEMPT HAS BEEN MADE FOR COMPLETENESS HOWEVER IT IS CONTRACTORS RESPONSIBILITY TO CONFIRM SITE CONDITIONS AND FIELD CONSTRUCTION.

PROJECT GEOTECHNICAL REPORT:

1.) NO GEOTECHNICAL REPORT HAS BEEN PROVIDED FOR THIS DESIGN. THE DESIGN IS BASED ON TYPICAL SOILS CONDITIONS WITHIN THE GEOGRAPHIC AREA.

Keynote Leaend

Key Value	Keynote Text
·	
Α	EXTERIOR WALL ASSEMBLIES:
A4	TYPICAL 2x6 EXTERIOR STEEL SIDING GARAGE WALL:
	- EXTERIOR STEEL SIDING AS PER ELEVATIONS
	- 1x4 WOOD STRAPPING @ 24" O/C. + WIND BRACING
	- AIR BARRIER IN CONFORMANCE w/OBC-B9.25.3.
	- 1/2" EXTERIOR GRADE PLYWOOD SHEATHING
	- 2x6 WOOD STUDS @ 16" O/C. MAX. 12'-0" HIGH WITH SOLID BLOCKING AT MID
	HEIGHT
	- 1/2" GYPSUM BOARD FOR LIMITING DISTANCES LESS THAT 4'-0"
В	FOUNDATION
В6	TYPICAL STRIP FOOTINGS:
	BASED ON 16'-1' MAX. SUPPORTED JOIST LENGTH
	- MIN. 20MPA CONCRETE AFTER 28 DAYS
	- SHALL REST ON UNDISTURBED SOIL, BEDROCK OR COMPACTED GRANULAR FILL
	WITH A MIN. 75KPA BEARING CAPACITY.
	- FTG. TO HAVE CONTINUOUS KEY.
	- FTG. SIZES MAY BE REDUCED OR SOILS W/GREATER BEARING CAPACITY (AS PER
	ENGINEERED SOILS REPORT)
	- FOOTINGS TO BE SIZED AS PER DRAWINGS UNLESS OTHERWISE NOTED AND
	SHALL BE SIZED MIN. IN ACCORDANCE WITH OBC-B9.15.3.4.

	Keynote Legend
Key Value	Keynote Text

B47	8" INSULATED CONCRETE FORM FOUNDATION WALL (ICF): - 8" THICK CONCRETE BLOCK FOUNDATION WALL AS PER OBC-B9.15.4.5. (2). - WHERE LATERALLY SUPPORTED - LATERAL SUPPORT PROVIDED BY ANCHORED
	SILL PLATE
	- WHERE LATERALLY UN-SUPPORTED HEIGHT NOT TO EXCEED OBC TABLES.
	- WALL SHALL EXTEND A MIN. 6" ABOVE FINISHED GRADE
	- PROVIDE INSULATED FORM REINFORCEMENT AND SHORING AS PER MANUFACTURERS SPECIFICATIONS
	- DAMPPROOF WALL EXTERIOR AS PER OBC-B9.13.2.
	- BACKFILL w/NON-FROST SUSCEPTIBLE SOIL PER OBC-B12.3.2.
	- 1/2" DIA. ANCHOR BOLTS x 8" LONG @ 7'-10" O/C. MAX.
	- 4" DIA. PERFORATED PVC WEEPING TILE WRAPPED WITH FILTER CLOTH SET OF
	MIN. 6" GRAVEL BED.
	- CONNECT TO STORM DRAINAGE SYSTEM LOCATION & EXTENT OF FOUNDATIO WEEPING TILE TO BE DETERMINED BY SITE CONDITIONS.
С	INTERIOR WALL ASSEMBLIES:
D	FLOOR ASSEMBLIES:
D3	GARAGE SLAB / EXTERIOR SLABS:
	- 5" CONCRETE SLAB - 32MPA COMPRESSION STRENGTH AFTER 28 DAYS FOR UN-REINFORCED CONC. & w/5-8% AIR ENTRAINMENT AS PER OBC-B9.3.1.6.
	- 6"x6" (W2.9 X W2.9) WIRE MESH LOCATED NEAR MID-DEPTH OF SLAB PER
	OBC-B9.35.2.2 & 9.16.4.
	- 6" OF COARSE GRANULAR MATERIAL
	- ANY FILL PLACED UNDER SLAB, OTHER THAN COARSE CLEAN GRANULAR
	MATERIAL, SHALL BE COMPACTED TO 98% SPMDD.
E	ROOF ASSEMBLIES:
E2	ROOF VENTILATION: - PROVIDE PREFINISHED ROOF VENTS IN ACCORDANCE WITH OBC-B9.19.1.2.
E3	TYPICAL EAVE CONDITION:
	- PREFINISHED METAL EAVESTROUGHS AND DOWNSPOUTS
	- DOWNSPOUTS TO CONNECT TO WEEPING TILES (WHEN INSTALLED) LOCATION OF DOWNSPOUTS TO BE SITE CONFIRMED
	- PREFINISHED ALUMINIUM FASCIA ON 2x6 OR 2x8 FASCIA BOARD
	- PREFINISHED ALUMINIUM SOFFIT TO BE CONTINUOUSLY VENTED
E10	PREFINISH METAL ROOFING:
	- 26 GAUGE PRE-FINISHED METAL ROOFING
	- 2x4 PURLINS @ 24" O/C. (MIN. 2/SPAN)
	- MANUFACTURED WOOD ROOF TRUSSES SPACED @ 24" O/C.
	- TRUSSES INSTALLATION AS PER MANUFACTURER'S SPECIFICATIONS
F	INSULATION:
G	MISCELLANEOUS ITEMS:
G16	GARAGE ENTRY DOOR: - ENTRY DOOR PRODUCT, COLOUR AND MANUFACTURER TO BE SPECIFIED BY
	OWNER.
	- REFER TO BUILDING ELEVATION AND SCHEDULE FOR DOOR TYPE.
G26	ANCHOR BOLTS:
	- 1/2" DIA. ANCHOR BOLTS x 8" LONG @ 7'-10" O/C. PER OBC-B9.23.6.1.
G31	HINGED OVERHEAD GARAGE DOOR:
	- DOOR PRODUCT, COLOUR AND MANUFACTURER TO BE SPECIFIED BY OWNER.
	- REFER TO BUILDING ELEVATION AND SCHEDULE FOR DOOR TYPE.

L				
	Project.:	Drawing Title:	Revision:	Project N
	1208 Gilford Road, Gilford	General Notes & Keynotes		
	,			202

|2023-11| **A110**

My lot is not wide enough to place the said garage beside the house.
The garage cannot be at the very back of my property because of a Simcoe county restriction.
There is a continuous continuous at the constraint of the account.

There is a septic system on the west side of the property.

The existing two car garage is 18 by 18 feet with stairs leading into the house in one bay, making it inadequate.

I prefer not to have a driveway as the garage will be used for storage and traffic to and from the garage will be limited

I'd like to be able to store my vintage vehicle, boat, trailer, motorcycles, and tractor in a garage on my property.

I prefer not to have a driveway as the garage will be used for storage and traffic to and from the garage will be limited.

Best Regards,